TO TOP OF TRUSS AS SHOWN.

TYPICAL HEADER NAILING: 0.131X3" TOE NAILS

9" LVL, 11" LVL, 2x10, 2x12 = (7) NAILS

DROPPED HEAD-

EQUALLY SPACED SOLE PLATE ANCHORS BETWEEN:

WINDOWS < 4'-4" - (1) ANCHOR

WINDOWS < 8'-4" - (2) ANCHORS

WINDOWS <12'-4" - (3) ANCHORS

2X6, 2x8 = (5) NAILS +

ROUGH DROPPED HEAD OPENING OR SILL PLATES MINIMUM FASTENER E.E.

| ≤ 6'-4" | (2)2x4 SPF #2 |(1)A34 + (2)12d TOE NAILS

 $\leq 8'-4" \mid (3)2\times4 \text{ SYP } \#2 \mid (1)A34 + (6)12d \text{ TOE NAILS} \mid$

 $| \le 12' - 0" |$ (3)2x6 SYP #2 | (2)A35 + (6)12d TOE NAILS

ROUGH OPENING, PER PLAN

FOUNDATION, SEE PLAN

1. USE SPF#2 OR BETTER FOR ALL WALLS.

TYPICAL WALL FRAMING

2. ALL WALL'S SHALL BE **BALLOON FRAMED** FULL HEIGHT TO ROOF OR FLOOR BEARING ELEVATION, U.O.N. ON PLAN.

SILL PLATES+

| ≤ 4'-4" | (1)2x4 SPF #2 | (4)12d TOE NAILS

14" LVL, 14" LVL = (9) NAILS

PROVIDE 2x4 BLOCKING

AT HORIZONTAL JOINTS.

<u>HEEL ≥ 1'-0"</u>

IF HIGH SIDE OF WALL

DBL. 2x BLOCKING IN

JACK AND KING STUDS,

PER HEADER SCHEDULE

−IS A SHEARWALL, INSTALL

FIRST (2) STUDS SPACES

ROOF TRUSS CONNECTION

TYPICAL STUD NAILING: 0.131x3" END NAILS:

6"MAX. 6"MAX

FASTEN ROOF TRUSS

ENOUGH TO ENGAGE

IS A SHEARWALL -

INSTALL ADDITIONAL

FULL HT ANCHORS.

IF HIGH SIDE OF

WALL IS A

SHEARWALL

FASTEN (2

INSIDE FACE

OF SHEARWALL

OR BEND AROUND

NON-SHEARWALL.

MSTA36 AT

ENDS AT

w/ UPLIFT CONN. LONG

IF HIGH SIDE OF WALL

(2) @ 2x4, (3) @ 2x6, (4) @ 2x8.

FACH FND WITH 2-10

OENAILS. ONLY REQUIRED

SHEATHING JOINTS FOR

EXTERIOR WALLS AND

FLOOR SHEATHING:

PLYWOOD SHEATHING.

GLUE & NAIL w/ 10d

COMMON @ 6" O.C.

EDGE AND FIELD

SEE 3/S0.0-

-Interior bearing Wall: See Plan

AND O.C. SPACING.

BLOCKING AT ALL SHEATHING JOINTS:

EACH END WITH 2-10

OENAILS. ONLY REQUIRED

AT SHEATHING JOINTS FOR

EXTERIOR WALLS AND

SEE DETAILS

MULTY STORY

TYP. WALL SECTIONS

SHEARWALLS

SHEARWALLS

OSB **OR** PLYWOOD

FIELD. FOR WALLS w/

TO THE WALL STUDS

WALL SHEATHING SPECIFICATIONS:

OSB **OR** PLYWOOD

FIELD. FOR WALLS w/

TO THE WALL STUDS

STUCCO FINISH, INSTALL

7/16" STRUCTURAL 1 APA

RATED SHEATHING (32/16

SPAN RATING) w/ THE LONG

DIMENSION PÉRPÉNDICULAR

WALL SHEATHING TO SOLE PLATE RAISE 1/4" FROM BOTTOM OF

SOLE PLAN AND FASTEN w/8d @

MIN. ⁷/₁₆", 24/16, STRUCTURAL 1 APA RATED

SHEATHING, FASTENED w/8d

@ 6" O.C. EDGE AND 6" O.C.

STUCCO FINISH, INSTALL

7/16" STRUCTURAL 1 APA RATED SHEATHING (32/16

SPAN RATING) w/ THE LONG

DIMENSION PERPENDICULAR

SHEATHING, FASTENED w/8d

@ 6" O.C. EDGE AND 6" O.C.

NTERIOR BEARING WALL:

CONTINUOUS BLOCKING

L _ _ _ .

AND O.C. SPACING.

-SEE 2/S0.0

BLOCKING AT ALL /SHEATHING JOINTS:

TOENAILS. ONLY

WALLS AND

SINGLE STORY

SHEARWALLS


EACH END WITH 2-10d

REQUIRED AT SHEATHING

SEE DETAILS

ON S1.0

JOINTS FOR EXTERIOR

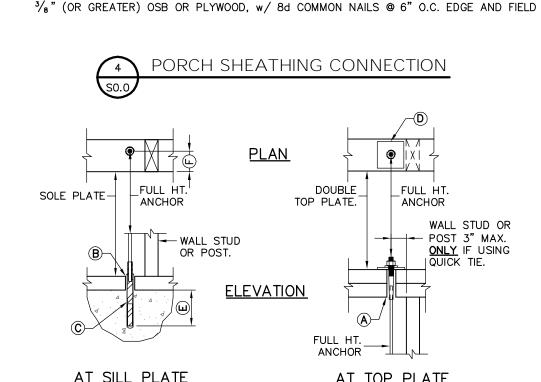

🛂 GYPSUM (WATER PROOF) GREEN BOARD, w/ 5d COOLER NAILS @ 6" O.C. EDGE & FIELD

PORCH SHEATHING SPECIFICATIONS:

<u>PARALLEL</u>

TYPICAL TOP PLATE NAILING: FASTEN ALL TOP PLATES

OF .131x3 @ 12" O.C. STAGGARD.

TOGETHER w/ (3) ROWS

WALL SHEATHING

TYPICAL SOLE PLATE NAILING:

(3) @ 2x4, (4) @ 2x6, (5) @ 2x8.

8" 1/2" FROM SOLE
MAX. MIN. PLATE BREAK

-0.131x3" TOE NAILS:

FULL HEIGHT ANCHORING

SYSTEM, PER PLAN

 $1/_2$ "ø x 6" LG (MIN $3\frac{1}{2}$ " EMBED.) THREADED ROD ANCHOR BOLT

DRILLED & EPOXY w/ 2"ø x $\frac{1}{8}$ "

PLATE WASHER OR FULL HT


<u>PERPENDICULAR</u>

TYPICAL LAP SPLICE:

SYP#2 HEADER,

PER"PLANS


FLOOR TRUSS AT WALL FRAMING

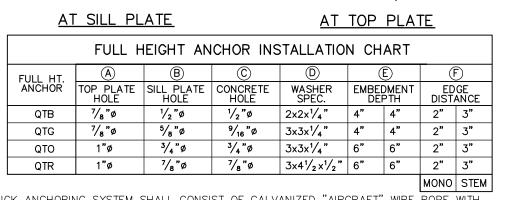

THE QUICK ANCHORING SYSTEM SHALL CONSIST OF GALVANIZED "AIRCRAFT" WIRE ROPE WITH THREADED STUD SWEDGES EACH END AS MANUFACTURED BY QUICK TIE PRODUCTS, INC. JACKSONVILLE FLORIDA. QUICK TIES SHALL BE ORIENTED VERTICALLY AND ATTACHED TO THE FOUNDATION AND TO THE UPPERMOST PLATE. QUICK TIES ARE TO BE INSTALLED AS INDICATED ON PLAN.

 $^3\!\!/_{16}$ "Ø (QTB), $^4\!\!/_{18}$ "Ø (QTG), $^4\!\!/_{16}$ "Ø (QTR) & SHALL HAVE A MINIMUM ALLOWABLE CAPACITIES OF 1909#, 2839#, 4455#, & AND 6545#, RESPECTIVELY. QT WIRE ROPE SHALL BE PRE-TENSIONED TO ELIMINATË THE CONSTRUCTIONAL STRETCH AND RELAXATION INHERENT TO ALL HELICALLY—LAID WIRES AND STRANDS. THE PRETENSIONING FORCES REQUIRED AT INSTALLATION SHALL BE AS RECOMMENDED BY QUICK-TIE PRODUCTS IN ORDER TO YIELD A RESIDUAL TENSION EQUAL TO THE ABOVE NOTED

QUICK TIE INSTALLATION REQUIREMENTS: ALL QUICK TIE ANCHORAGE SHALL BE INSTALLED BY A FACTORY TRAINED AND LICENSED INSTALLER. QUICK TIE MUST BE TENSIONED ACCORDING TO THE DIMENSION INDICATED ON TAG ON EACH QUICK TIE AND INSTALLED ACCORDING TO MANUFACTURERS INSTALLATIONS INCLUDED_IN EVERY BOX OF QUICK TIES. QUICK TIE ANCHORING SYSTEM

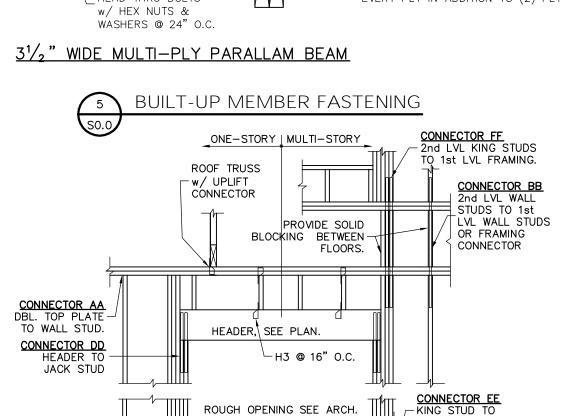

	T Y P E	CONNECTOR AA	CONNECTOR BB	CONNECTOR CC	CONNECTOR <u>DD</u>	CONNECTOR EE	CONNECTOR FE
		DBL TOP PLATE TO WALL STUD	2ND LEVEL STUDS TO 1ST LEVEL STUDS	1ST LEVEL STUDS TO SILL PLATE	HEADER TO JACK STUD	KING STUD TO FOUNDATION	2ND LEVEL KING STUDS TO 1ST LEVEL FRAMING
	A	LSTA12 @ 32"	CS20 @ 32"	SP1 @ 16"	MSTA24 < 6'	LTT20B < 6'	CS20 < 6'
					(2)MSTA24 < 12'	HTT16 < 12'	(2)CS20 < 12'
	В	LSTA12 @ 16"	CS20 @ 32"	SP1 @ 16"	MSTA24 < 4'	LTT20B < 4'	CS20 < 4'
					(2)MSTA24 < 9'	HTT16 < 9'	(2)CS20 < 8'
	С	H6 @ 16"	CS20 @ 16"	LTT20B @ 32" ·	MSTA24 < 3'	LTT20B < 3'	CS20 < 3'
					(2)MSTA24 < 6'	HTT16 < 6'	(2)CS20 < 6'
	D	H6+H2.5T @ 16"	CS16 @ 16"	LTT20B @ 16"	MSTA24 < 3'	LTT20B < 3'	CS16 < 3'
					(2)MSTA24 < 6'	HTT16 < 6'	(2)CS16 < 6'

FOUNDATION.

CONNECTOR CO

CONVENTIONAL STRAPPING DETAIL



Lou Pontigo and Associates, Inc.

420 Osceola Avenue Jax. Beach, Florida 32250 Ph. 242-0908 Fax. 241-9557 FL: CA # 8344 SC: CA# 3579 CONTACT US WITH YOUR COMMENT COMMENTS @ LP-A.COM

REVISIONS

FIFLD ALTERATION ONTRACTOR SHALL CONTACT LO ONTIGO & ASSOCIATES PRIOR TO MAKING ANY STRUCTURAL FIELD ODIFICATIONS WHICH MAY VAR ROM THE INTENT OF THE ORIGINA NSTRUCTION DOCUMENTS. AN D ALTERNATIONS MADE PRIOR ASSOCIATES MAY RESULT IN INSPECTION FEES.


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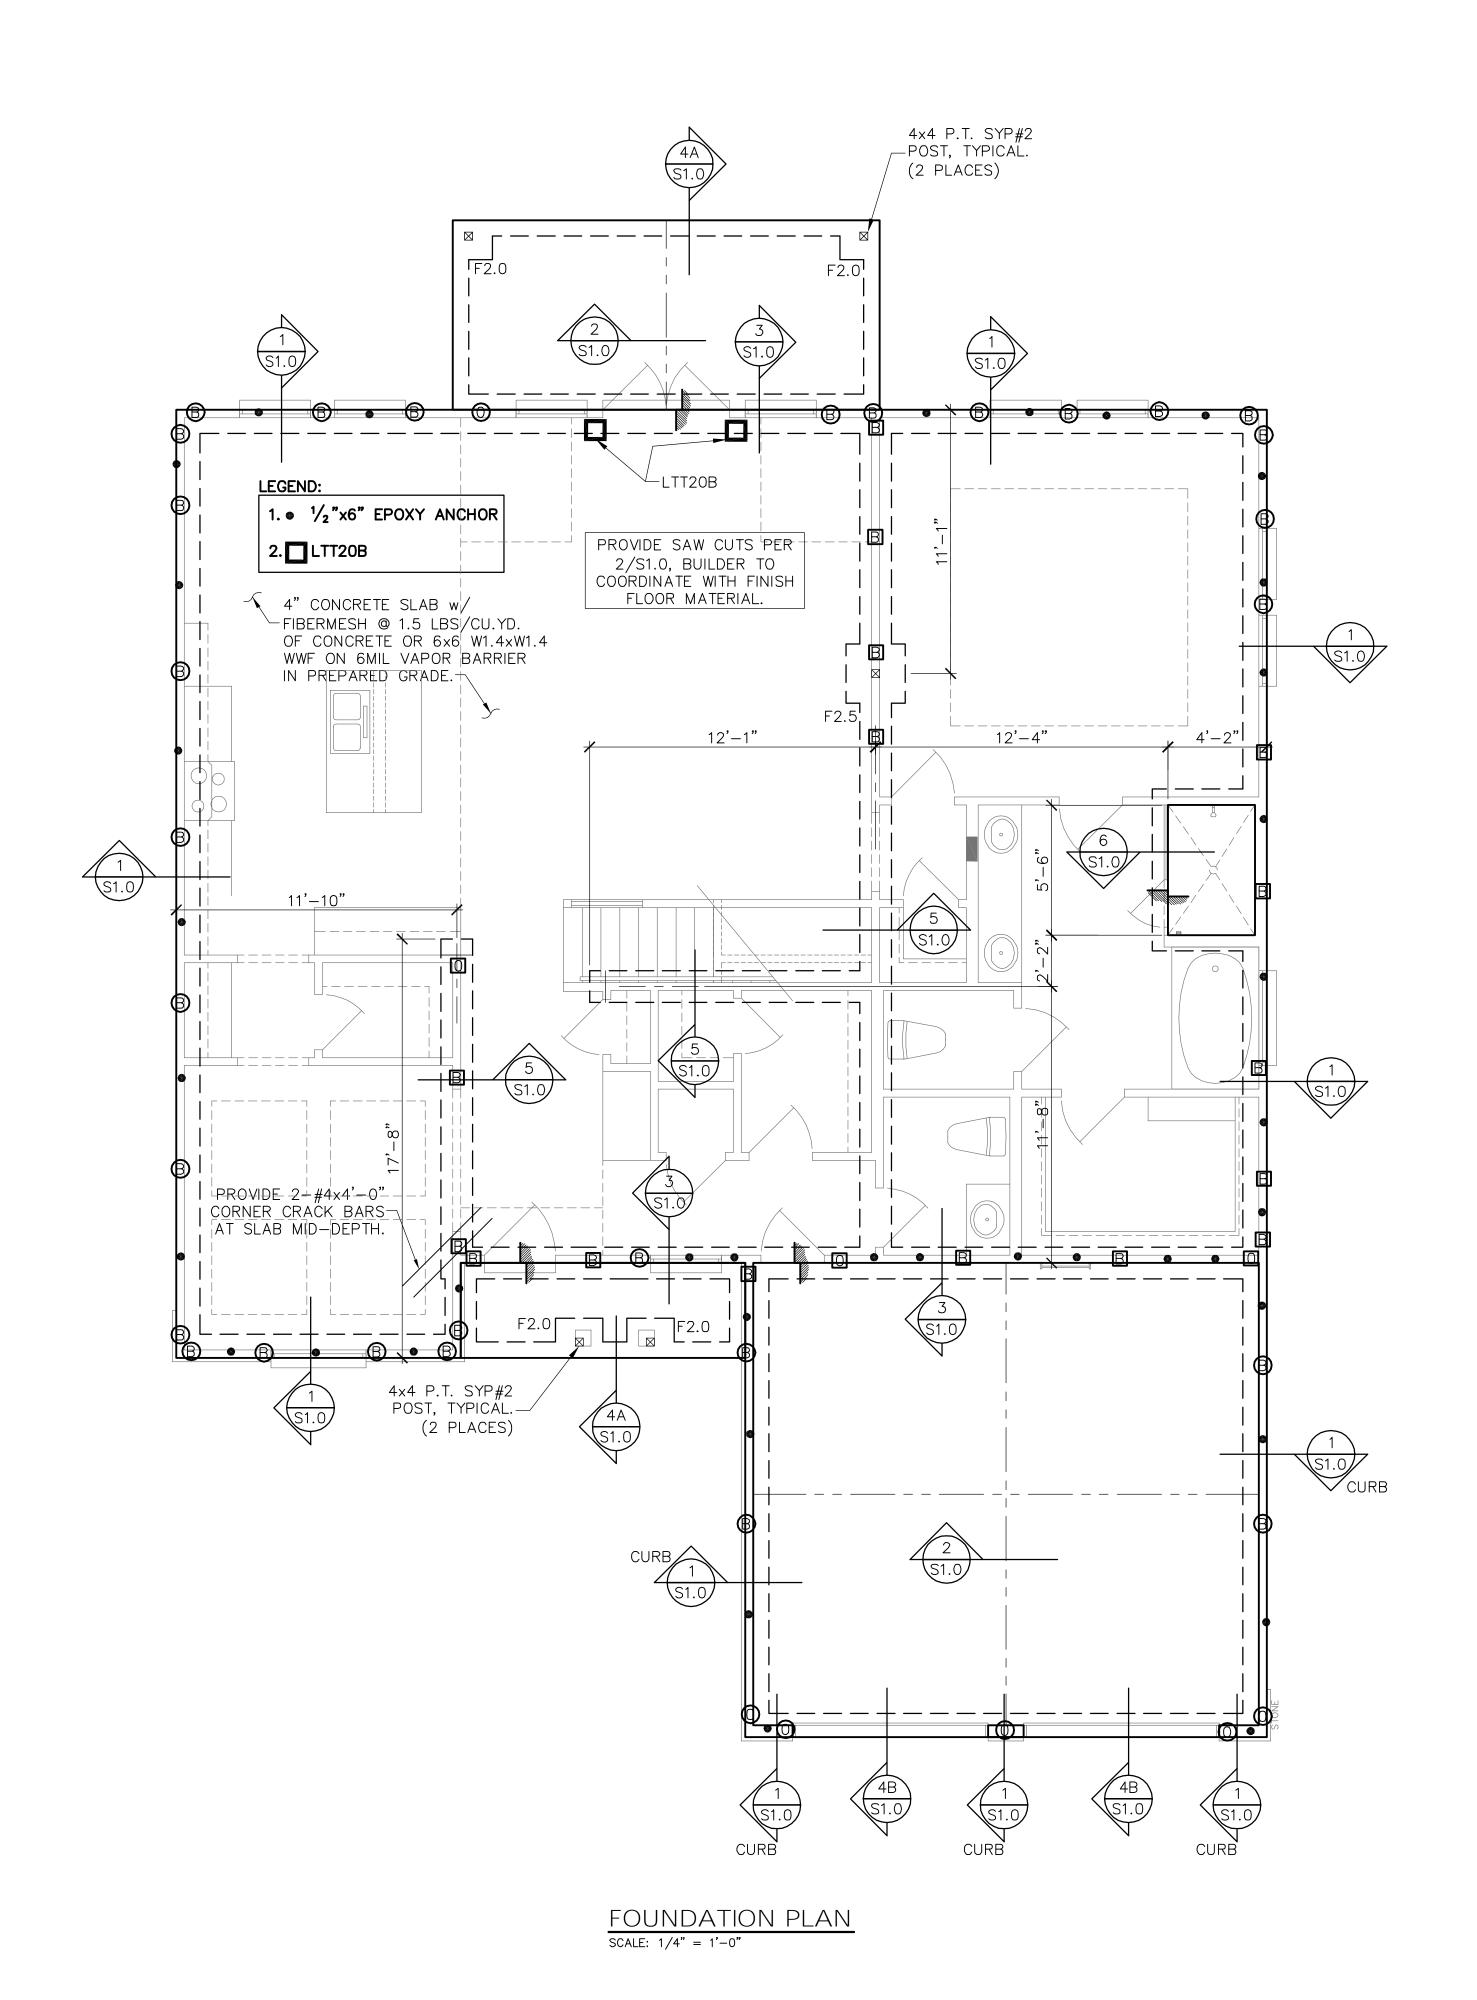
DESIGN CRITERIA AND GENERAL

ESE DRAWINGS. IF A DIMENSION UNCLEAR REFER TO THE CONTACT THE E.O.R. PLAN NAME DESIGN/DRAWN/CHECKED

CS / BMB / LAP 5.23.11 SCALE AS NOTED TRUSS ID 368534 LPA NO DRBD-11-00264 SHEET

SHEET 1 OF 5



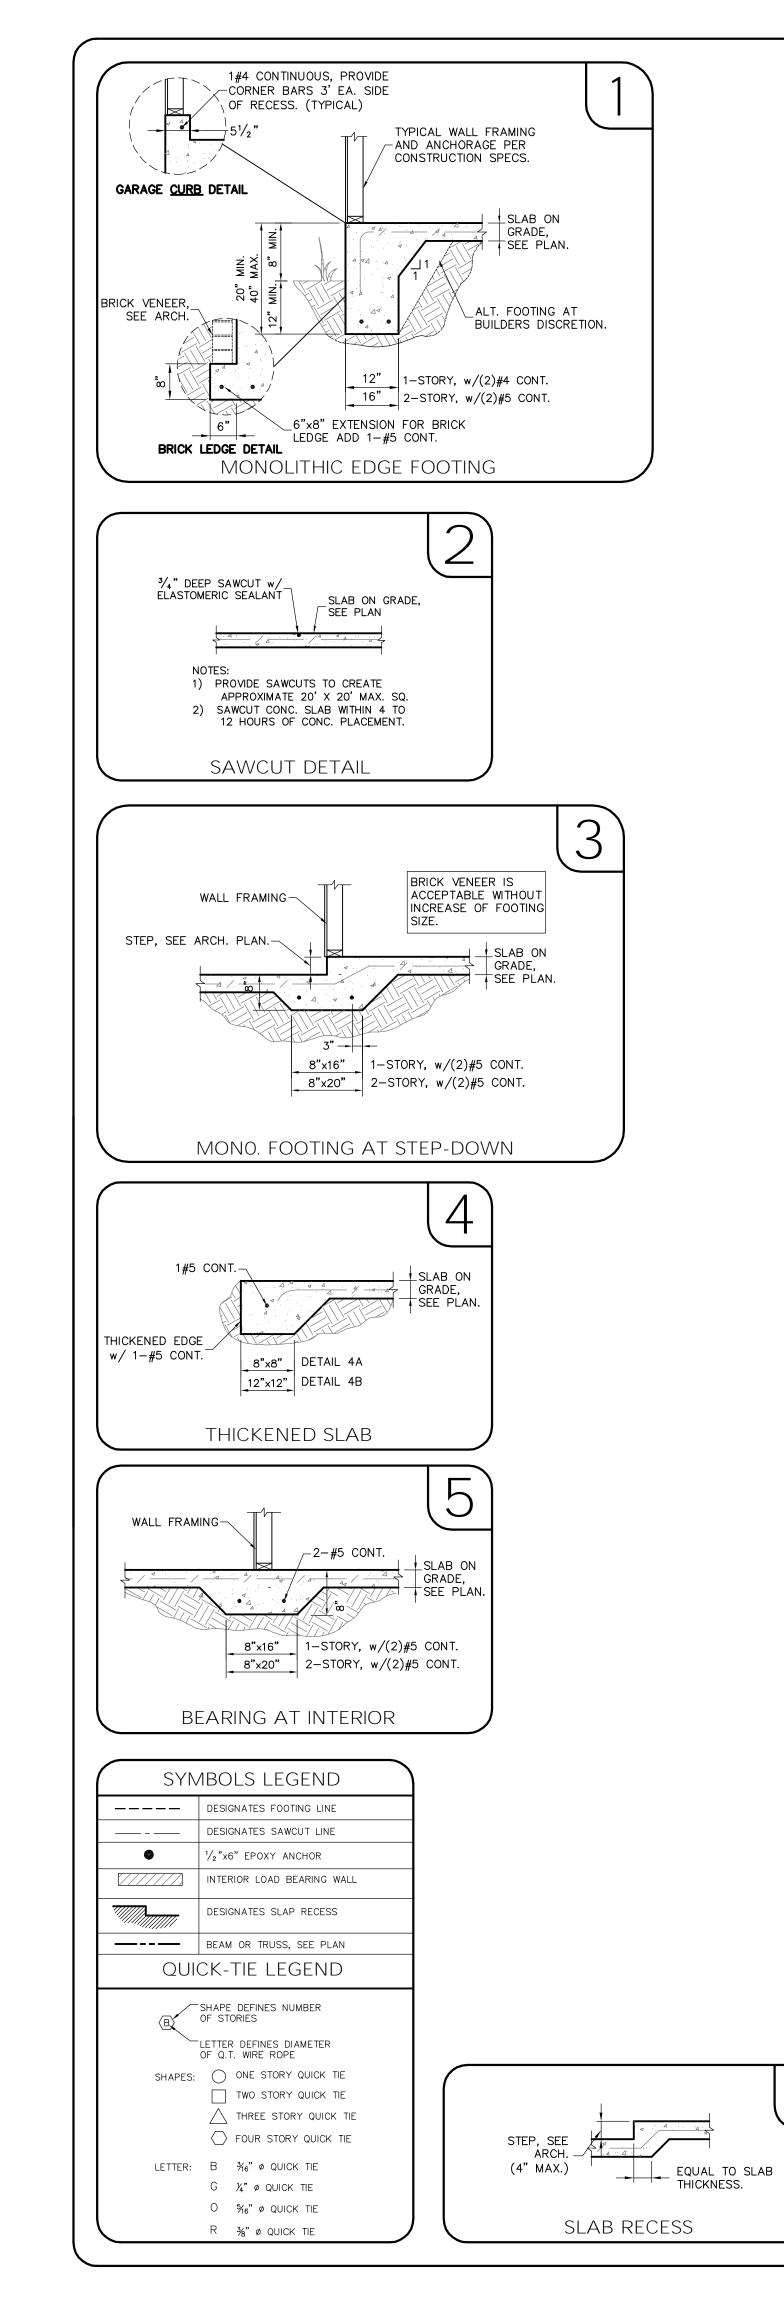

BOTTOM BARS 2'-0" 1'-0" 3-#5 EA. WAY BOT. 2'-6" 1'-0" 3-#5 EA. WAY BOT. 3'-0" 1'-0" 3-#5 EA. WAY BOT. 3'-6" 1'-0" 4-#5 EA. WAY BOT.

4'-0"

FOOTING SCHEDULE AND NOTES

4'-0" 1'-0"

4'-6" 4'-6" 1'-0" 1. THIS FOUNDATION PLAN ONLY CONVEYS STRUCTURAL INFO. RELATED TO THE FOUNDATION. FOR GENERAL FEATURES, DIMENSIONS, CONDUITS, ELECTRICAL EMBEDS, STEP HEIGHTS, ECT., SEE ARCH. PLAN. ARCHITECTURAL PLAN SHOWN HERE IN FOR REFERENCE ONLY.

2. FTGS. & FND. SHALL BE IN ACCORDANCE $\ensuremath{\text{w}/\text{ LOCAL}}$ BUILDING CODES. 3. SOIL COMPACTION AND FILL SHALL BE COMPACTED TO A MIN. OF 95% MODIFIED PROCTOR IN ACCORDANCE WITH ASTM D 1557.

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FROM THE INTENT OF THE ORIGINAL CONSTRUCTION DOCUMENTS. AN ASSOCIATES MAY RESULT IN INSPECTION FEES.


MONO **FOUNDATION** PLAN

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PLAN NAME					
2347					
DESIGN/DRAWN/CHECKED					
CS / BMB / LAP					
DATE					
5.23.11					
SCALE					
AS NOTED					
TRUSS ID.					
368534					
LPA NO.					
DRBD-11-00264					
SHEET					
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SHEET 2 OF 5

4-#5 EA. WAY BOT.



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IST FLOOR FRAMING PLAN

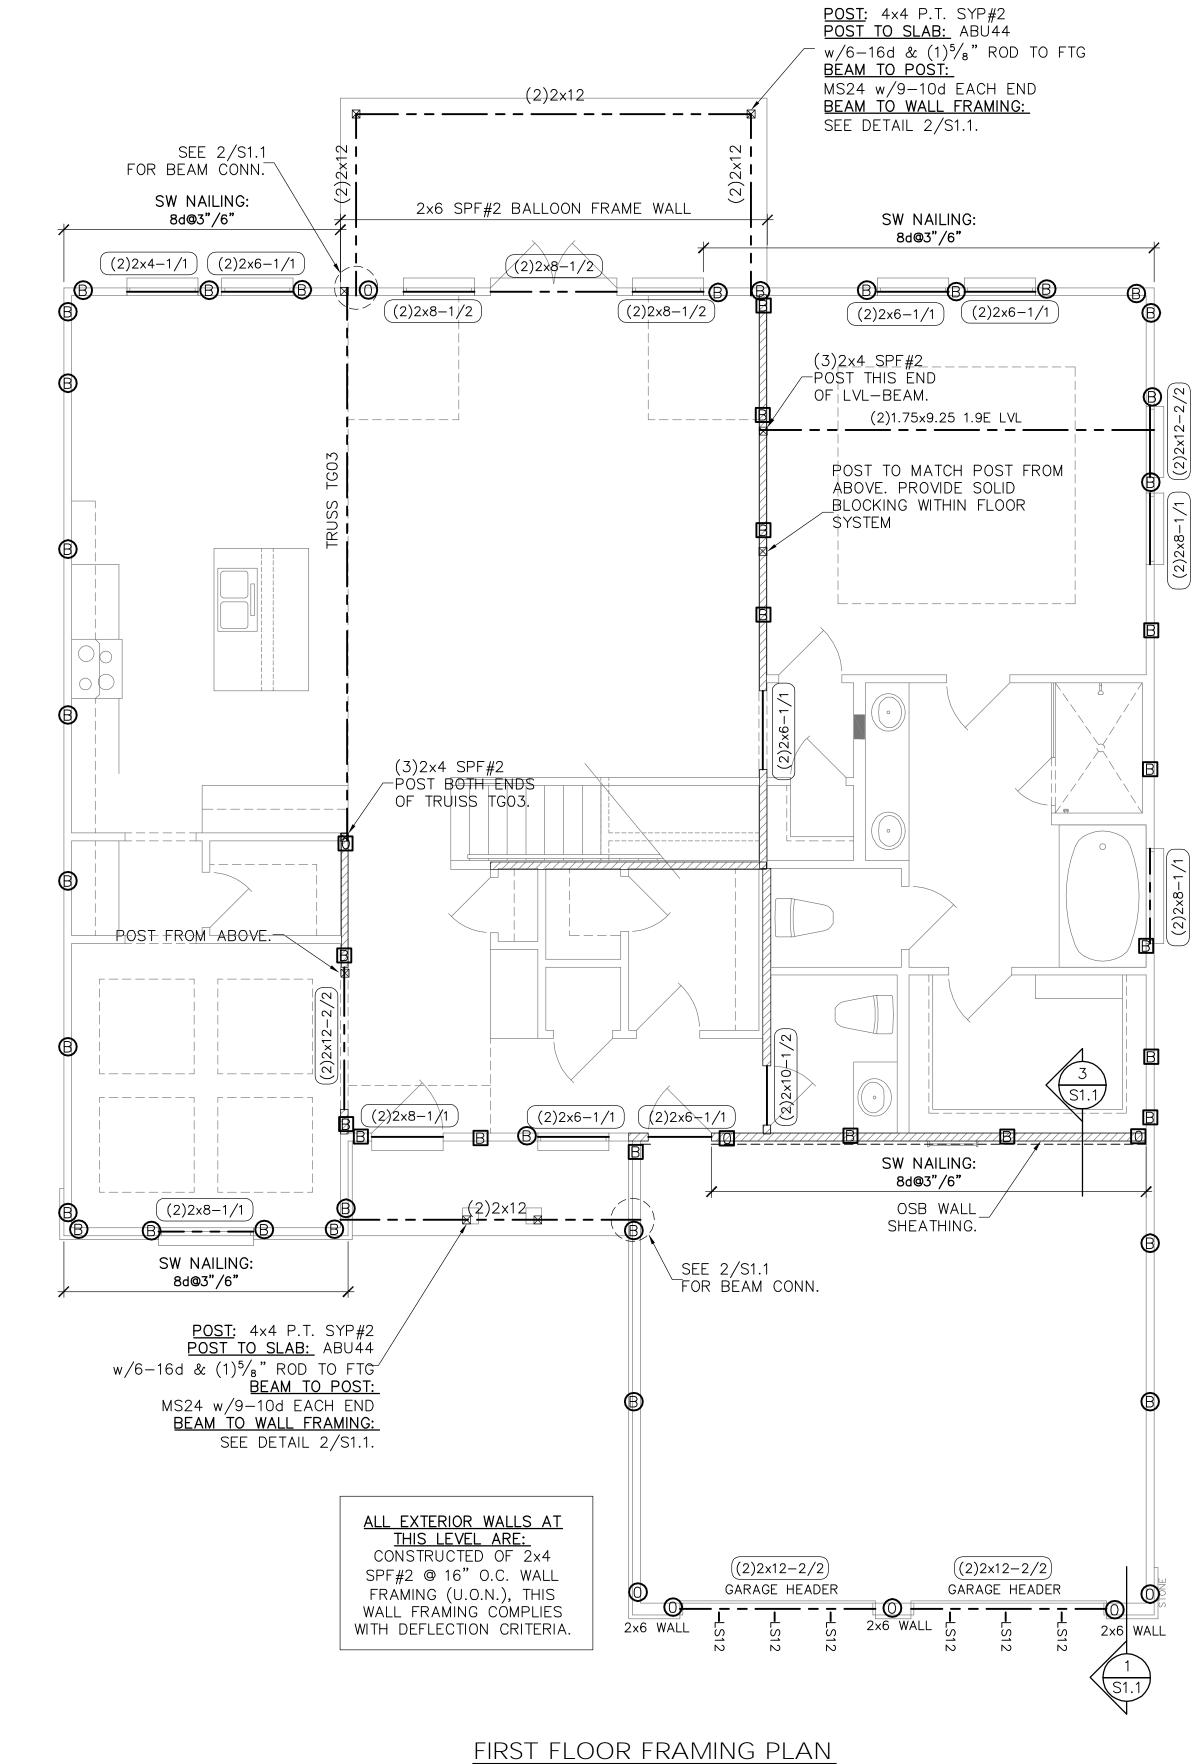SYMBOLS LEGEND

(2)2x8-1/2 DESIGNATES THE HEADER SIZE AND NUMBER OF PLY'S DESINATES NUMBER, HEADER SIZE & JACK/KING STUDS NEEDED FOR SUPPORT HEADER.

DESIGNATES INTERIOR LOAD BEARING WALLS.

QUICK-TIE LEGEND

SHAPE DEFINES NUMBER OF STORIES

SHAPES: ONE STORY QUICK TIE

LETTER: B ¾6" ø QUICK TIE

G ¼" ø QUICK TIE

O 5/16" Ø QUICK TIE

R ¾" ø QUICK TIE

LETTER DEFINES DIAMETER OF Q.T. WIRE ROPE

TWO STORY QUICK TIE

FOUR STORY QUICK TIE

THREE STORY QUICK TIE

BEAM OR TRUSS, SEE PLAN

8d@3"/6"

DESIGNATES SHEARWALL. THE HIDDEN LINE DESIGNATES SIDE OF WALL THE SHEARWALL SHEATHING TO BE APPLIED. 8d @ 3/6 DESIGNATES 8d COMMONS @ 3" O.C. EDGE & 6" O.C. "IN THE FIELD"

DO NOT SCALE DIMENSIONS FROM HESE DRAWINGS. IF A DIMENSION IS UNCLEAR REFER TO THE

ARCHITECTURAL DRAWINGS OR CONTACT THE E.O.R. PLAN NAME 2347 DESIGN/DRAWN/CHECKED CS / BMB / LAP 5.23.11 SCALE AS NOTED TRUSS ID. 368534 LPA NO. DRBD-11-00264 SHEET

SHEET 3 OF 5

SCALE: 1/4" = 1'-0"

1. FOR TYPICAL WALL FRAMING, SEE DETAIL 7/SO.O.

FRAMING/CONNECTION	
20ga STRAP © 32" O.C ALWAYS PLACHEADER AT TOP OF ROUGO OPENING (2)2x6 JACK STUDS (2)2v6 KING STUDS (3)2x STUD CORNER— P.T. SOLE PLATE— GARAGE	
GARAGE FLOOR THICKENED SLAB EDGE AT GARAGE OPENING. GARAGE WING WALL ELEVATION	NOTES: 1. ALWAYS PLACE GARAGE HEADER AT TOP OF ROUGH OPENING.

TYPICAL GARAGE HEADER/JACK CONNECTION

PORCH _HEADER,

8-GUN NAILS-


TYPICAL PORCH BEAM


SEE PLÁN.


MIN. (2)2×4 WOOD BELOW.


─& (1) ADJ. TO PORCH

HEADER.

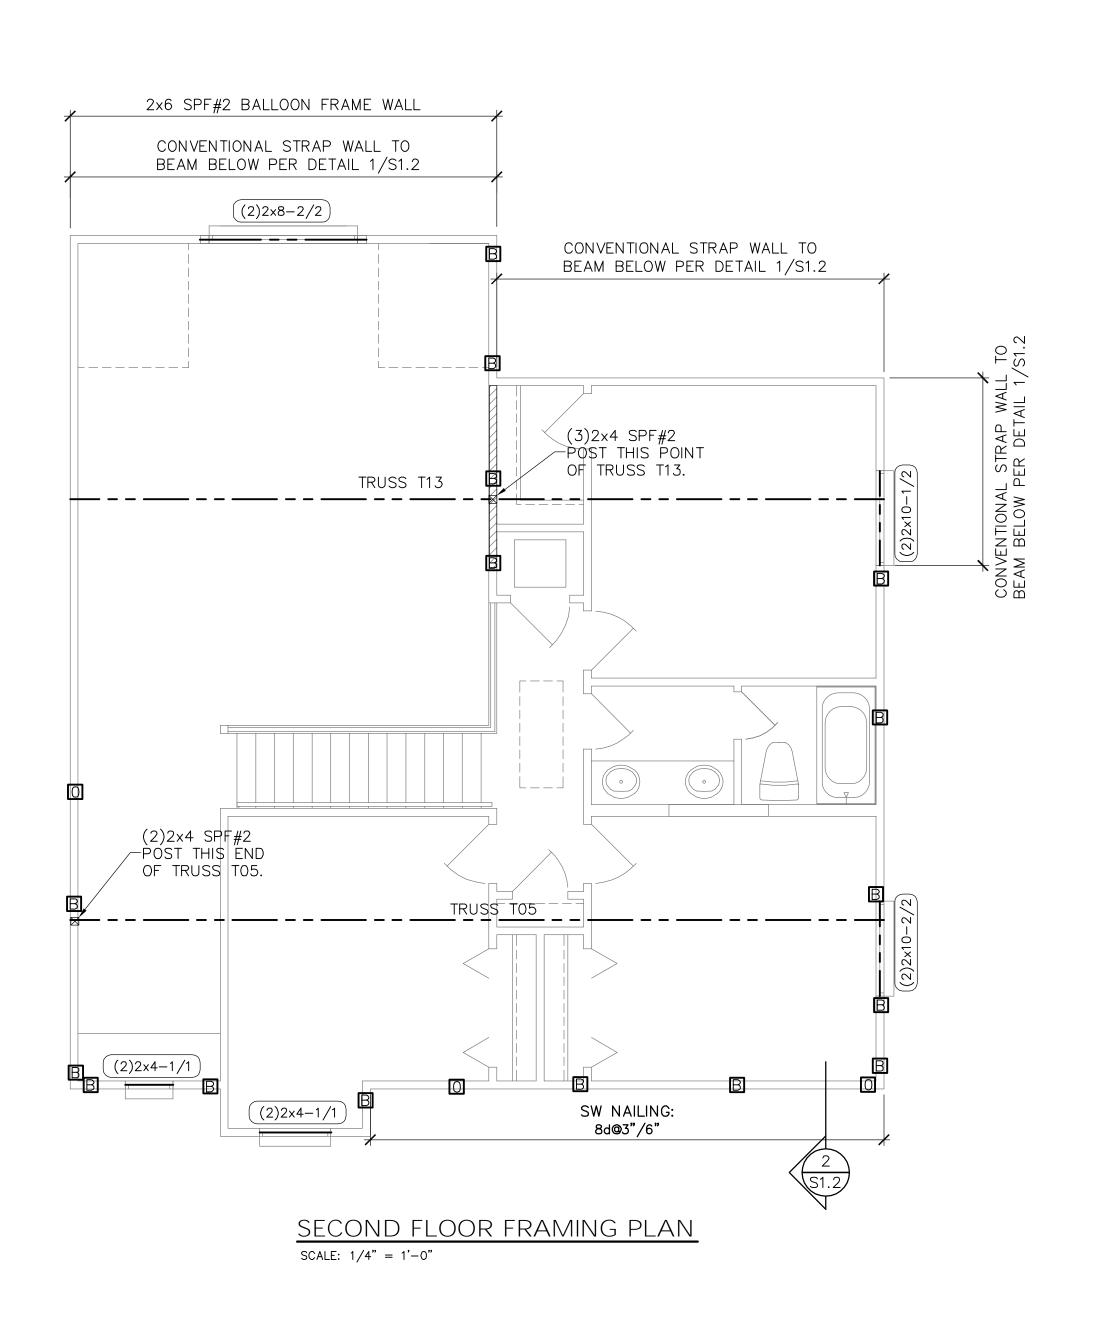

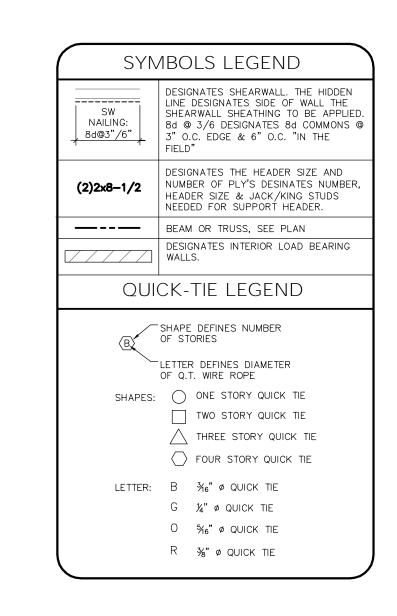

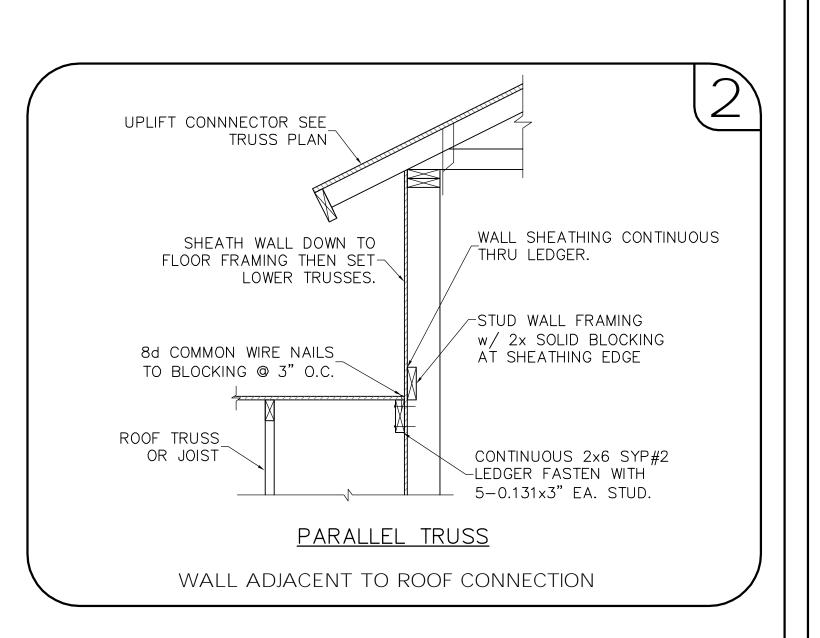

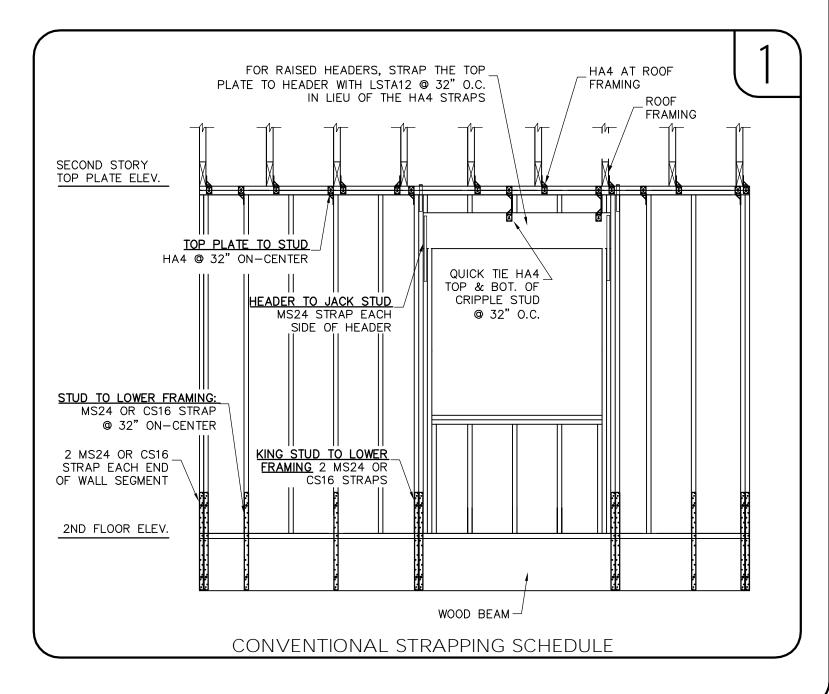




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FIELD ALTERATION

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ADDITIONAL ENGINEERING OR
INSPECTION FEES.

DREAM BUILDERS 6 SANCTUARY

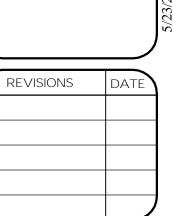
2nd FLOOR FRAMING PLAN


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PLAN NAME
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SHEET 4 OF 5







ROOF TRUSS PLACEMENT PLAN

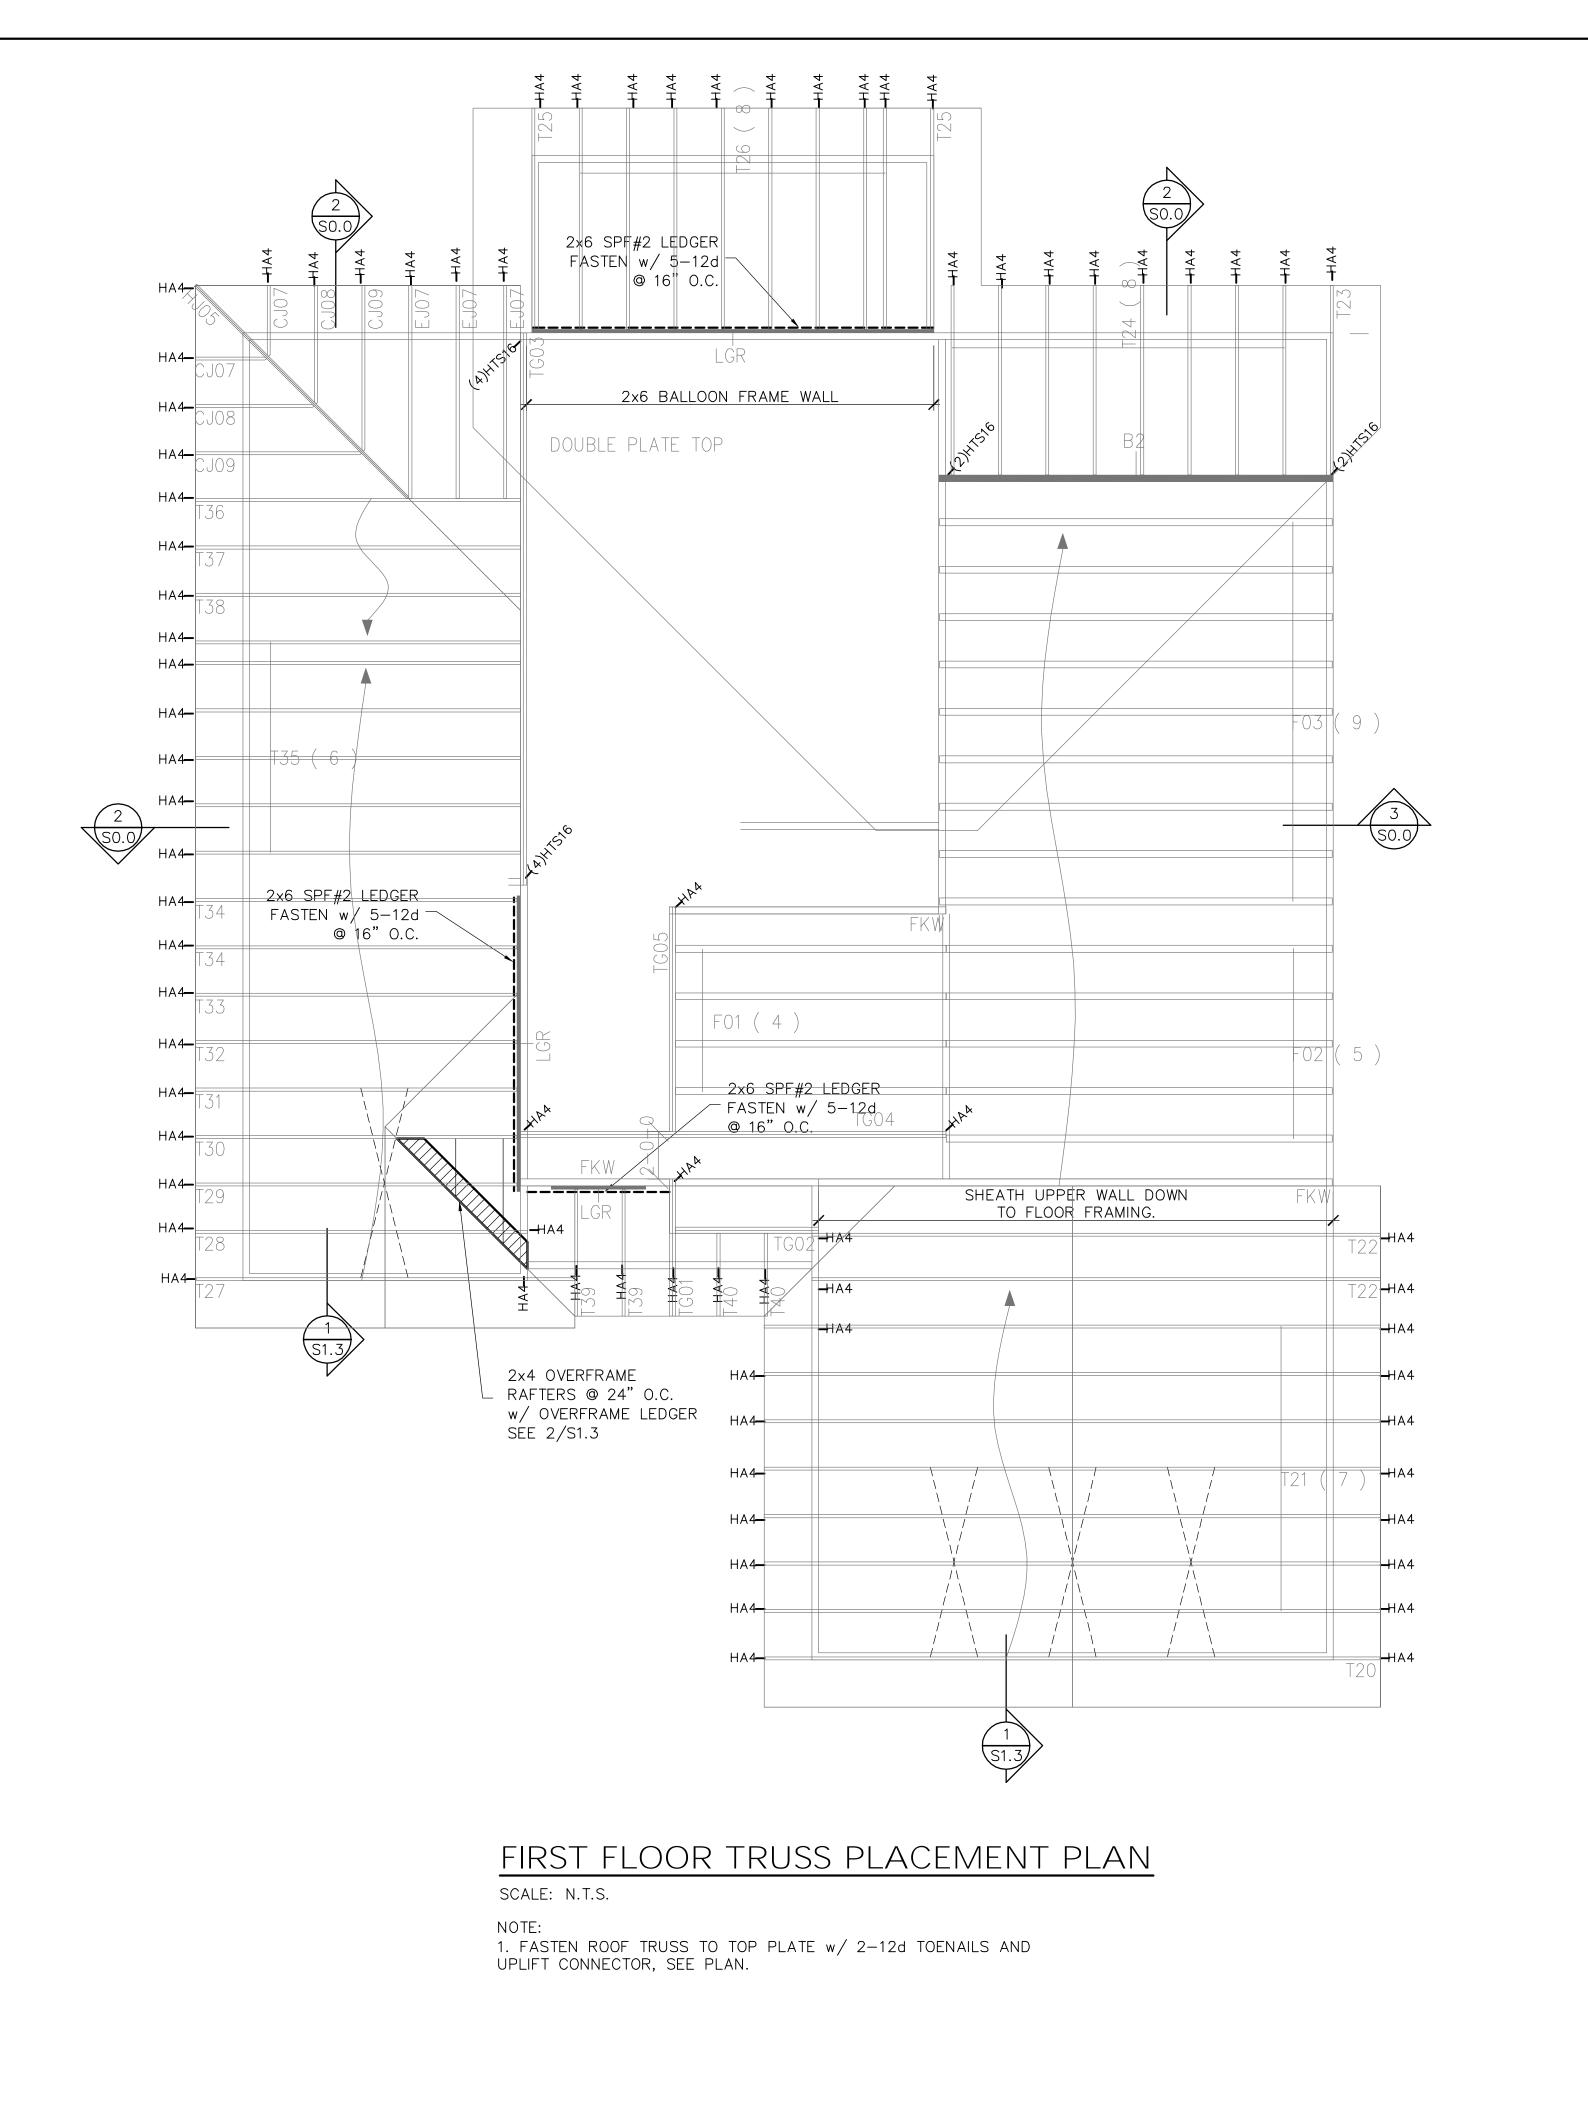SCALE: N.T.S.

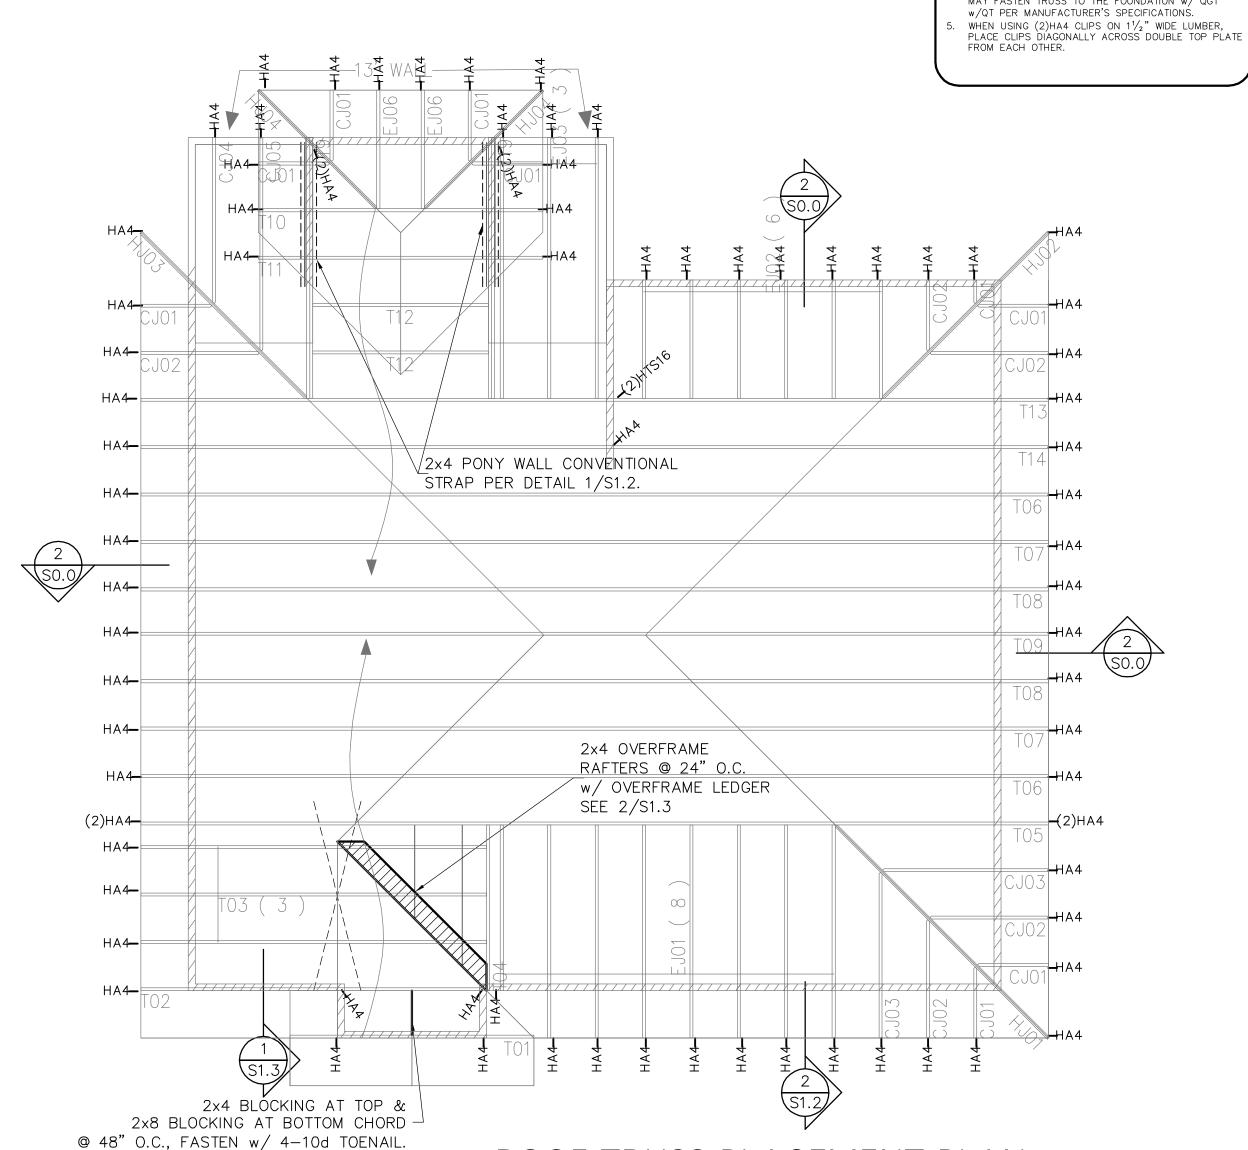1. FASTEN ROOF TRUSS TO TOP PLATE w/ 2-12d TOENAILS AND UPLIFT CONNECTOR, SEE PLAN.

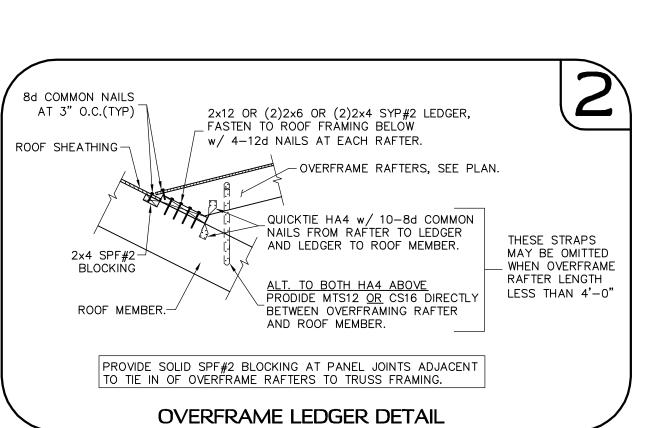

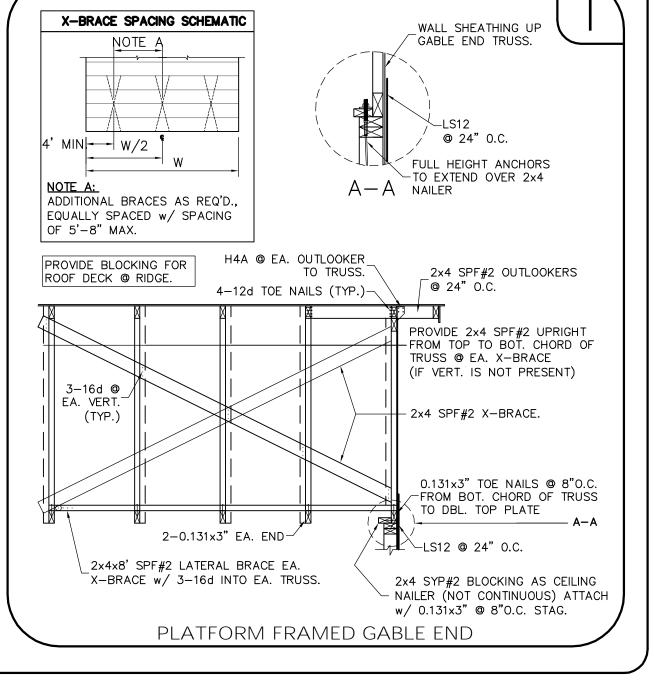

L P A

SYMBOLS LEGEND

FRAMING PLAN NOTES:

1. FOR TYPICAL ROOF SHEATHING AND FRAMING, SEE SHEET SO.O.

2. FOR SPECIFIC UPLIFT CONNECTORS, SEE PLAN. MIN.

FOR GENERAL DESIGN SPECIFICATIONS SEE SHEET <u>SO.O.</u>
FOR TRUSS UPLIFTS UP TO 2200 LBS., CONTRACTOR MAY FASTEN TRUSS TO THE FOUNDATION W/ QGT

DESIGNATES UPLIFT CONNECTION.

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S/23/2011 9:41:54 AM

REVISIONS DATE

FIELD ALTERATION

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DREAM BUILDERS 6 SANCTUARY

TRUSS PLACEMENT PLAN

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AS NOTED

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368534

LPA NO.
DRBD-11-00264

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SHEET 5 OF 5