QUICKTIE CONNECTORS

TYPICAL WOOD MEMBER FASTENING SCHEDULE

Lou Pontigo and

Associates, Inc.

420 Osceola Avenue Jax. Beach, Florida 32250 Ph. 242-0908 Fax. 241-9557 FL: CA # 8344 SC: CA# 3579

CONTACT US WITH YOUR COMMENT COMMENTS @ LP-A.COM

REVISIONS

FIFLD ALTERATION ONTRACTOR SHALL CONTACT LO PONTIGO & ASSOCIATES PRIOR TO MAKING ANY STRUCTURAL FIFLE FROM THE INTENT OF THE ORIGINAL LD ALTERNATIONS MADE PRIOR ING APPROVED BY LOU PONTI ASSOCIATES MAY RESULT IN

ADDITIONAL ENGINEERING C

INSPECTION FEES.

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**DESIGN CRITERIA** AND **GENERAL NOTES** 


UNCLEAR REFER TO THE RCHITECTURAL DRAWINGS
CONTACT THE E.O.R.


PLAN NAME LOT. 2 AVALON DESIGN/DRAWN/CHECKED CS / AOB / LAP


02.08.2013 CONTROL NO 3437 TRUSS ID.


460040 DRBD-13-00031

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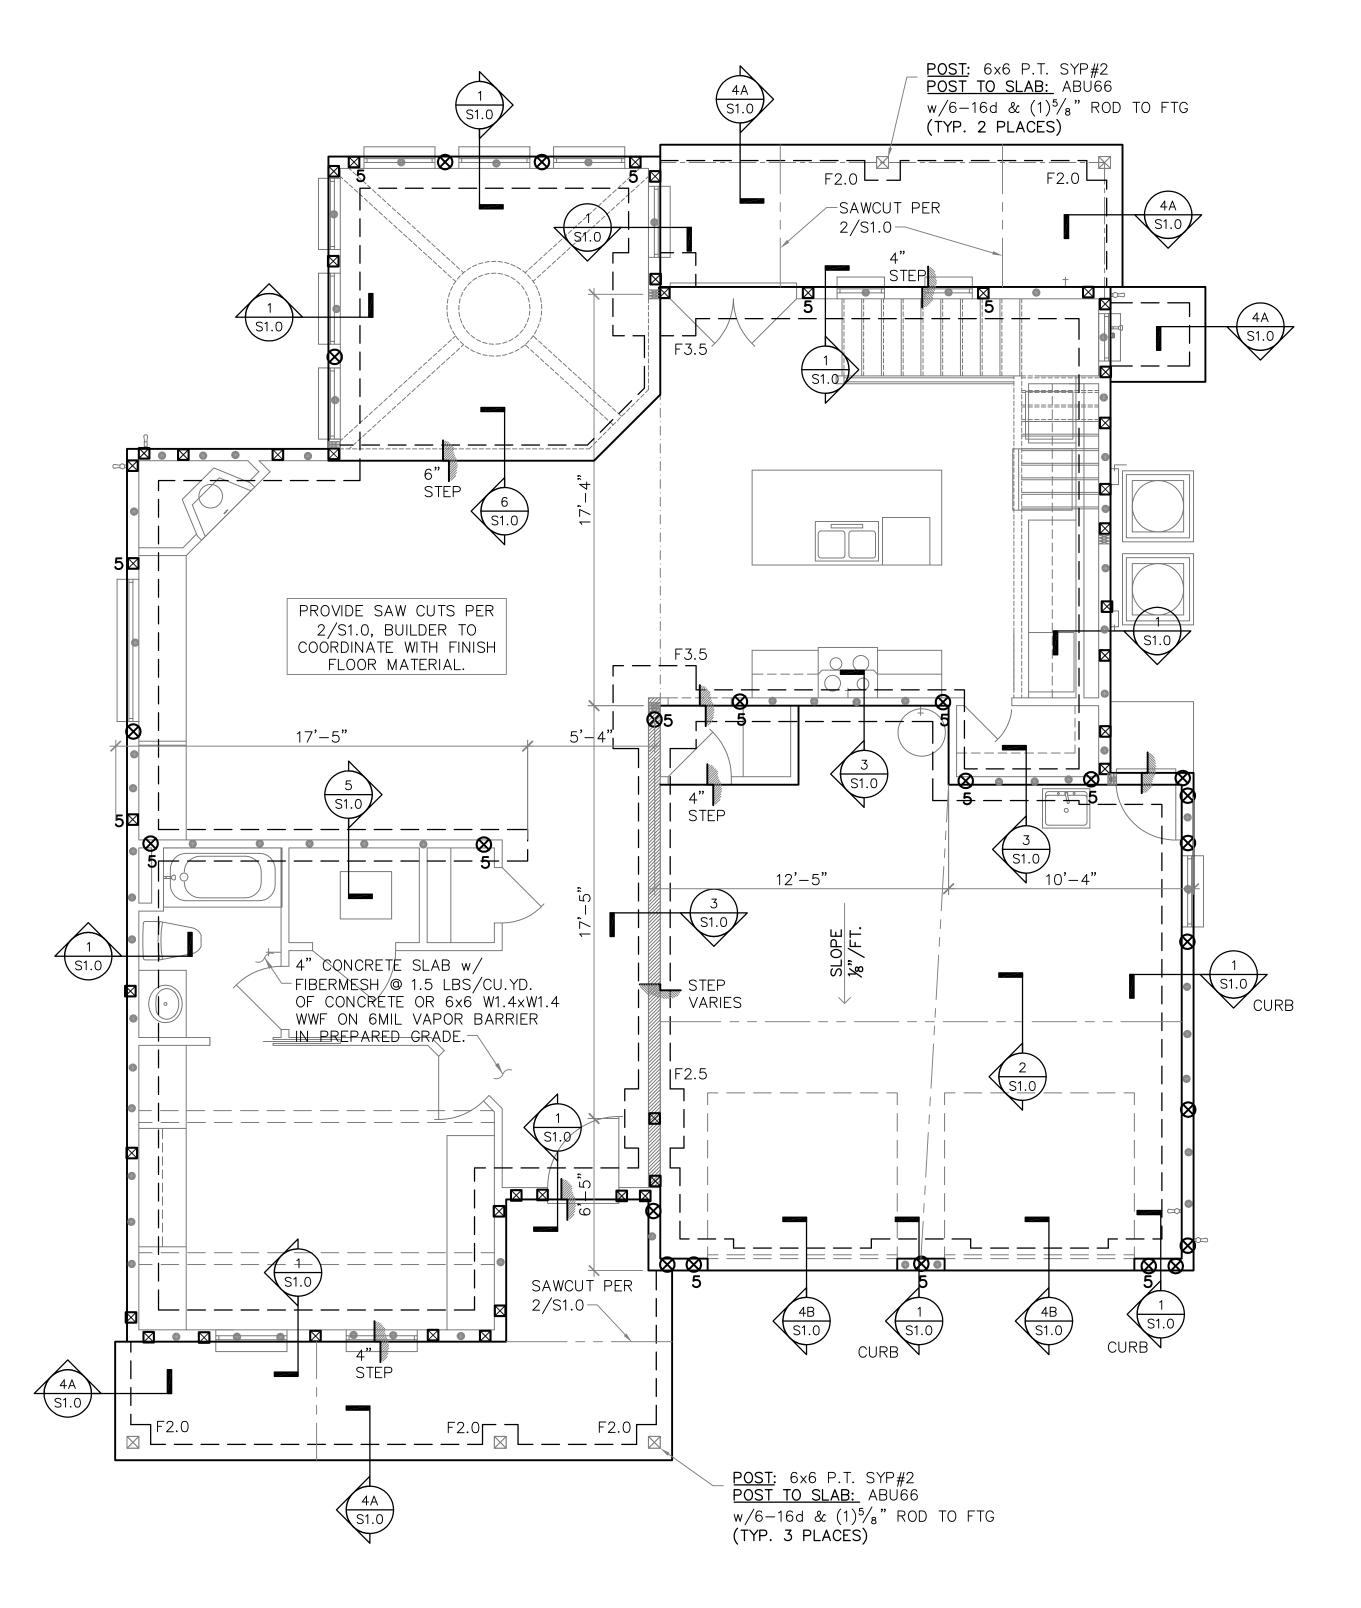


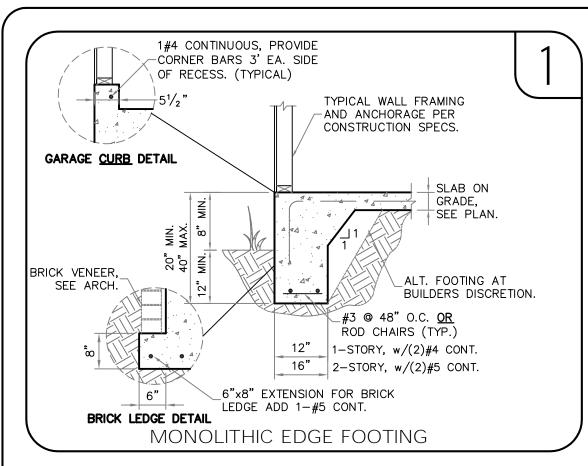

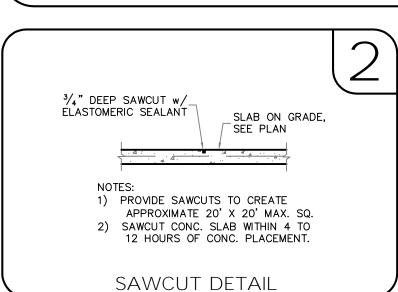

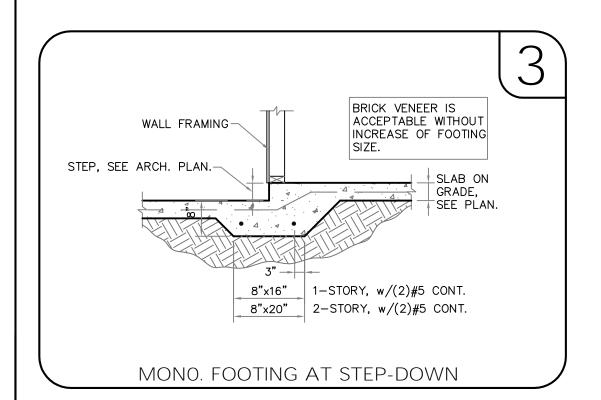


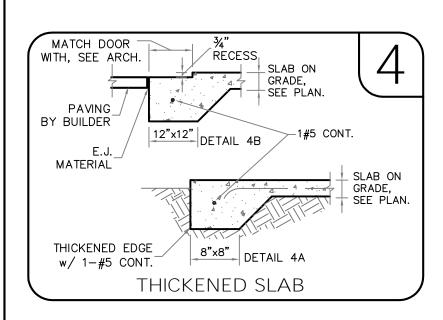
SYMBOLS LEGEND				
	DESIGNATES FOOTING LINE			
	DESIGNATES SAWCUT LINE			
	1/2"x6" EPOXY ANCHOR			
	INTERIOR LOAD BEARING WALL			
	DESIGNATES SLAP RECESS			
	BEAM OR TRUSS, SEE PLAN			
$\boxtimes$	%" A307 DIAMETER FULL HEIGHT THREADED ROD, SEE DETAIL 7/S0.0			
⊠5	%" A307 DIAMETER FULL HEIGHT THREADED ROD, SEE DETAIL 7/S0.0			
$\otimes$	%" A307 DIAMETER THREADED ROD TERMINATES AT FIRST FLOOR TOP PLATE, SEE DETAIL 7/SO.0			
⊗5	%" A307 DIAMETER THREADED ROD TERMINATES AT FIRST FLOOR TOP PLATE, SEE DETAIL 7/SO.0			
LSTA12	12" LONG LIGHT GAUGE STRAP FASTEN TO TOP PLATE AND STUD WITH 5-10d COMMONS			




# FOUNDATION PLAN

SCALE: 1/4" = 1'-0"

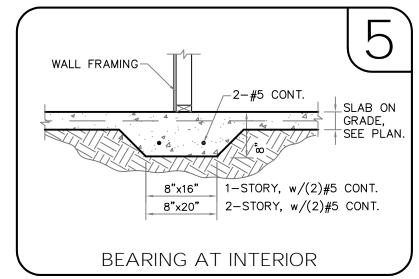

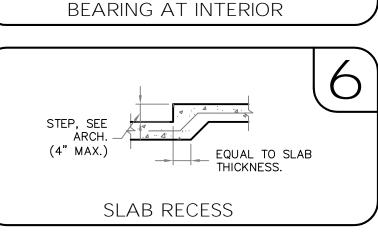

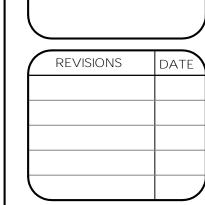

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000170407000011411
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## MONO FOUNDATION PLAN

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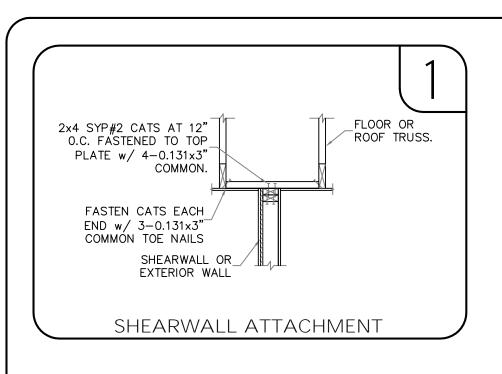
> PLAN NAME LOT. 2 AVALON


FOOTING SCHEDULE AND NOTES						
TYPE	LENGTH	WIDTH	DEPTH	BOTTOM BARS		
F2.0	2'-0"	2'-0"	1'-0"	3-#5 EA. WAY BOT.		
F2.5	2'-6"	2'-6"	1'-0"	3-#5 EA. WAY BOT.		
F3.0	3'-0"	3'-0"	1'-0"	3-#5 EA. WAY BOT.		
F3.5	3'-6"	3'-6"	1'-0"	4-#5 EA. WAY BOT.		
F4.0	4'-0"	4'-0"	1'-0"	4-#5 EA. WAY BOT.		
F4.5	4'-6"	4'-6"	1'-0"	4-#5 EA. WAY BOT.		
1. THIS FOUNDATION PLAN ONLY CONVEYS STRUCTURAL INFO. RELATED TO THE FOUNDATION. FOR GENERAL FEATURES, DIMENSIONS, CONDUITS, ELECTRICAL EMBEDS STEP HEIGHTS, ECT., SEE ARCH. PLAN. ARCHITECTURAL PLAN SHOWN HERE IN FOR REFERENCE ONLY.						


2. FTGS. & FND. SHALL BE IN ACCORDANCE w/ LOCAL BUILDING CODES. 3. SOIL COMPACTION AND FILL SHALL BE COMPACTED TO A MIN. OF 95% MODIFIED PROCTOR IN ACCORDANCE WITH ASTM D 1557.


DESIGN/DRAWN/CHECKED CS / AOB / LAP 02.08.2013 CONTROL NO. 3437 TRUSS ID. 460040 LPA NO. DRBD-13-00031 SHEET

SHEET 2 OF 5



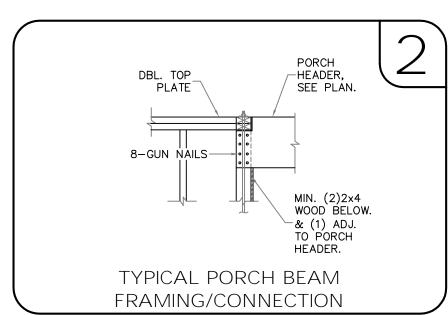

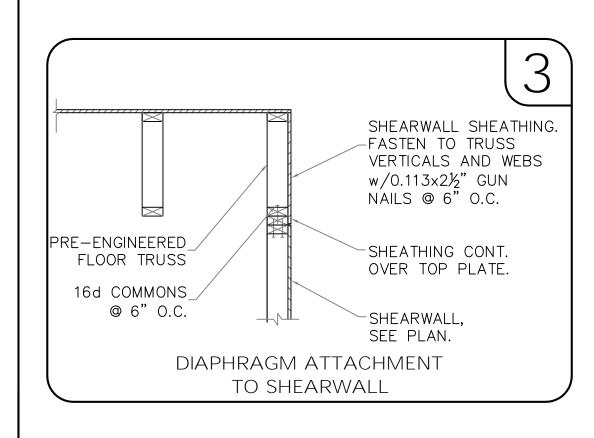

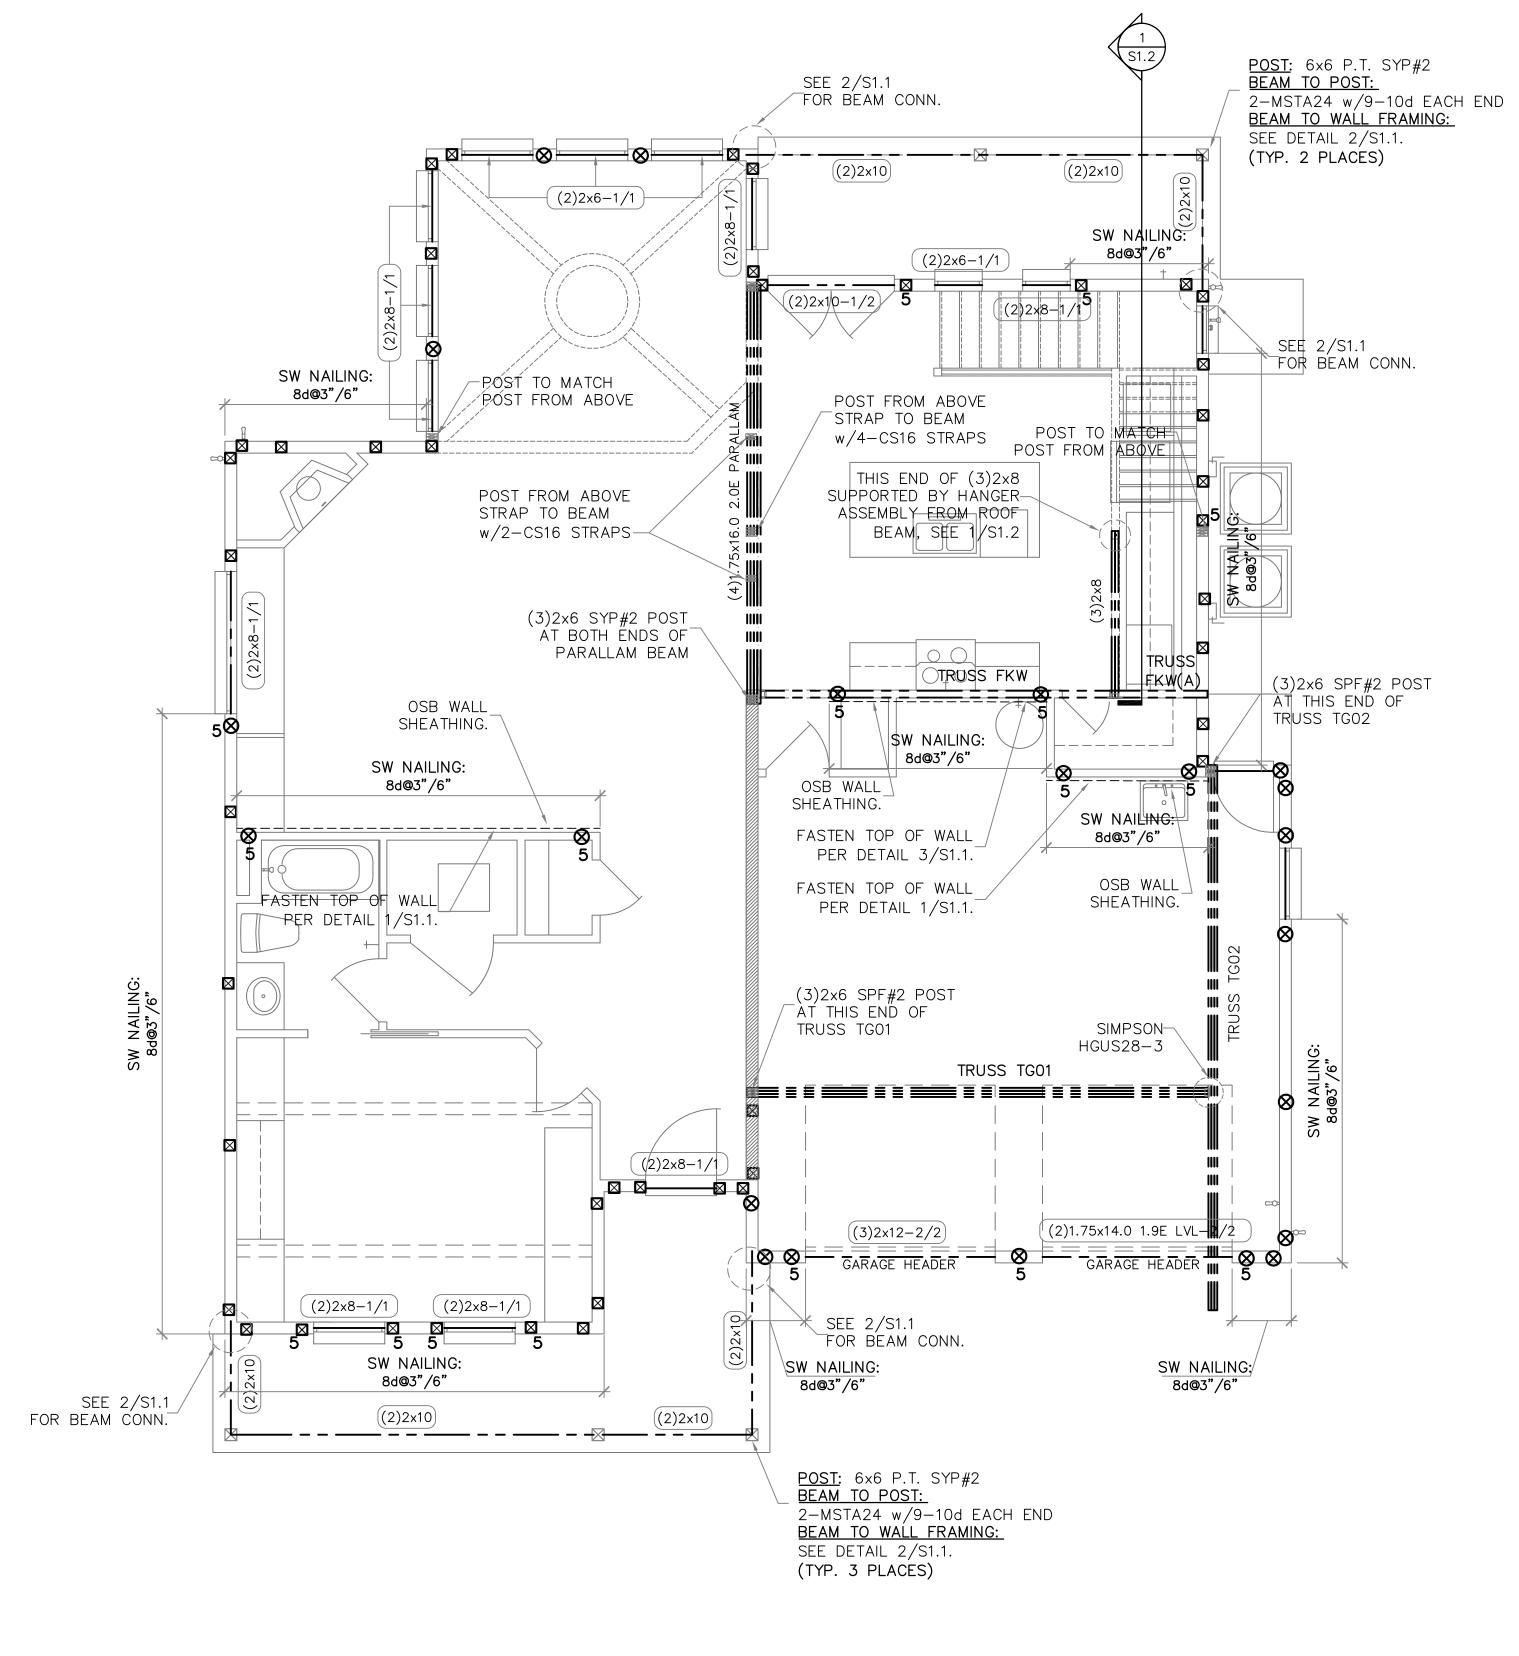


### FIRST FLOOR FRAMING PLAN SCALE: 1/4" = 1'-0"

FRAMING NOTES: 1. FOR TYPICAL WALL FRAMING, SEE DETAIL 6/SO.O.

2. ALL BUILT-UP POST, HEADERS & BEAMS SHALL BEE FASTENED PER 5/SO.O.



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 $\bigcap$ 

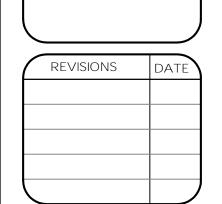**IST FLOOR FRAMING PLAN** 

OO NOT SCALE DIMENSIONS FROM HESE DRAWINGS. IF A DIMENSION IS UNCLEAR REFER TO THE ARCHITECTURAL DRAWINGS OF CONTACT THE E.O.R.

SYMBOLS LEGEND

8d@3"/6" 3" O.C. EDGE & 6" O.C. "IN THE

BEAM OR TRUSS, SEE PLAN

(2)2x8-1/2

DESIGNATES SHEARWALL. THE HIDDEN LINE DESIGNATES SIDE OF WALL THE SHEARWALL SHEATHING TO BE APPLIED

8d @ 3/6 DESIGNATES 8d COMMONS @

DESIGNATES THE HEADER SIZE AND

HEADER SIZE & JACK/KING STUDS

3/8" A307 DIAMETER FULL HEIGHT

%" A307 DIAMETER FULL HEIGHT

THREADED ROD, SEE DETAIL 7/SO.0

THREADED ROD, SEE DETAIL 7/SO.0

%" A307 DIAMETER THREADED ROD TERMINATES AT FIRST FLOOR TOP

%" A307 DIAMETER THREADED ROD

TERMINATES AT FIRST FLOOR TOP PLATE, SEE DETAIL 7/SO.0

12" LONG LIGHT GAUGE STRAP FASTEN TO TOP PLATE AND STUD WITH 5-10d COMMONS

PLATE, SEE DETAIL 7/SO.0


NUMBER OF PLY'S DESINATES NUMBER,

PLAN NAME LOT. 2 AVALON DESIGN/DRAWN/CHECKED CS / AOB / LAP 02.08.2013


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LPA NO. DRBD-13-00031 SHEET

SHEET 3 OF 5

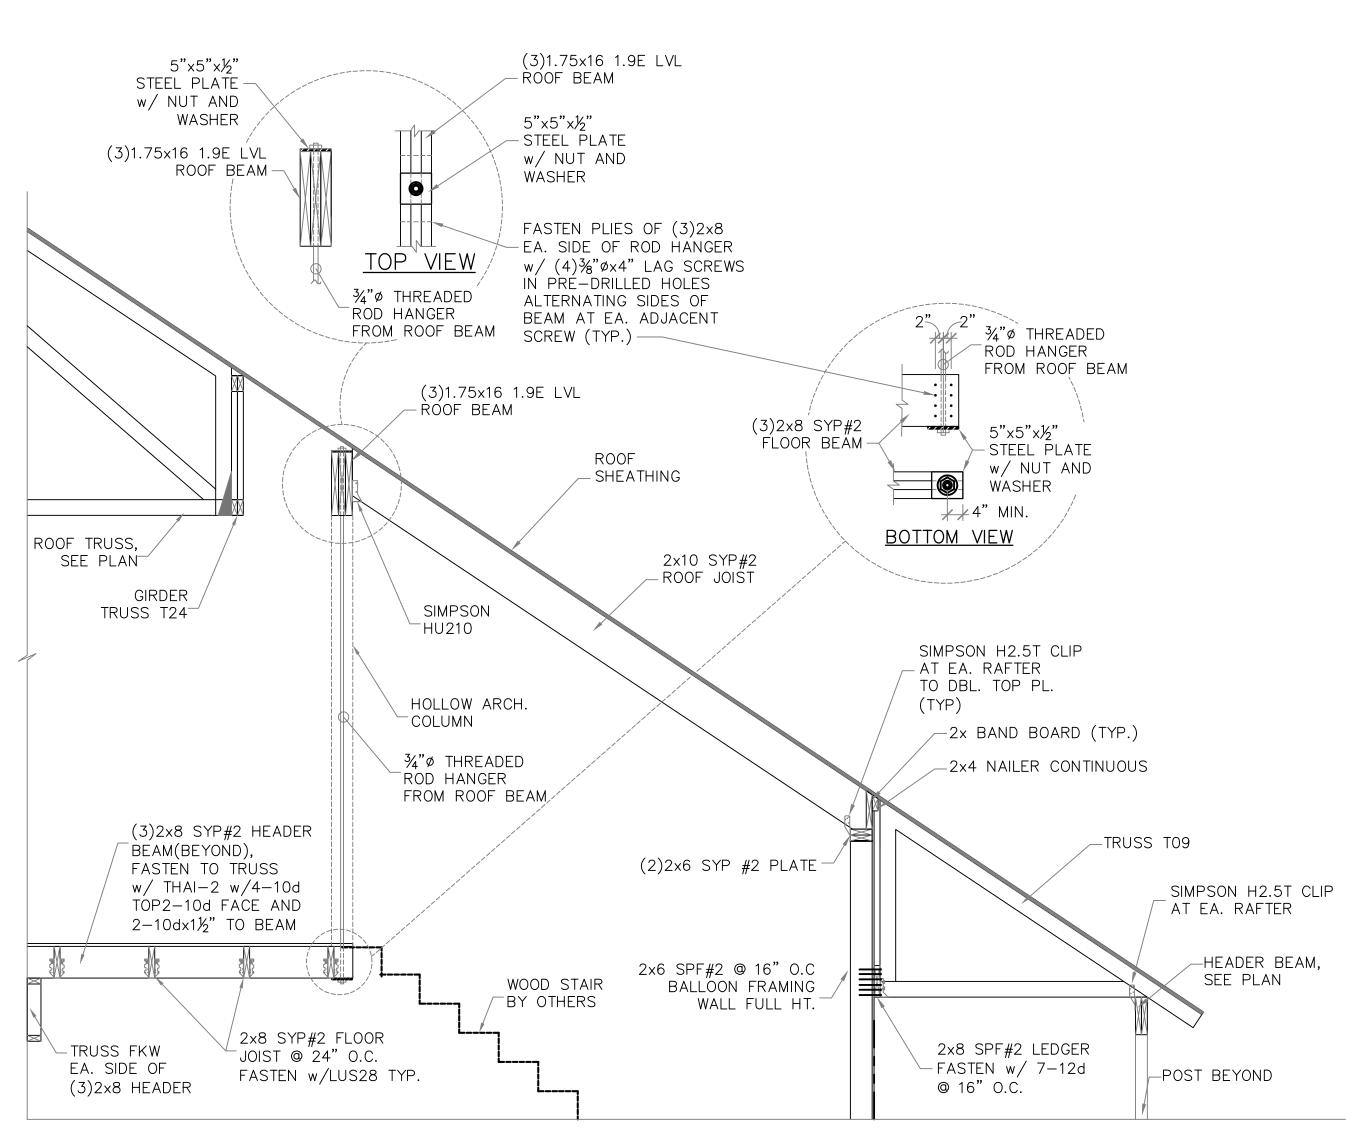

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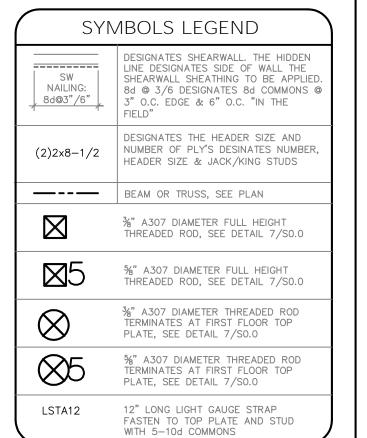
CONVENTIONAL WALL STRAPPING TO BEAM

SCALE: 1/2" = 1'-0"

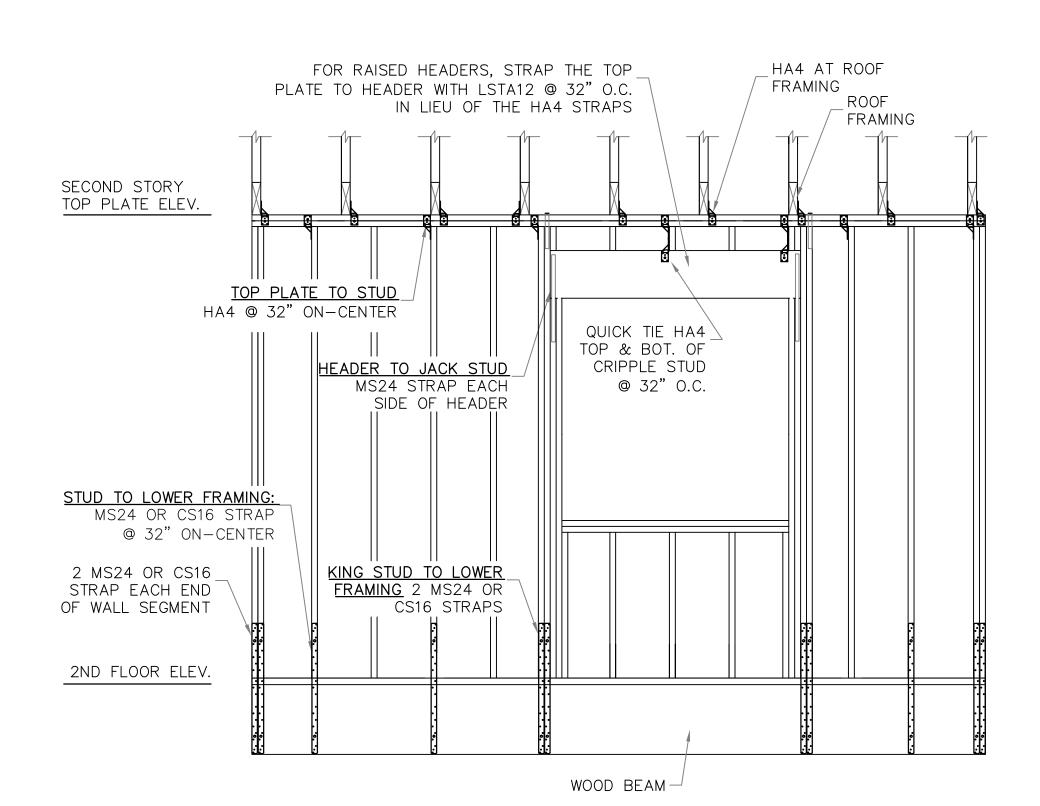(2)2x6-1/1(2)2x8-1/2STRAP WALL ROD SPACING PER 2/S1.2 2x6 @ 16" O.C. FULL HT. BALLOON FRAME WALL CONVENTIONALLY (MERE THREADED FEXCEEDS 6'-8" F <del>(3)2x6 SPF#</del>2 POST AT BOTH ENDS OF -(2)2x6 SPF#2 POST AT BOTH ENDS OF (2)2x8-1/1LVL ROOF BEAM FASTEN BEAM TO POST BELOW w/ TRUSS T21 (4)HTS16 (3)1.75×16.0 1.9E LVL (3)1./5x16.U 1.9E LVL TRUSS T24 (2)2x6 SPF#2 POST AT THIS END OF FNTIONALI WHERE T SPACING -8" PER TRUSS T24 (2)2x6-1/1 (2)2x6-1/1 CONVENTIONAL STRAPPING PER 2/S1.2 (2)2x6-1/1 (2)2x6-1/1

SECOND FLOOR FRAMING PLAN

SCALE: 1/4" = 1'-0"



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FIELD ALTERATION

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EAMBULIDER CUSTOM HOMES 212 39TH AVE. SOUTH Acksonville Beach, Fl.

2nd FLOOR FRAMING PLAN

DO NOT SCALE DIMENSIONS FROM THESE DRAWINGS. IF A DIMENSION UNCLEAR REFER TO THE ARCHITECTURAL DRAWINGS OR CONTACT THE E.O.R.

PLAN NAME
LOT. 2 AVALON

DESIGN/DRAWN/CHECKED
CS / AOB / LAP

DATE
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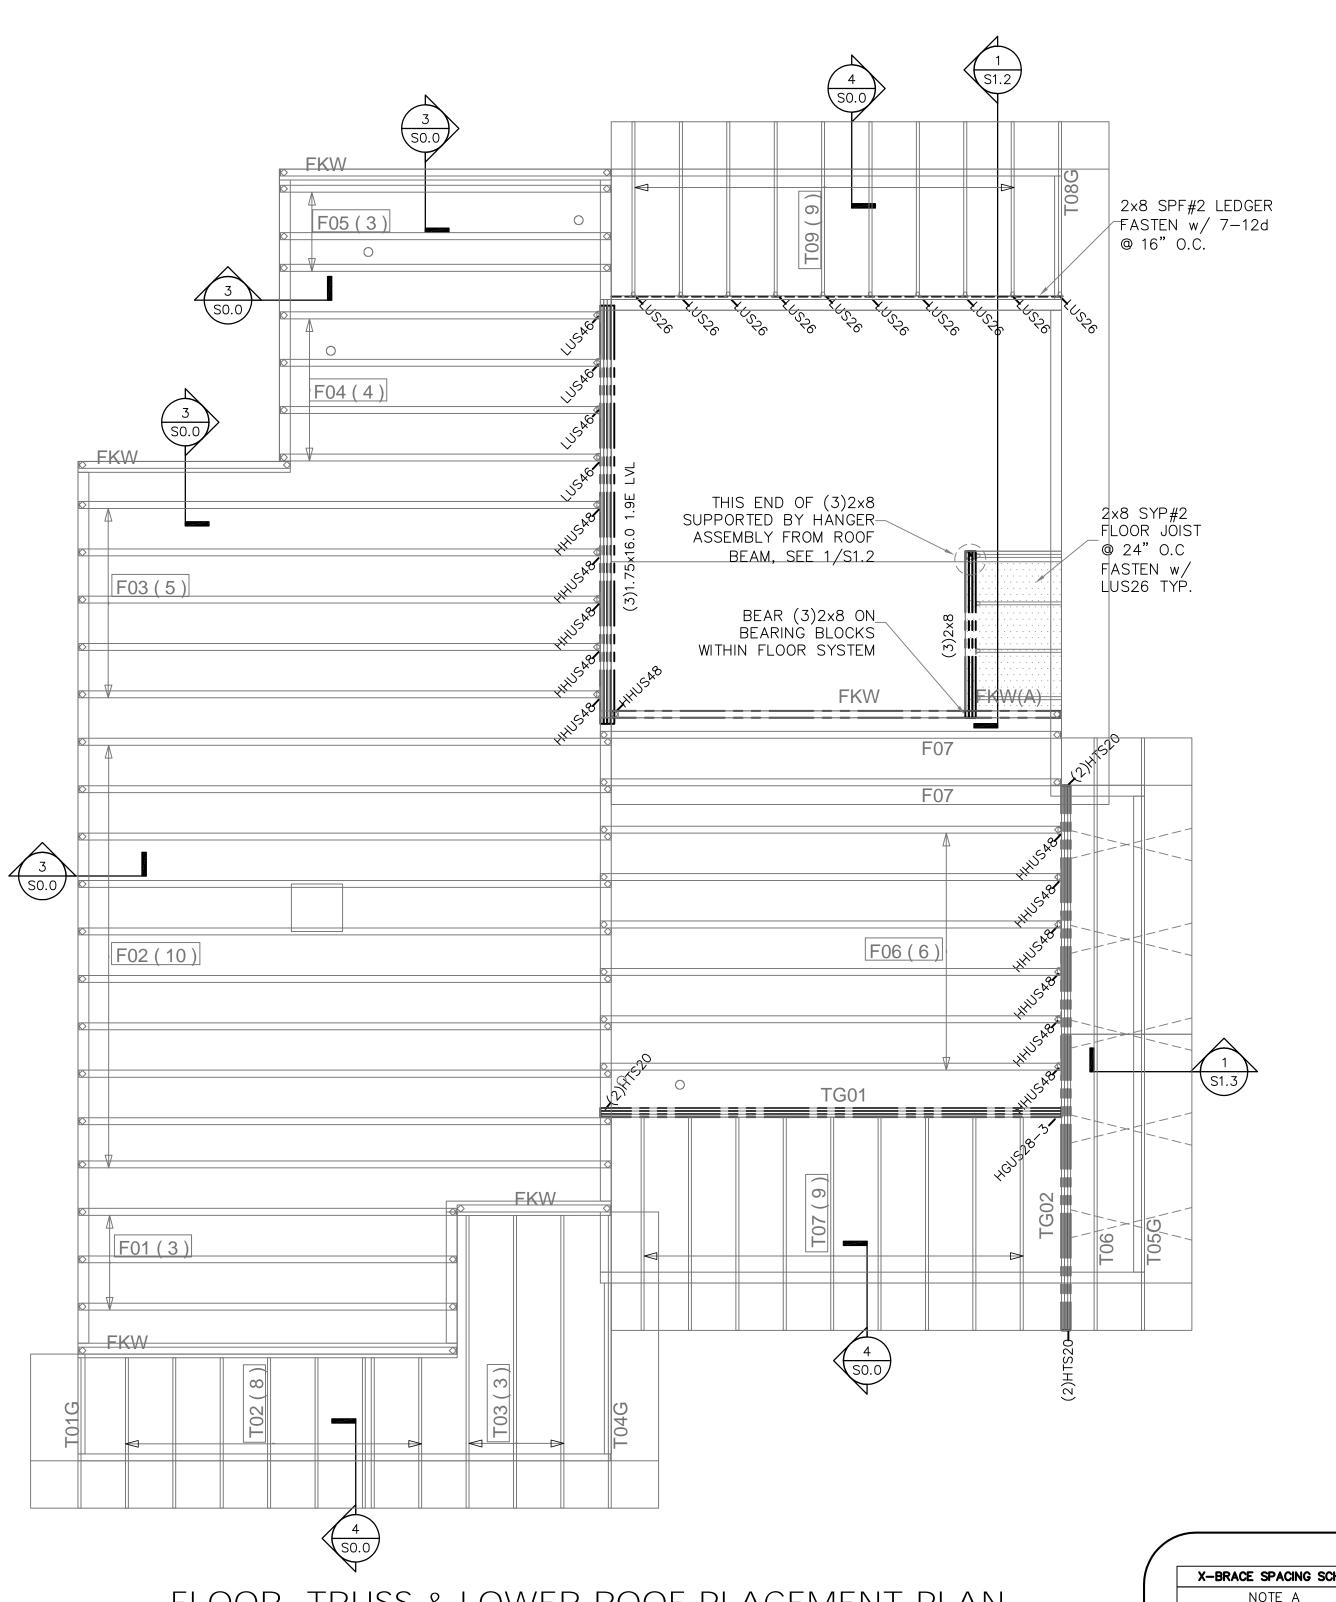
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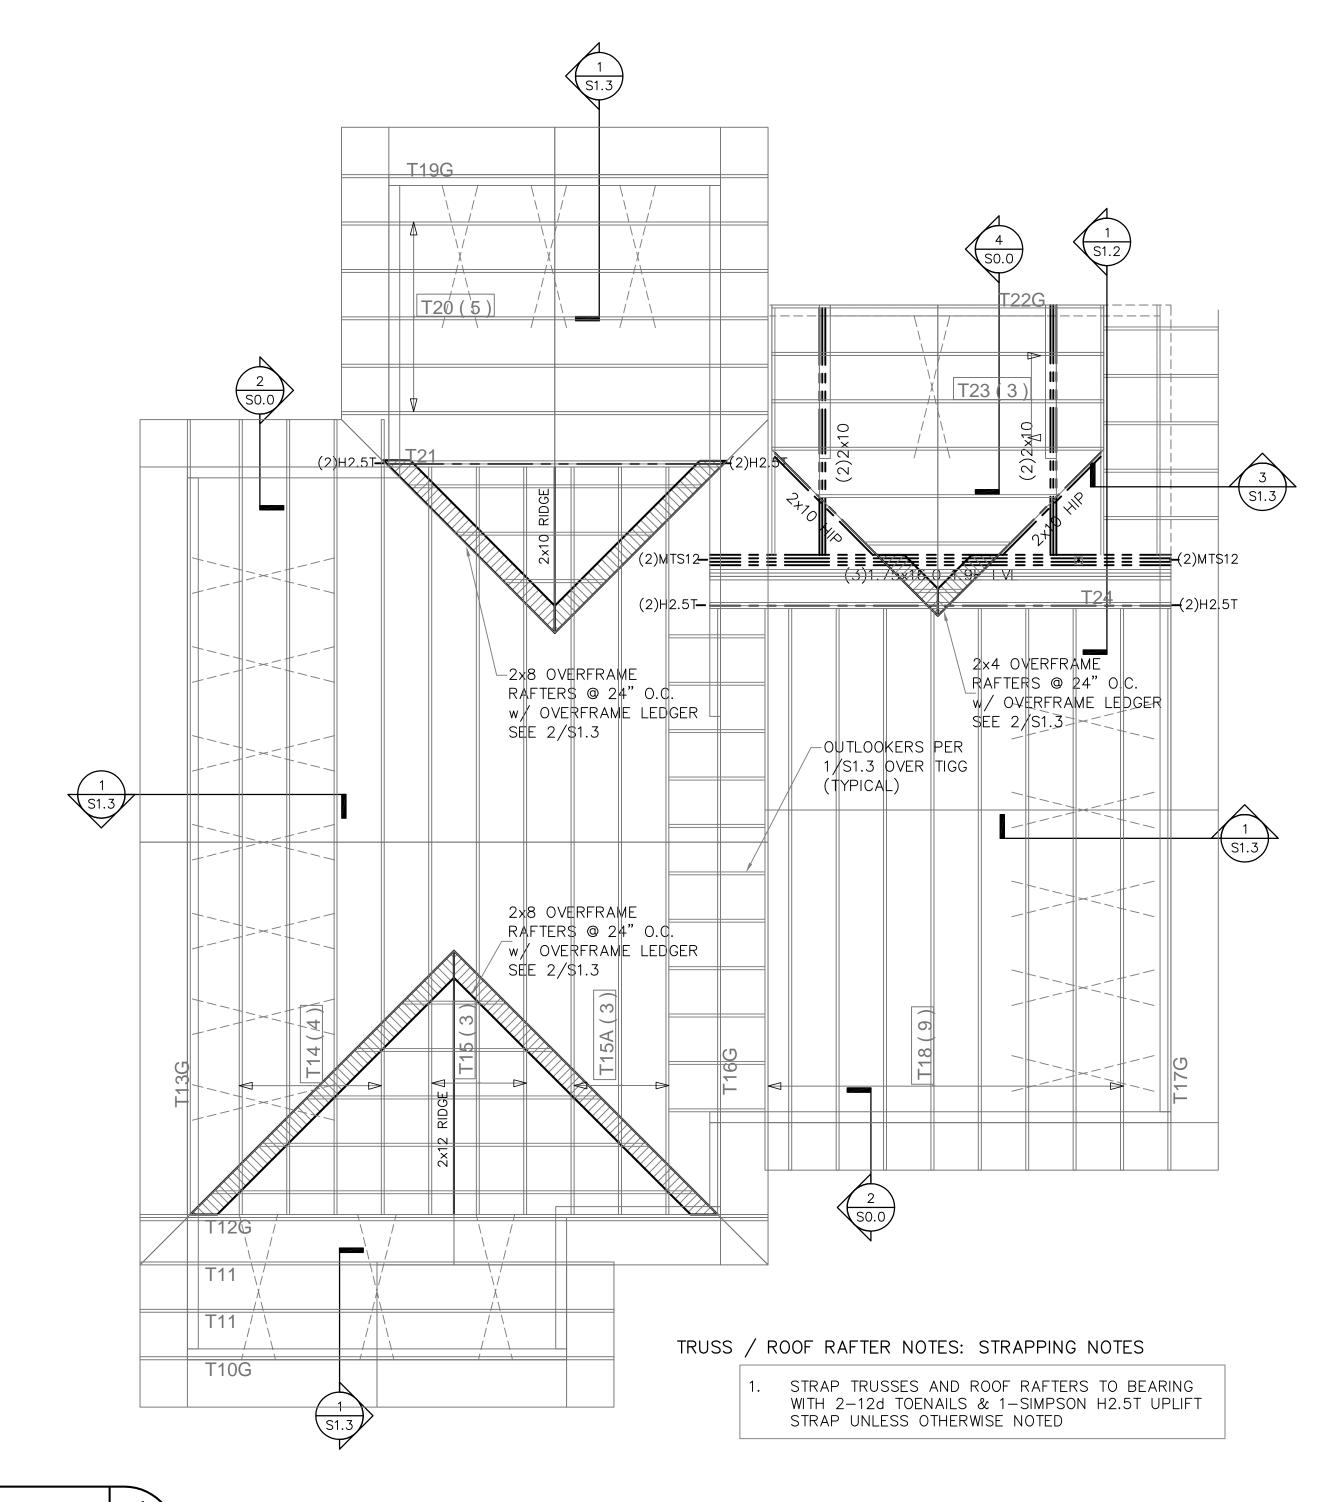
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S1.2

SHEET 4 OF 5





## FLOOR TRUSS & LOWER ROOF PLACEMENT PLAN

SCALE: N.T.S.

1. FASTEN ROOF TRUSS TO TOP PLATE w/ 2-12d TOENAILS AND

SYMBOLS LEGEND

FRAMING PLAN NOTES:
1. FOR TYPICAL ROOF SHEATHING AND FRAMING, SEE

FOR SPECIFIC UPLIFT CONNECTORS, SEE PLAN. MIN.

FOR GENERAL DESIGN SPECIFICATIONS SEE SHEET SO.

WHEN USING (2)H2.5T CLIPS ON  $1\frac{1}{2}$ " WIDE LUMBER, PLACE CLIPS DIAGONALLY ACROSS DOUBLE TOP PLATE FROM EACH OTHER.

DESIGNATES UPLIFT CONNECTION.

UPLIFT CONNECTOR, SEE PLAN.

### BRACING NOTES AND SPECIFICATIONS

1.) ALL BRACING LUMBER SHOWN, EXEPT FOR T-BRACE SHALL BE 1x4 SYP#3 OR BETTER OR 2x4 SPF#2 OR BETTER. (UON)

2.)BRACING LUMBER SHALL INTERSECT THE WEB OF THE BRACED TRUSS, PER DELEGATED TRUSS ENGINEER.

3.)PERMANENT PERMANENT BRACING WHERE NOTED ON TRUSS MFR. SHOP DRAWINGS. THE CONTRACTOR SHALL PROVIDE 1x4 SYP#3 OR BETTER BOTTOM CHORD BRACING PERPENDICULAR TO TRUSS BOTTOM CHORDS AND ATTACHED TO EACH TRUS WITH 2-8d COMMON NAILS. AT GABLE END WALLS PROVIDE DIAGONALS AT END WALLS PROVIDE DIAGONALS (APPROXIMATELY 45%) TO THE ADJACENT EXTERIOR PERPENDICULAR WALL BETWEEN EACH LINE OF BRACING TO FORM A ZIGZAG PATTERN ALL CONSTRUCTED OF THE SAME BRACING MATERIAL. THIS REQUIRMENT IS NOT NECESSARY AT HIP ROOFS. ALSO ALONG EXTERIOR WALLS PARALLEL TO BOTTOM CHORD BRACING PROVIDE DIAGONALS IN THE END SPACE BETWEEN THE WALL AND THE FIRST LINE OF BOTTOM


CHORD BRACING AT A MAXIMUM SPACING OF 20 FEET.


### X-BRACE SPACING SCHEMATIC WALL SHEATHING UP GABLE END TRUSS. LSTA12 @ 24" O.C. ' MIN | W/2 FULL HEIGHT ANCHORS TO EXTEND OVER 2x4 A-A NAILER ADDITIONAL BRACES AS REQ'D., EQUALLY SPACED w/ SPACING OF 5'-8" MAX. H2.5T @ EA. OUTLOOKER\_ PROVIDE BLOCKING FOR TO TRUSS. 2x4 SPF#2 OUTLOOKERS ROOF DECK @ RIDGE. 4-12d TOE NAILS (TYP.)-PROVIDE 2x4 SPF#2 UPRIGHT FROM TOP TO BOT. CHORD OF TRUSS @ EA. X-BRACE (IF VERT. IS NOT PRESENT) 3-16d @ EA. VERT. 2x4 SPF#2 X-BRACE. (TYP.) 0.131x3" TOE NAILS @ 8"O.C. FROM BOT. CHORD OF TRUSS TO DBL. TOP PLATE 2−0.131x3" EA. END — LSTA12 @ 24" 0.C. 2x4x8' SPF#2 LATERAL BRACE EA. X-BRACE w/ 3-16d INTO EA. TRUSS.2x4 SYP#2 BLOCKING AS CEILING - NAILER (NOT CONTINUOUS) ATTACH w/ 0.131x3" @ 8"O.C. STÁG. PLATFORM FRAMED GABLE END

## ROOF TRUSS PLACEMENT PLAN

SCALE: N.T.S.

1. FASTEN ROOF TRUSS TO TOP PLATE w/ 2-12d TOENAILS AND UPLIFT CONNECTOR, SEE PLAN.

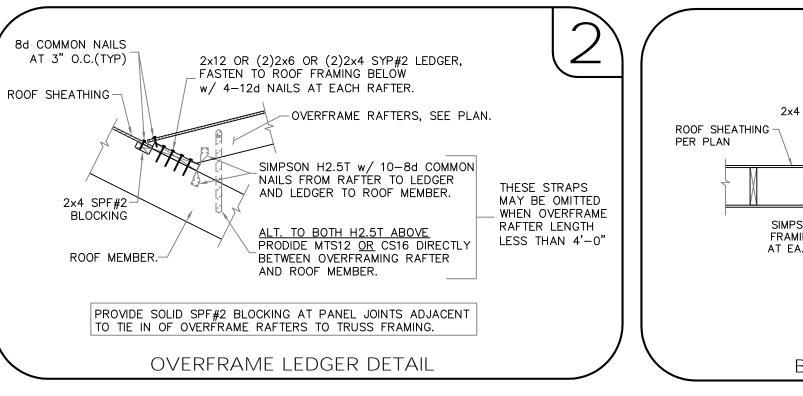

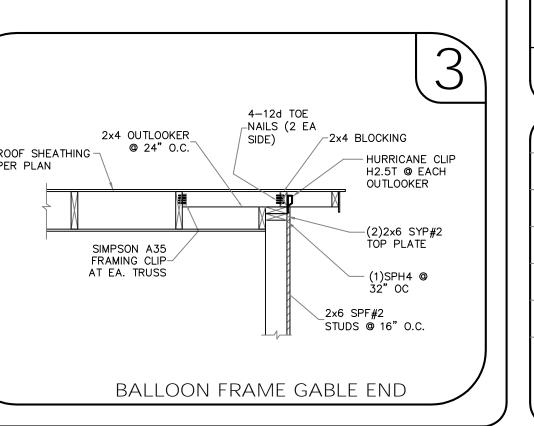

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