



THE CONTRACTOR SHALL BE RESPONSIBLE FOR THE DESIGN/INSTALLATION OF ALL WATER PROOFING.

WOOD FASTENING SCHEDULE		BRICK NOTES / LINTEL SCHD		PLAN LEGEND AND ABBREVIATIONS			
MEMBERS	CONNECTION TYPE	FASTENER	LINTEL DIMENSION	MIN. BRG.	MAX. SPAN	INTERIOR LOAD BEARING WALL	BUILT-UP POST IN THE WALL
TOP PLATE TO TOP PLATE	FACE NAIL	2-GUN NAILS @ 12" STAG.	L3½x3½x1/4	4"	6'-0"	GABLE X-BRACE, SEE DETAIL 11/S2	2.0
TOP PLATE, LAPS/INTERSECTION	FACE NAIL	(2-16d) 3-GUN NAILS	L4x3 ¹ / ₂ "x ¹ / ₄	6"	8'-0"	1	H6-1/2 HEADER SIZE, JACK AND KING STUD QUANTITY.
DBL. TOP PLATE TO STUD	FACE NAIL	(2-16d) 3-GUN NAILS	L5x3 ¹ / ₂ "x ¹ / ₄	6"	10'-0"	DESIGNATES SHEARWALL. THE HIDDEN LINE DESIGNATES SIDE OF	110-1/2 QUANTITY.
RIM JOIST TO TOP PLATE	TOE NAIL	(8d @ 6") GUN NAIL @ 6"	L6x3 ¹ / ₂ "x ¹ / ₄	6"	12'-0"	SW WALL THE SHEARWALL SHEATHING NAU NC. TO BE APPLIED. 8d @ 3/6	
CEILING JOIST TO TOP PLATE	TOE NAIL	(3-8d) 5-GUN NAILS	L7x3 ¹ / ₂ "x ¹ / ₄	6"	16'-0"	NAILING: DESIGNATES 8d COMMONS @ 3" DESIGNATES 8d COMMONS @ 3" O.C. EDGE & 6" O.C. "IN THE	
CEILING JOIST, OVER PARTITIONS	FACE NAIL	(3-16d) 4-GUN NAILS	1. STEEL LINTELS TO BE MINIMAL 36		10 0	FIELD"	
CEILING JOIST TO ROOF RAFTER	FACE NAIL	(6-16d) 8-GUN NAILS	LINTEL MUST HAVE CORROSION	_	BRICK	ADJ — ADJACENT	LG - Long
JOIST/TRUSS TO PLATE	TOE NAIL	(2-16d) 3-GUN NAILS	RESISTANT COATING OF EPOXY BASE PAINT.	D	VENEER	BM — BEAM	MANUF — Manufacture
RAFTER TO PLATE	TOE NAIL	(3-8d) 3-GUN NAILS			WEATHER BARRIER	BOT — BOTTOM BRG — BEARING	MONO — Monolithic OC — On Center
JACK RAFTER TO HIP	TOE NAIL	(3-10d) 4-GUN NAILS	2. LINTEL MORE THAN 8'-0". SHOULI BE LATERALLY SUPPORTED NOT TO)		CMU — CONCRETE MASONRY UNIT	OSB — Oriented Strand Board
ROOF RAFTER TO 2x_ RIDGE BM.	TOE NAIL	(2-16d) 3-GUN NAILS	EXCEED 6 FT. O.C. $w/2-\frac{1}{4}x3$ WD.		\ \	DBL — DOUBLE DIA — DIAMETER	PERP — Perpendicular PRE ENG — Pre Engineered
CONT. HEADER, TWO PIECES	FACE NAIL	16d@ 16" O.C. @ EDGE	SCREWS INTO HEADER PROVIDE A 1/2 VERTICAL SLOTTED HOLE FOR SCREW	"	LINTEL ATTACHMENT	. EA — EACH EE — EACH END	PSF — Pounds per Square Foot PSI — Pounds per Square Inch
CONT. HEADER TO STUD	TOE NAIL	(3-16d) 4-GUN NAILS		. 4	SEE NOTE 2	EOR — ENGINEER OF RECORD	PT — PRESSURE TREATED
STUD TO SOLE PLATE	TOE NAIL	(3-16d) 4-GUN NAILS	3. BRICK VENEER ATTACHMENT: HORIZONTAL TIES @ 24" O.C., VERT.	1-8	 	EQ — EQUAL EXT — EXTERIOR	QT — Quick Tie REINF — Reinforce
SOLE PLATE TO JOIST/BLOCKING	FACE NAIL	(16d @ 16") GUN NAIL @ 8"	TIES @ 12" O.C (FOR 110mph	HEADER,_	FLASHING	FBC — FLORIDA BUILDING CODE FDN — FOUNDATION	SF — Square Foot SPF —Spruce Pine Fur
NAIL SP $3"x0.131" \emptyset = GUN NAILS$ $2"x0.113" \emptyset = 6d$ $3"x0.148" \emptyset = 10d$ $1\frac{1}{2}"x0.148" \emptyset = 10dx1\frac{1}{2}"$	$2\frac{1}{2}$ ": $3\frac{1}{2}$ ":	113"ø = RINK SHANK (0.131"ø = 8d (0.162"ø = 16d (0.131"ø = 8dx1½"	WIND-ZONE VERT. TIES @ 16" O.C.). AT ALL OPENINGS SPACE TIES WITHIN 12" OF OPENINGS. PROVIDE $\frac{3}{16}$ " Ø WEI HOLES @ 33" O.C. IMMEDIATELY ABOFLASHING.	EP VE <u>S</u> [BRICK LINTEL, SEE SCHEDULE ECTION VIEW BRICK LINTEL	FDN — FOUNDATION FT — FOOT FTG — FOOTING HDR — HEADER HORIZ — HORIZONTAL LBS — POUNDS	SPF — Spruce Pine Fur SYP — Southern Yellow Pine THRU — Through TYP — Typical UON — Unless Otherwise Noted VERT — Vertical WWF — Welded Wire Fabric

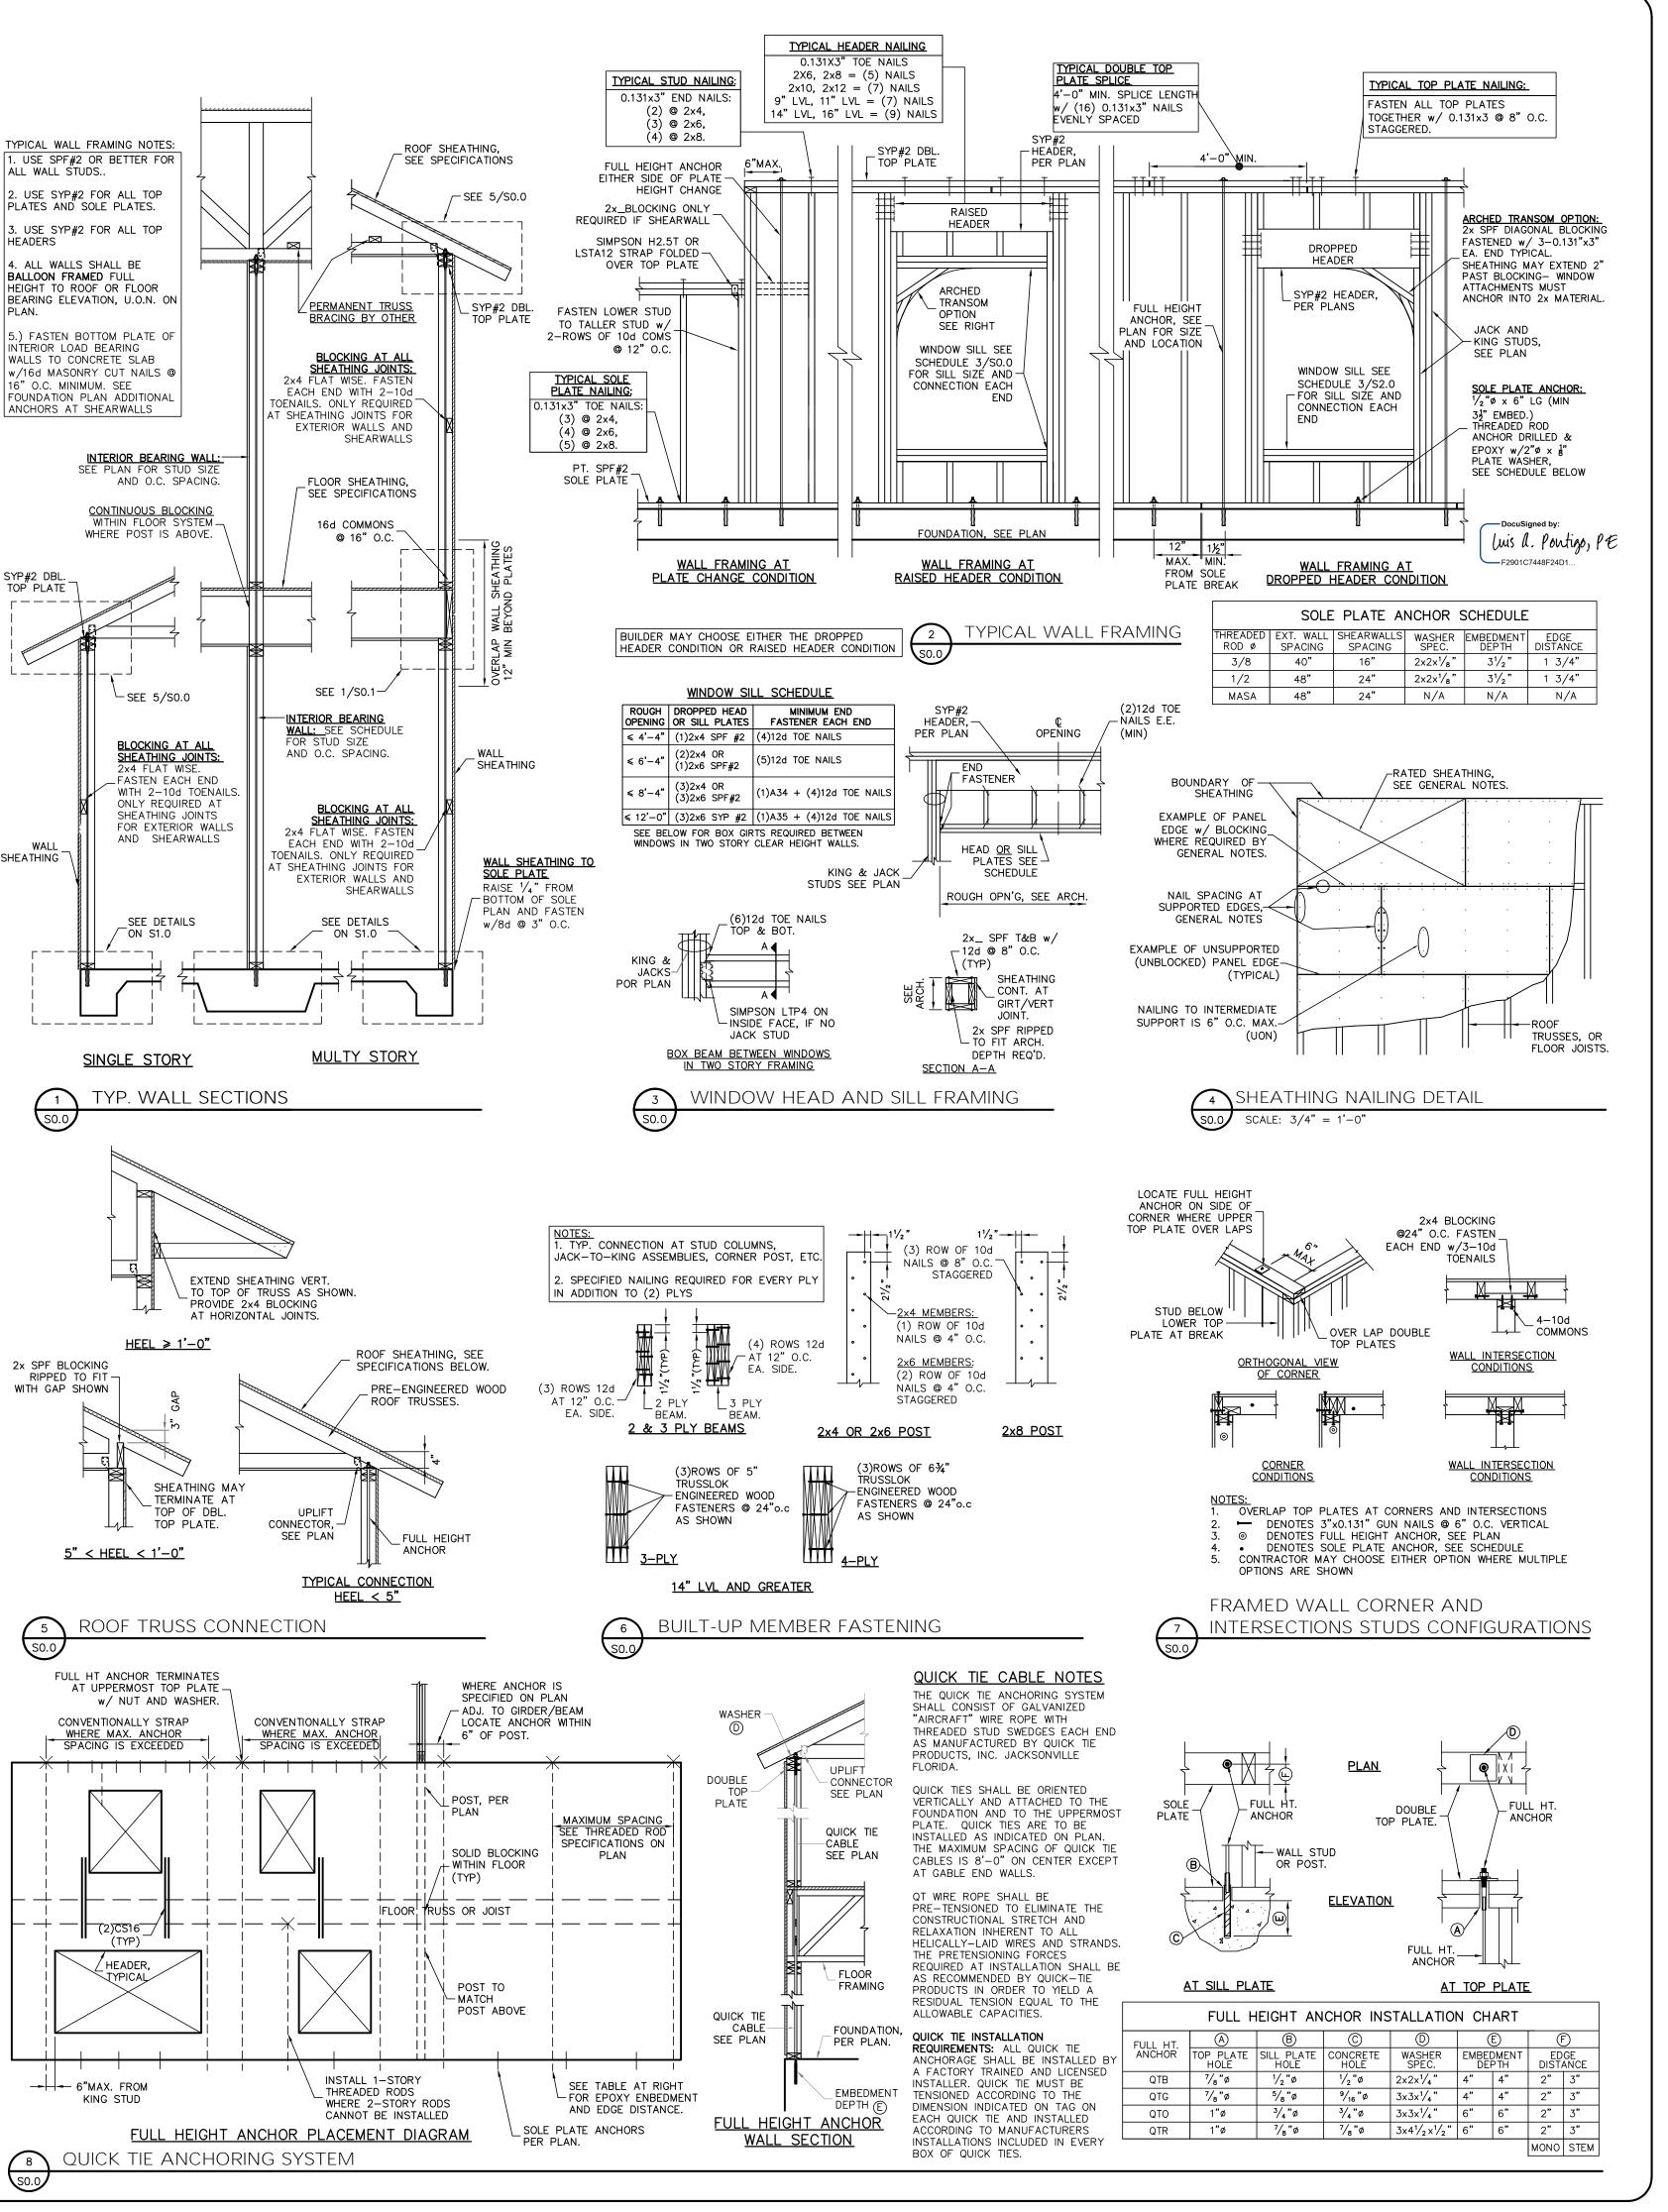


Lou Pontigo and Associates, Inc.

420 Osceola Avenue Jax. Beach, Florida 32250 Ph. 242-0908 Fax. 241-9557 FL: CA # 8344 SC: CA# 3579

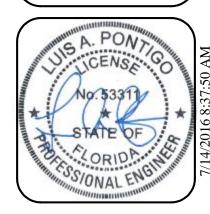

Luis A. Pontigo, PE FL PE#53311

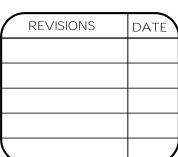

FIFI D AT TERATION ONTIGO & ASSOCIATES PRIOR TO MODIFICATIONS WHICH MAY VAR ROM THE INTENT OF THE ORIGIN. INSTRUCTION DOCUMENTS, AN EING APPROVED BY LOU PONTIG

ADDITIONAL ENGINEERING OF INSPECTION FEES

~ \Box

DESIGN AND **GENERAL**

UNCLEAR REFER TO THE


CONTACT THE E.O.R.

PLAN NAME SPEC HOME DESIGN/DRAWN/CHECKED CS / JB / LAP

07.13.16 SCALE AS NOTED LPA No DRBD-16-00465 CONTROL No.


SHEET SHEET 1 OF 10

6269

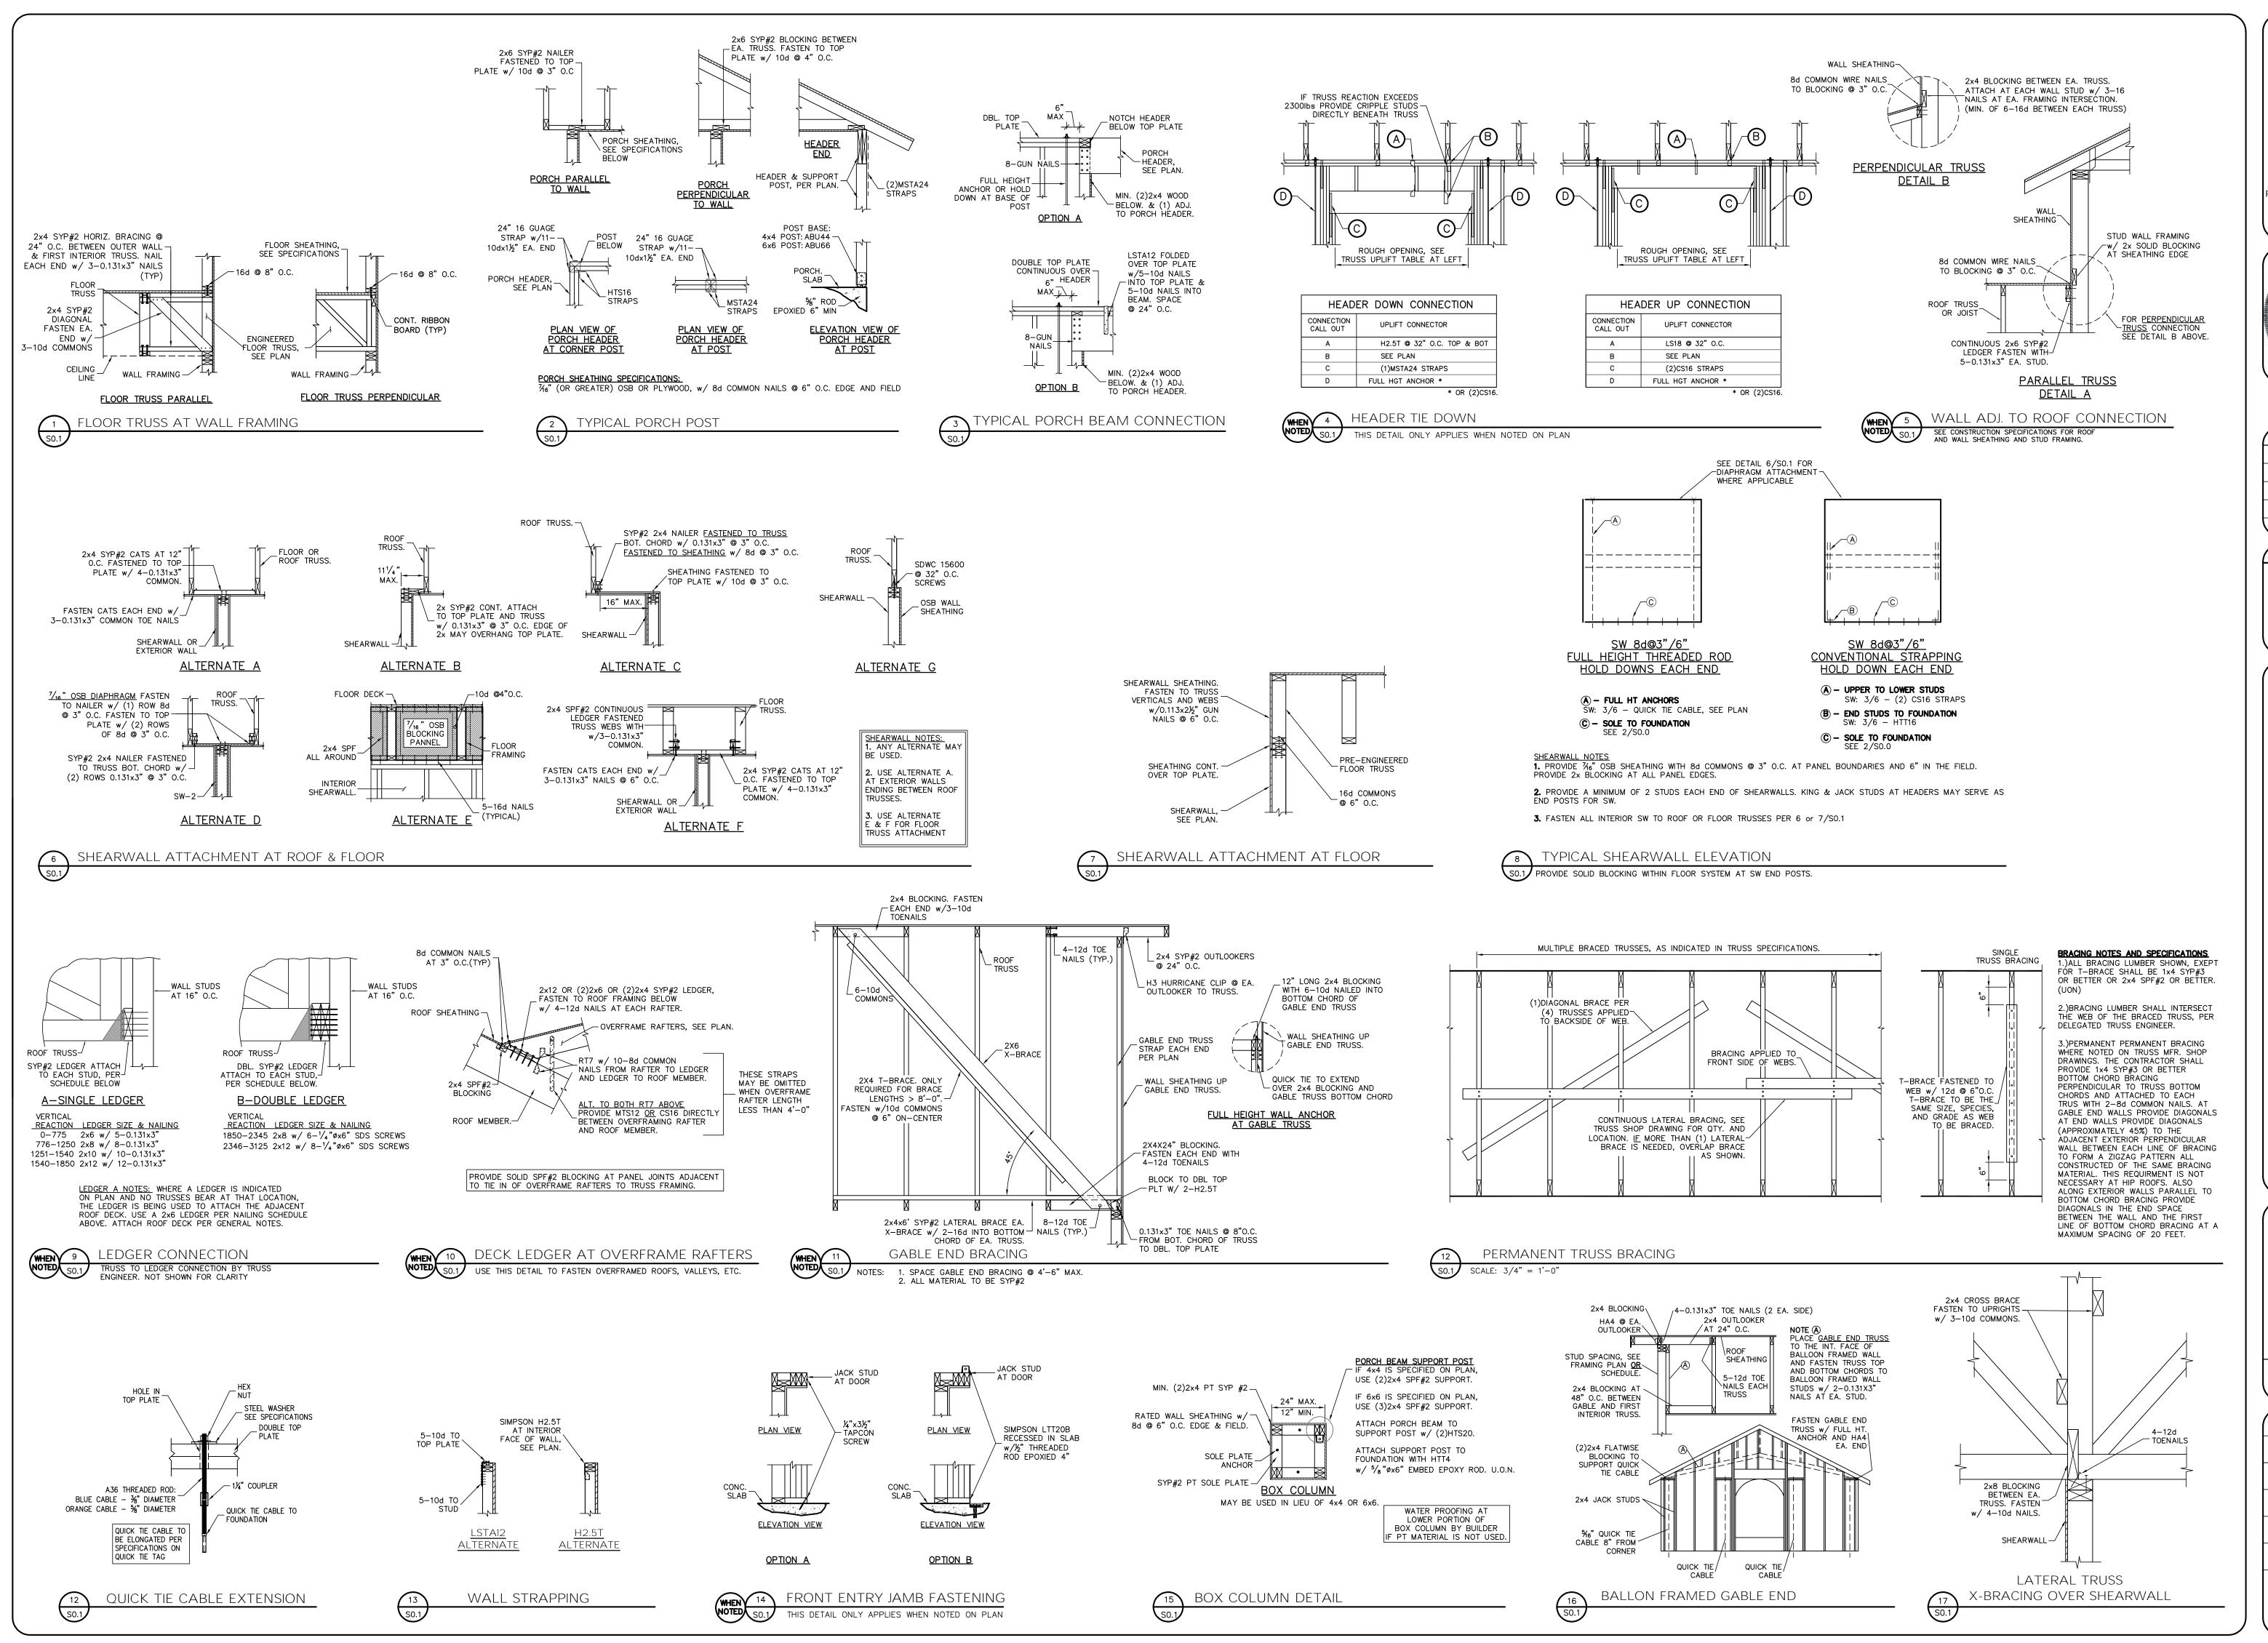

Lou Pontigo and Associates, Inc. 420 Osceola Avenue

Jax. Beach, Florida 32250 Ph. 242-0908 Fax. 241-9557 FL: CA # 8344 SC: CA# 3579

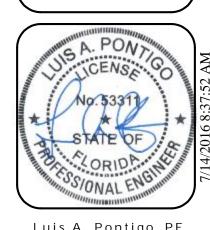

Luis A. Pontigo, PE FL PE#53311

REVISIONS

FIFLD ALTERATION MODIFICATIONS WHICH MAY VAI ONSTRUCTION DOCUMENTS, AN BEING APPROVED BY LOU PONTIG ADDITIONAL ENGINEERING OF

INSPECTION FEES.

TYPICAL FRAMING DETAILS

 \Box


UNCLEAR REFER TO THE


CONTACT THE E.O.R.

PLAN NAME SPEC HOME DESIGN/DRAWN/CHECKED CS / JB / LAP 07.13.16

SCALE AS NOTED LPA No. DRBD-16-00465 CONTROL No. 6269 SHEET

SHEET 2 OF 10

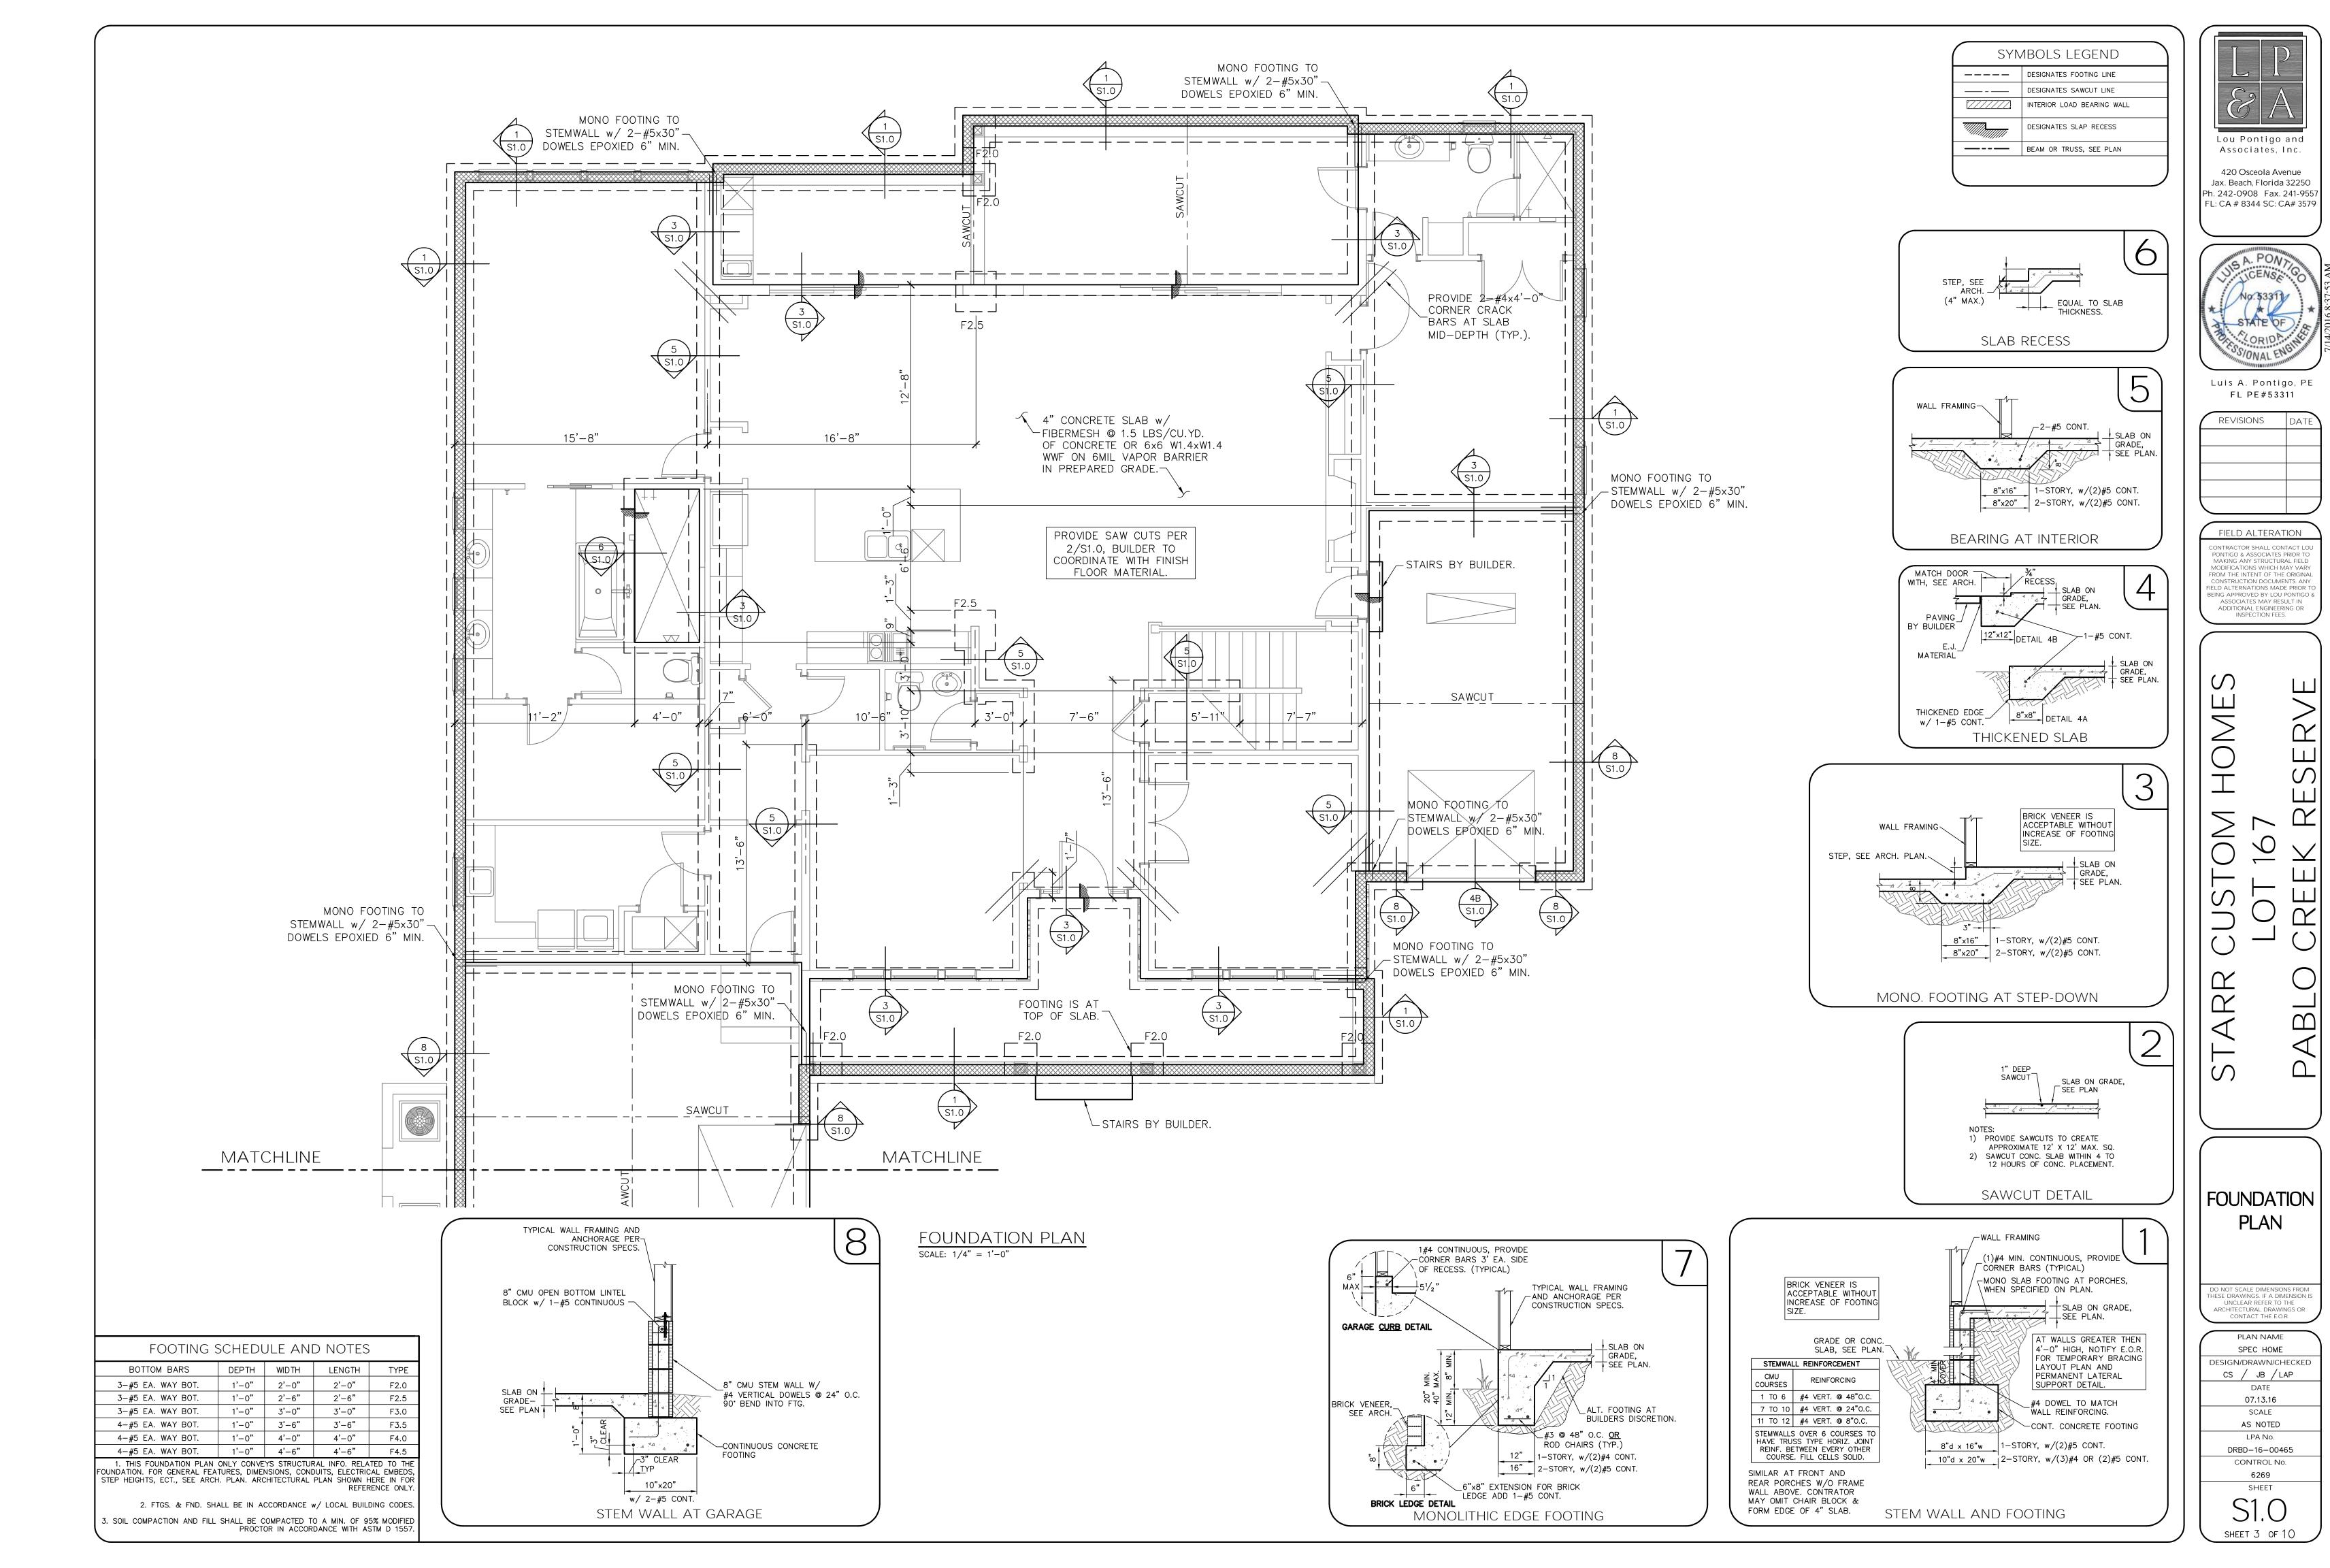

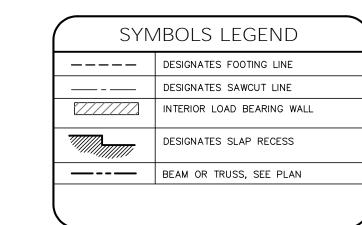



420 Osceola Avenue Jax. Beach, Florida 32250 Ph. 242-0908 Fax. 241-9557 FL: CA # 8344 SC: CA# 3579



Luis A. Pontigo, PE FL PE#53311

REVISIONS	DATE

FIELD ALTERATION

CONTRACTOR SHALL CONTACT LOU PONTIGO & ASSOCIATES PRIOR TO MAKING ANY STRUCTURAL FIELD MODIFICATIONS WHICH MAY VARY FROM THE INTENT OF THE ORIGINAL CONSTRUCTION DOCUMENTS. ANY FIELD ALTERNATIONS MADE PRIOR TO BEING APPROVED BY LOU PONTIGO & ASSOCIATES MAY RESULT IN ADDITIONAL ENGINEERING OR INSPECTION FEES.


FOUNDATION PLAN

DO NOT SCALE DIMENSIONS FROM THESE DRAWINGS. IF A DIMENSION IS UNCLEAR REFER TO THE ARCHITECTURAL DRAWINGS OR CONTACT THE E.O.R.

PLAN NAME SPEC HOME DESIGN/DRAWN/CHECKED CS / JB / LAP 07.13.16


SCALE AS NOTED LPA No.

DRBD-16-00465 CONTROL No. 6269 SHEET

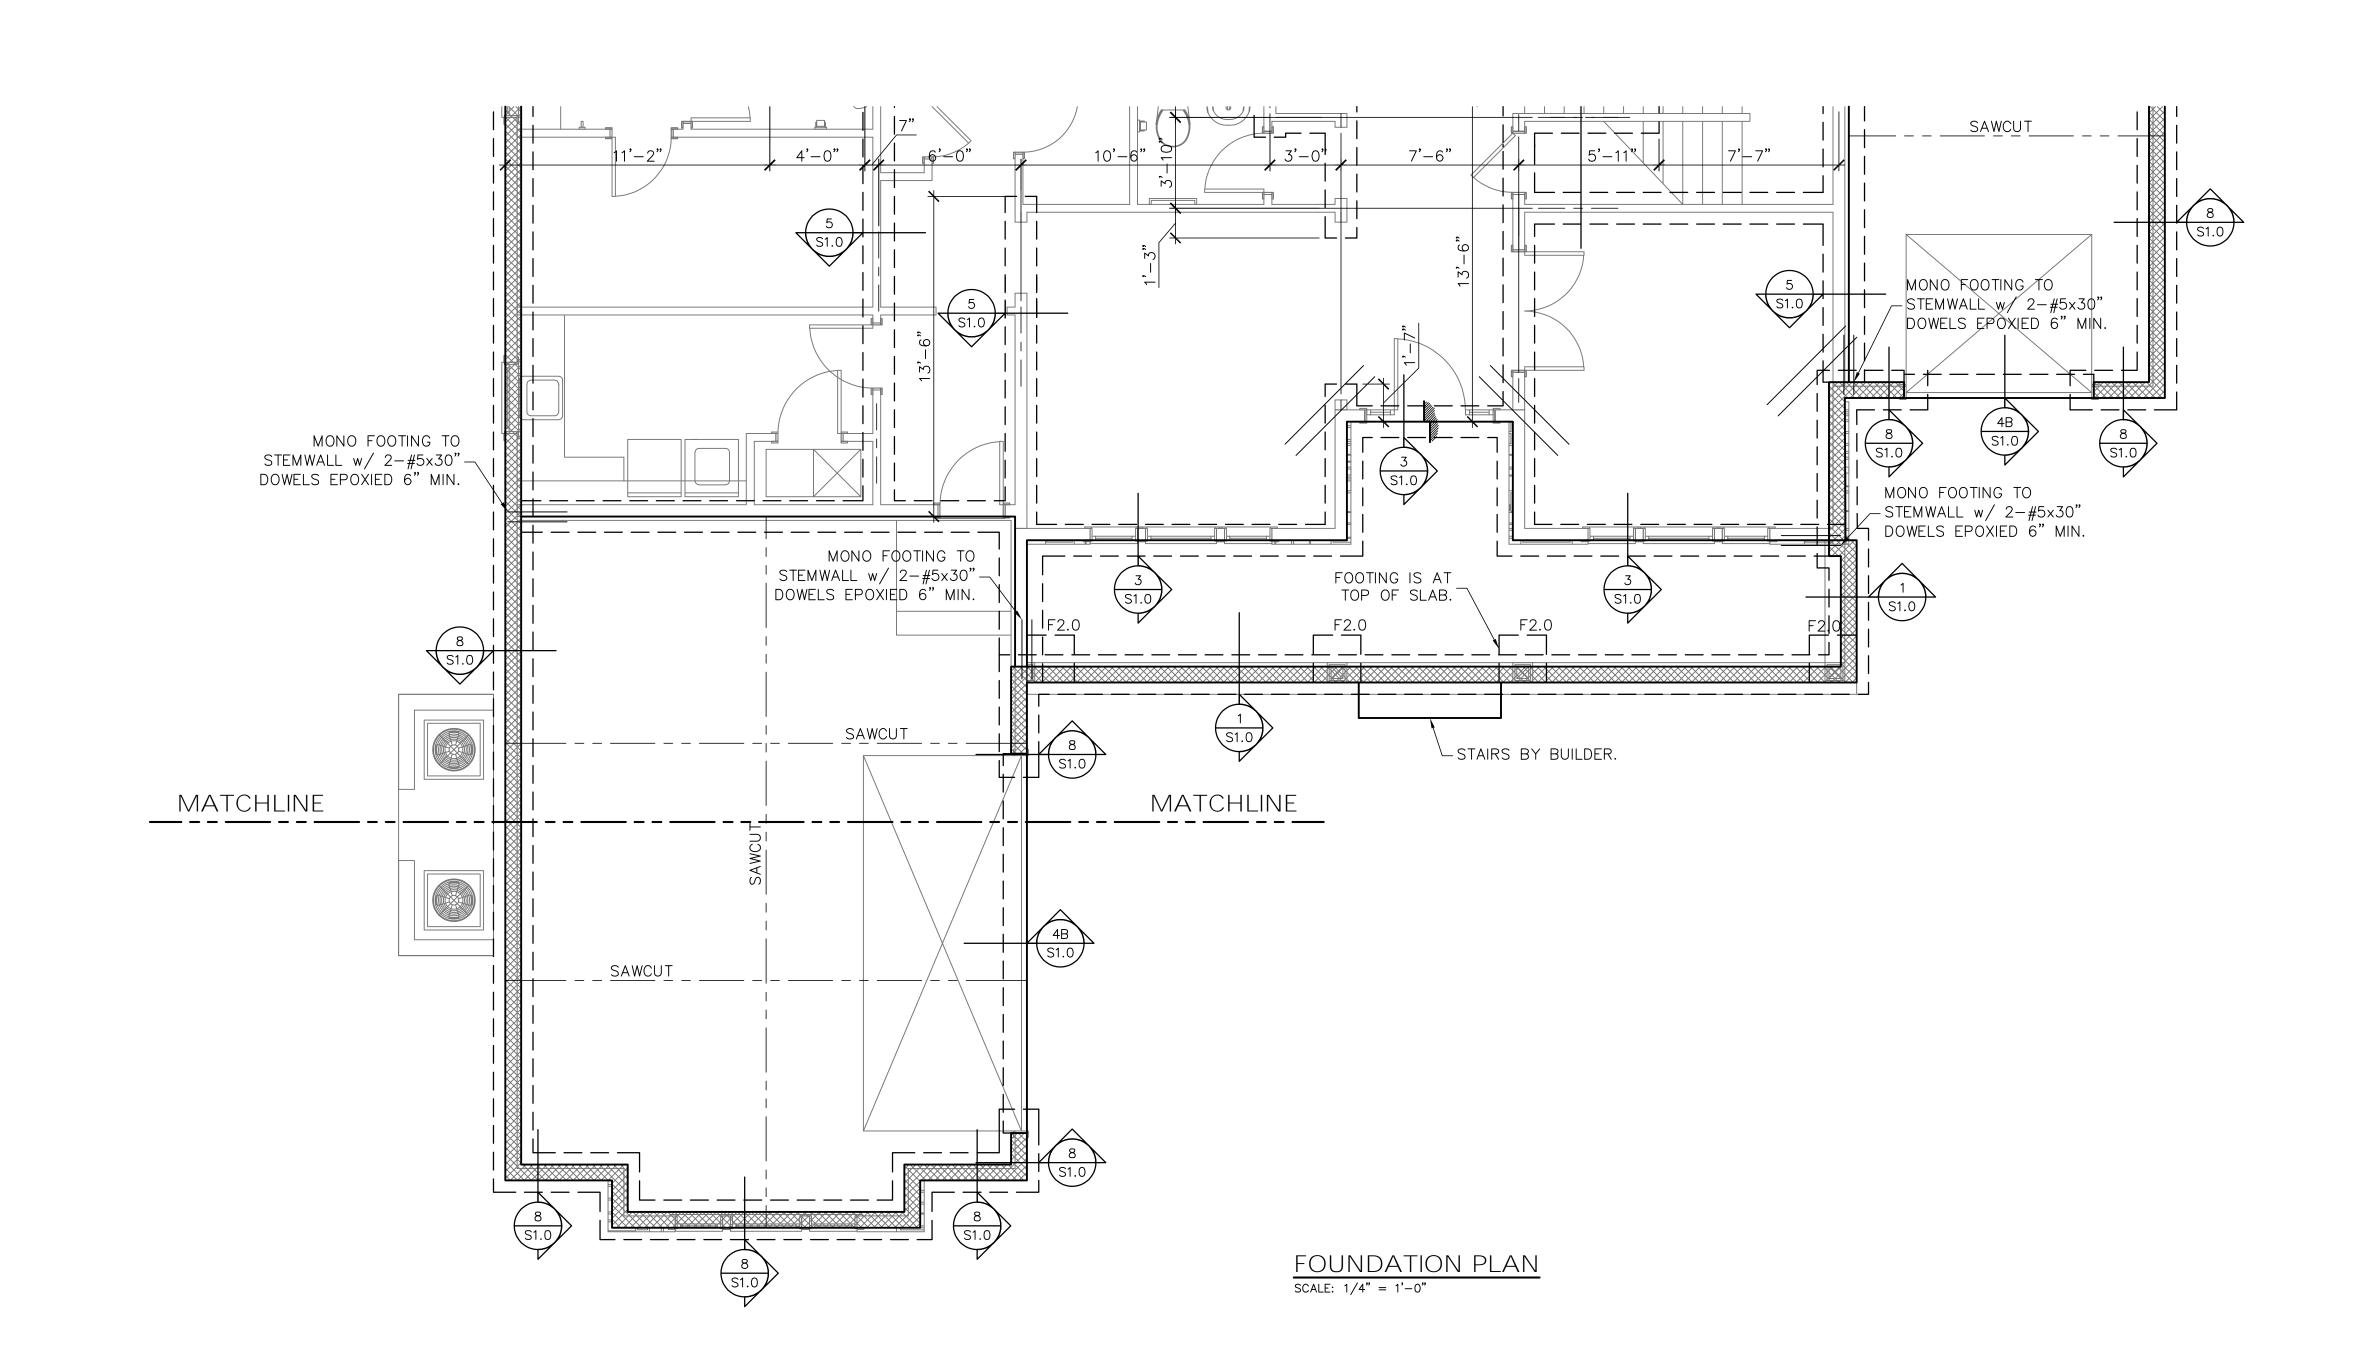


BOTTOM BARS	DEPTH	WIDTH	LENGTH	TYPE
3-#5 EA. WAY BOT. 3-#5 EA. WAY BOT.	1'-0" 1'-0"	2'-0"	2'-0" 2'-6"	F2.0 F2.5
3-#5 EA. WAY BOT.	1'-0"	3'-0"	3'-0"	F3.0
4-#5 EA. WAY BOT.	1'-0"	3'-6"	3'-6"	F3.5
4-#5 EA. WAY BOT.	1'-0"	4'-0"	4'-0"	F4.0
4-#5 EA. WAY BOT.	1'-0"	4'-6"	4'-6"	F4.5
1. THIS FOUNDATION PLAN ONLY CONVEYS STRUCTURAL INFO. RELATED TO THE FOUNDATION. FOR GENERAL FEATURES, DIMENSIONS, CONDUITS, ELECTRICAL EMBEDS, STEP HEIGHTS, ECT., SEE ARCH. PLAN. ARCHITECTURAL PLAN SHOWN HERE IN FOR REFERENCE ONLY.				

2. FTGS. & FND. SHALL BE IN ACCORDANCE w/ LOCAL BUILDING CODES. 3. SOIL COMPACTION AND FILL SHALL BE COMPACTED TO A MIN. OF 95% MODIFIED PROCTOR IN ACCORDANCE WITH ASTM D 1557

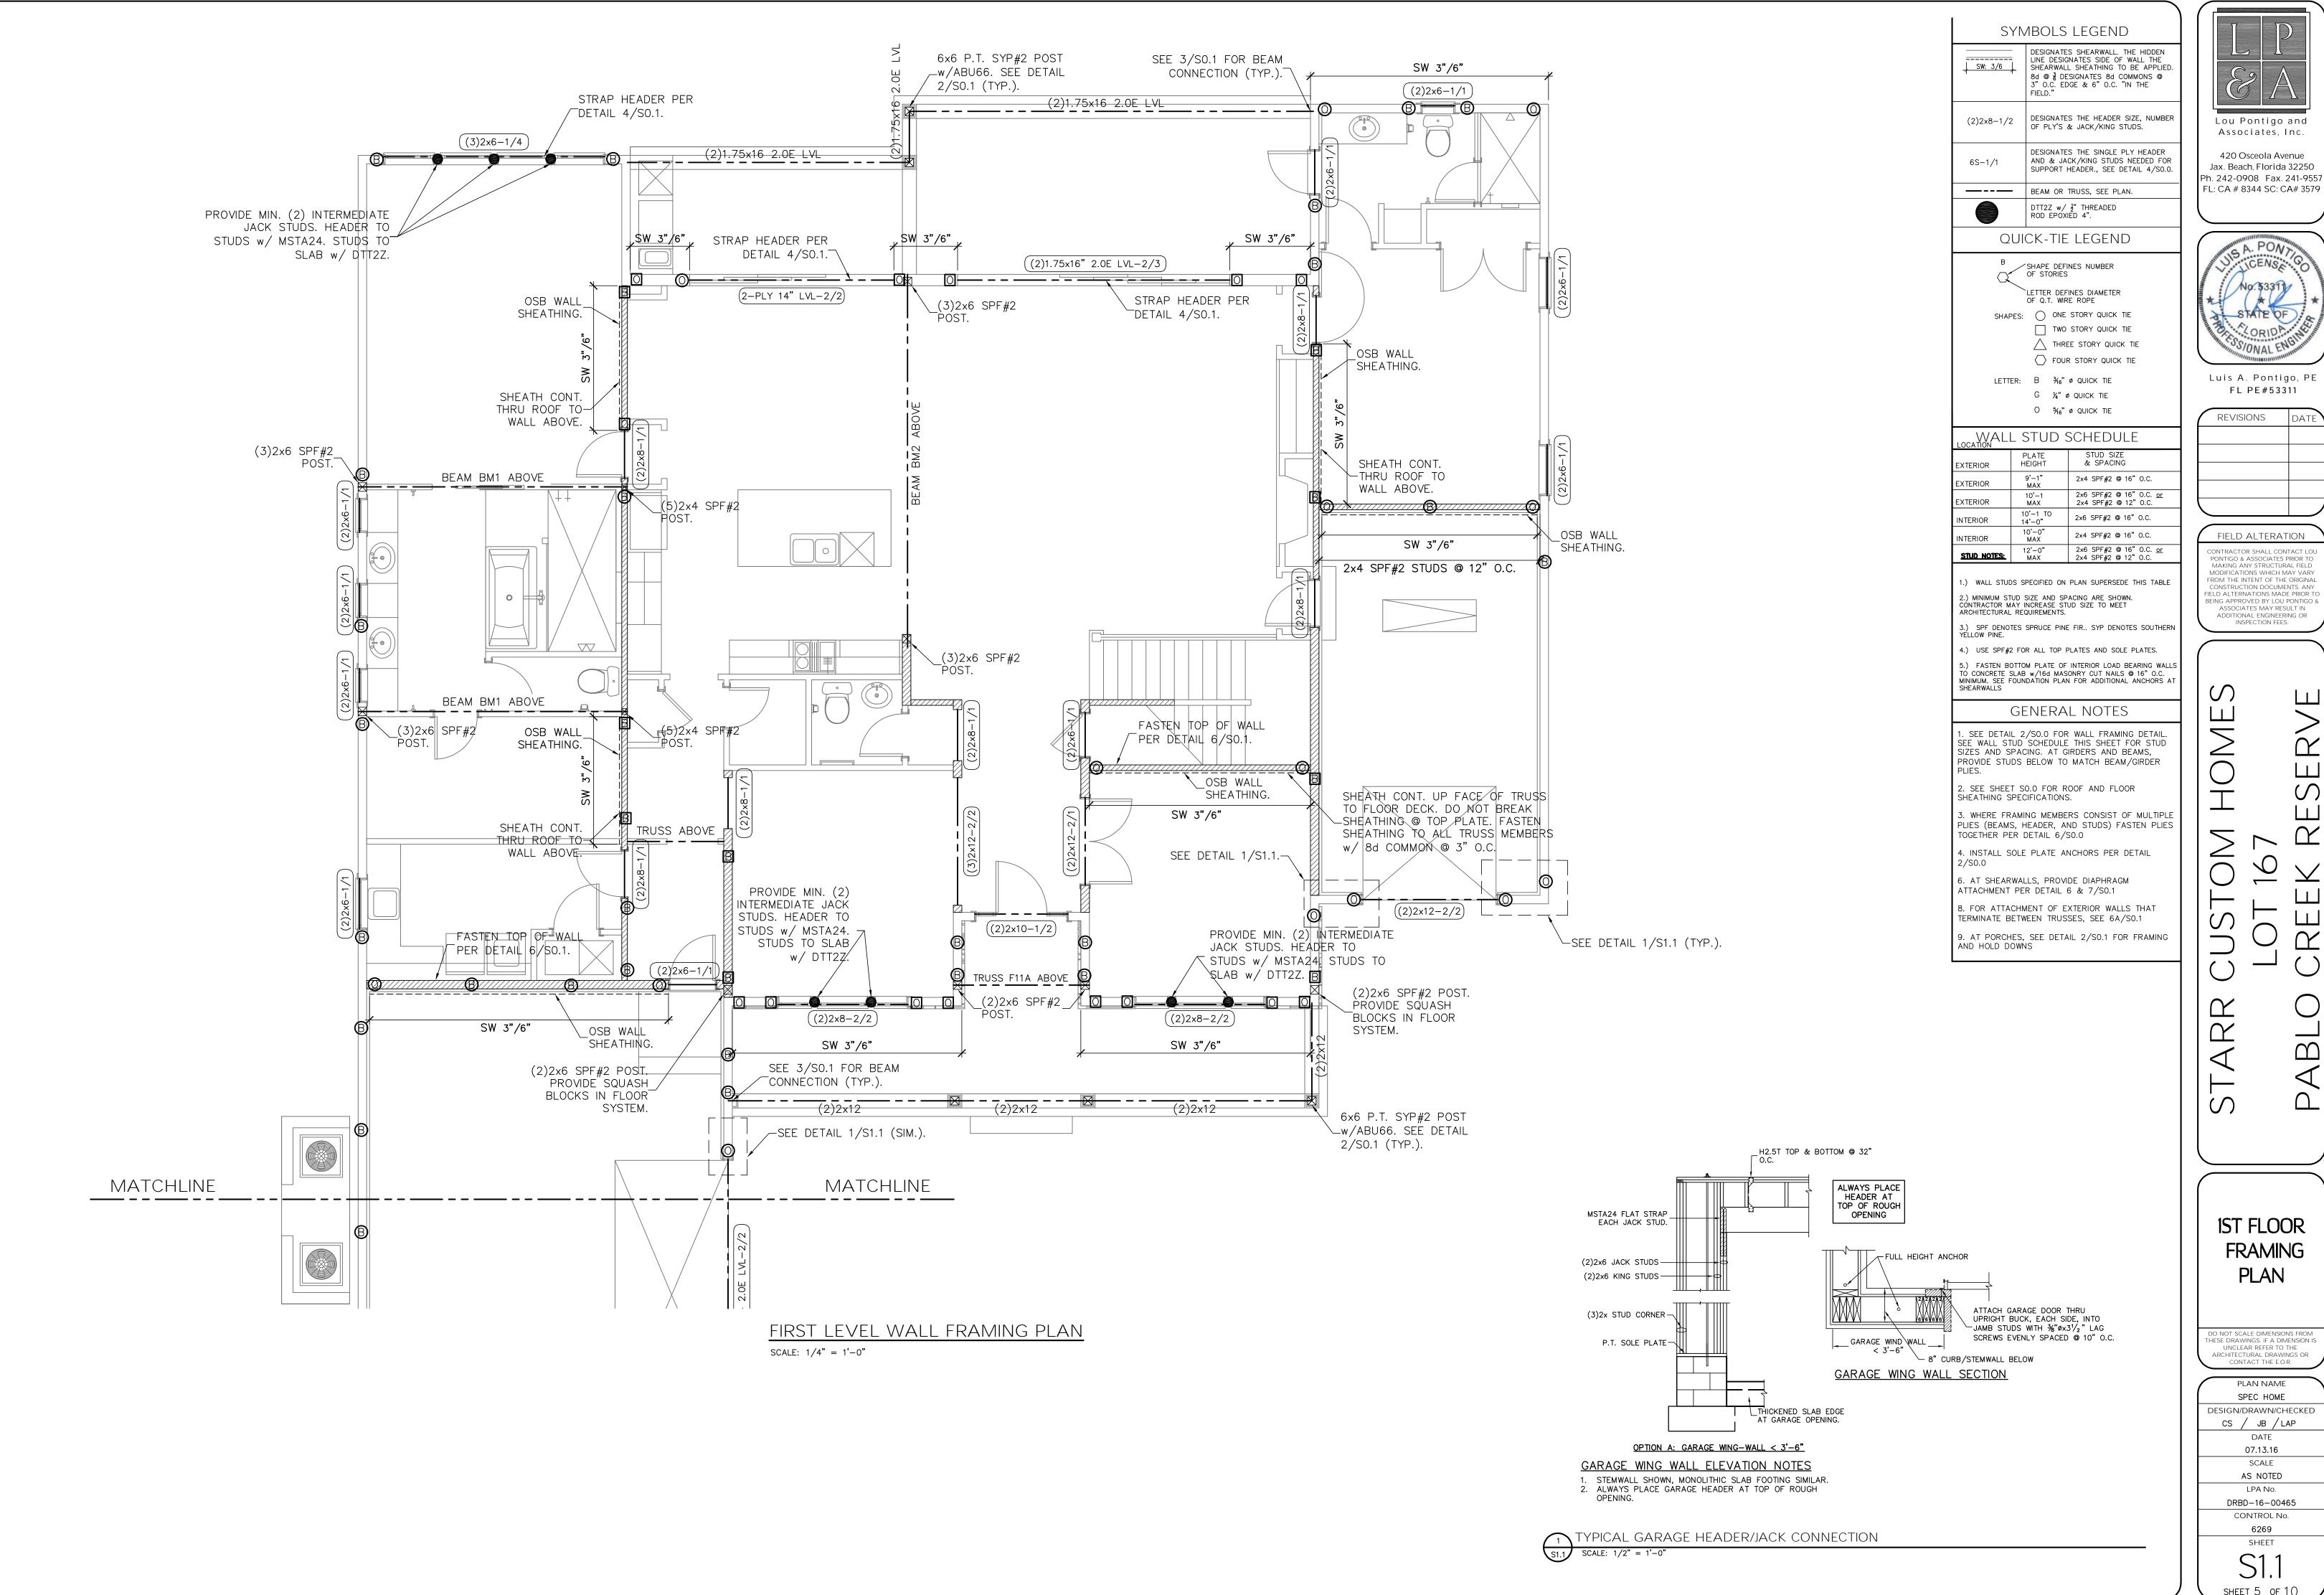

Lou Pontigo and Associates, Inc. 420 Osceola Avenue Jax. Beach, Florida 32250 Ph. 242-0908 Fax. 241-9557

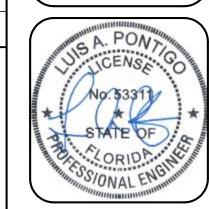

Luis A. Pontigo, PE FL PE#53311

REVISIONS

FIFLD ALTERATION

PONTIGO & ASSOCIATES PRIOR TO MODIFICATIONS WHICH MAY VAR ROM THE INTENT OF THE ORIGINA ONSTRUCTION DOCUMENTS, AN' BEING APPROVED BY LOU PONTIGO ASSOCIATES MAY RESULT IN ADDITIONAL ENGINEERING OR INSPECTION FEES.

IST FLOOR FRAMING PLAN


OO NOT SCALE DIMENSIONS FROM HESE DRAWINGS. IF A DIMENSION IS UNCLEAR REFER TO THE ARCHITECTURAL DRAWINGS OF CONTACT THE E.O.R.

PLAN NAME SPEC HOME DESIGN/DRAWN/CHECKED CS / JB / LAP 07.13.16 SCALE AS NOTED LPA No.

DRBD-16-00465 CONTROL No. 6269

SHEET

SHEET 5 OF 10

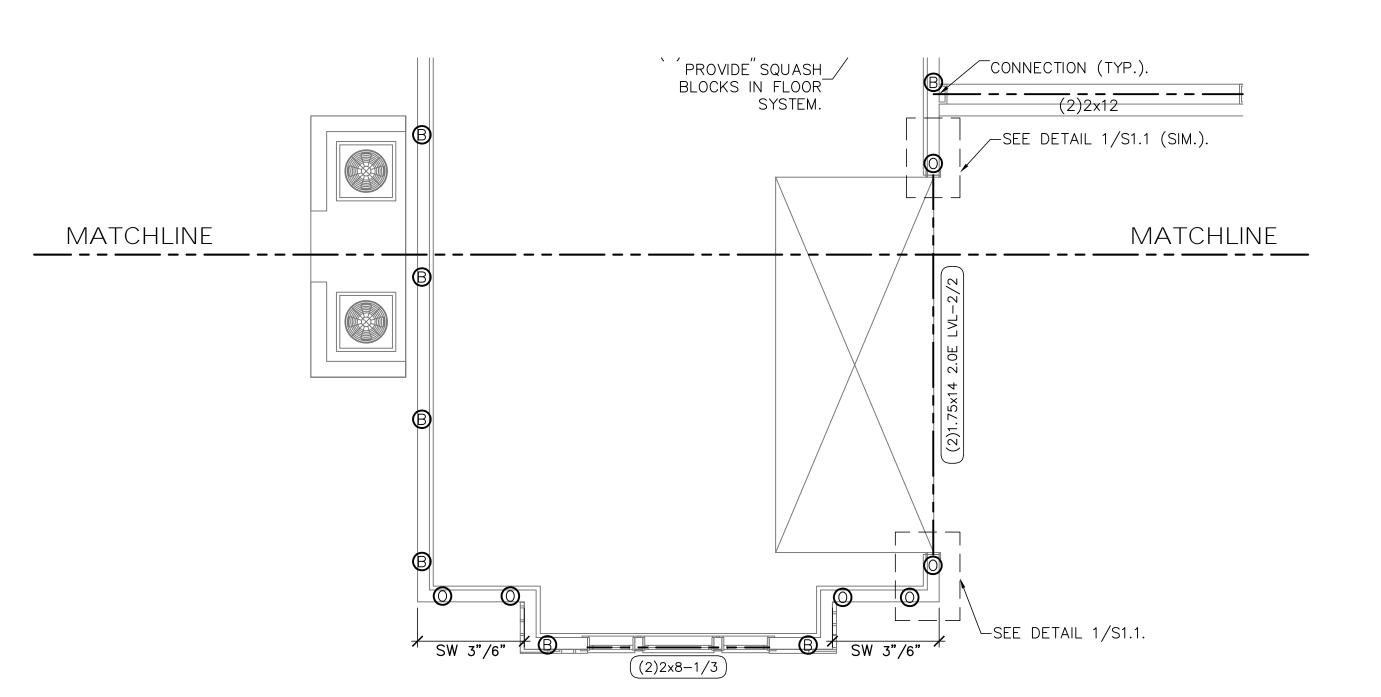

FIRST LEVEL WALL FRAMING PLAN

SCALE: 1/4" = 1'-0"

SYMBOLS LEGEND

DESIGNATES SHEARWALL. THE HIDDEN LINE DESIGNATES SIDE OF WALL THE SHEARWALL SHEATHING TO BE APPLIED.

8d @ \(\frac{1}{8} \) DESIGNATES 8d COMMONS @ 3" O.C. EDGE & 6" O.C. "IN THE FIELD."

(2)2x8-1/2 DESIGNATES THE HEADER SIZE, NUMBER OF PLY'S & JACK/KING STUDS.

DESIGNATES THE SINGLE PLY HEADER
AND & JACK/KING STUDS NEEDED FOR
SUPPORT HEADER., SEE DETAIL 4/SO.O.

BEAM OR TRUSS, SEE PLAN.

DTT2Z W/ ½" THREADED ROD EPOXIED 4".

QUICK-TIE LEGEND

B SHAPE DEFINES NUMBER OF STORIES

LETTER DEFINES DIAMETER
OF Q.T. WIRE ROPE
SHAPES: ONE STORY QUICK TIE

TWO STORY QUICK TIE

FOUR STORY QUICK TIE

LETTER: B 3/6" Ø QUICK TIE

G 1/4" & QUICK TIE

O 5/6" & QUICK TIE

WALI	WALL STUD SCHEDULE				
EXTERIOR	PLATE HEIGHT	STUD SIZE & SPACING			
EXTERIOR	9'-1" MAX	2x4 SPF#2 @ 16" O.C.			
EXTERIOR	10'-1 MAX	2x6 SPF#2 @ 16" O.C. <u>or</u> 2x4 SPF#2 @ 12" O.C.			
INTERIOR	10'-1 TO 14'-0"	2x6 SPF#2 @ 16" O.C.			
INTERIOR	10'-0" MAX	2x4 SPF#2 @ 16" O.C.			
STUD NOTES:	12'-0" MAX	2x6 SPF#2 @ 16" O.C. <u>or</u> 2x4 SPF#2 @ 12" O.C.			

WALL STUDS SPECIFIED ON PLAN SUPERSEDE THIS TABLE

2.) MINIMUM STUD SIZE AND SPACING ARE SHOWN.
CONTRACTOR MAY INCREASE STUD SIZE TO MEET
ARCHITECTURAL REQUIREMENTS.

3.) SPF DENOTES SPRUCE PINE FIR.. SYP DENOTES SOUTHERN YELLOW PINE.

4.) USE SPF#2 FOR ALL TOP PLATES AND SOLE PLATES.

5.) FASTEN BOTTOM PLATE OF INTERIOR LOAD BEARING WALLS TO CONCRETE SLAB w/16d MASONRY CUT NAILS @ 16" O.C. MINIMUM. SEE FOUNDATION PLAN FOR ADDITIONAL ANCHORS AT SHEARWALLS

GENERAL NOTES

1. SEE DETAIL 2/SO.O FOR WALL FRAMING DETAIL. SEE WALL STUD SCHEDULE THIS SHEET FOR STUD SIZES AND SPACING. AT GIRDERS AND BEAMS, PROVIDE STUDS BELOW TO MATCH BEAM/GIRDER PLIES.

2. SEE SHEET SO.O FOR ROOF AND FLOOR SHEATHING SPECIFICATIONS.

3. WHERE FRAMING MEMBERS CONSIST OF MULTIPLE PLIES (BEAMS, HEADER, AND STUDS) FASTEN PLIES TOGETHER PER DETAIL 6/SO.0

4. INSTALL SOLE PLATE ANCHORS PER DETAIL 2/S0.0

6. AT SHEARWALLS, PROVIDE DIAPHRAGM ATTACHMENT PER DETAIL 6 & 7/S0.1

8. FOR ATTACHMENT OF EXTERIOR WALLS THAT TERMINATE BETWEEN TRUSSES, SEE 6A/S0.1

9. AT PORCHES, SEE DETAIL 2/SO.1 FOR FRAMING AND HOLD DOWNS

FIELD ALTERATION CONTRACTOR SHALL CONTACT LOU PONTIGO & ASSOCIATES PRIOR TO MAKING ANY STRUCTURAL FIELD MODIFICATIONS WHICH MAY VARY FROM THE INTENT OF THE ORIGINAL CONSTRUCTION DOCUMENTS. ANY FIELD ALTERNATIONS MADE PRIOR TO BEING APPROVED BY LOU PONTIGO & ASSOCIATES MAY DESULT IN BEING APPROVED BY LOU PONTIGO & ASSOCIATES MAY DESULT IN BEING APPROVED BY LOU PONTIGO & ASSOCIATES MAY DESULT IN BEING APPROVED BY LOU PONTIGO & ASSOCIATES MAY DESULT IN BEING APPROVED BY LOU PONTIGO & ASSOCIATES MAY DESULT IN BEING APPROVED BY LOU PONTIGO & ASSOCIATES MAY DESULT IN BEING APPROVED BY LOU PONTIGO & ASSOCIATES MAY DESULT IN BEING APPROVED BY LOU PONTIGO & ASSOCIATES MAY DESULT IN BEING APPROVED BY LOU PONTIGO & ASSOCIATES MAY DESULT IN BEING APPROVED BY LOU PONTIGO & ASSOCIATES MAY DESULT IN BURNEY BY ASSOCIATES MAY DESULT BURNEY BY ASSOCIATES PRIOR TO BEING APPROVED BY LOU PONTIGO & ASSOCIATES PRIOR TO BEING APPROVED BY LOU PONTIGO & ASSOCIATES PRIOR TO BEING APPROVED BY LOU PONTIGO & ASSOCIATES PRIOR TO BEING APPROVED BY LOU PONTIGO & ASSOCIATES PRIOR TO BEING APPROVED BY LOU PONTIGO & ASSOCIATES PRIOR TO BEING APPROVED BY LOU PONTIGO & ASSOCIATES PRIOR TO BEING APPROVED BY LOU PONTIGO & ASSOCIATES PRIOR TO BEING TO BEING APPROVED BY LOU PONTIGO & ASSOCIATES PRIOR TO BEING TO BE

ASSOCIATES MAY RESULT IN ADDITIONAL ENGINEERING OR INSPECTION FEES.

Lou Pontigo and Associates, Inc.

420 Osceola Avenue Jax. Beach, Florida 32250

Ph. 242-0908 Fax. 241-9557

FL: CA # 8344 SC: CA# 3579

SIAKK CUSIOM HOME LOT 167 PABLO CREEK RESERV

IST FLOOR FRAMING PLAN

DO NOT SCALE DIMENSIONS FROM THESE DRAWINGS. IF A DIMENSION IS UNCLEAR REFER TO THE ARCHITECTURAL DRAWINGS OR CONTACT THE E.O.R.

PLAN NAME
SPEC HOME

DESIGN/DRAWN/CHECKED
CS / JB / LAP


O7.13.16

SCALE
AS NOTED

LPA No.

DRBD-16-00465
CONTROL No.
6269
SHEET

\$1.11 SHEET 6 OF 10

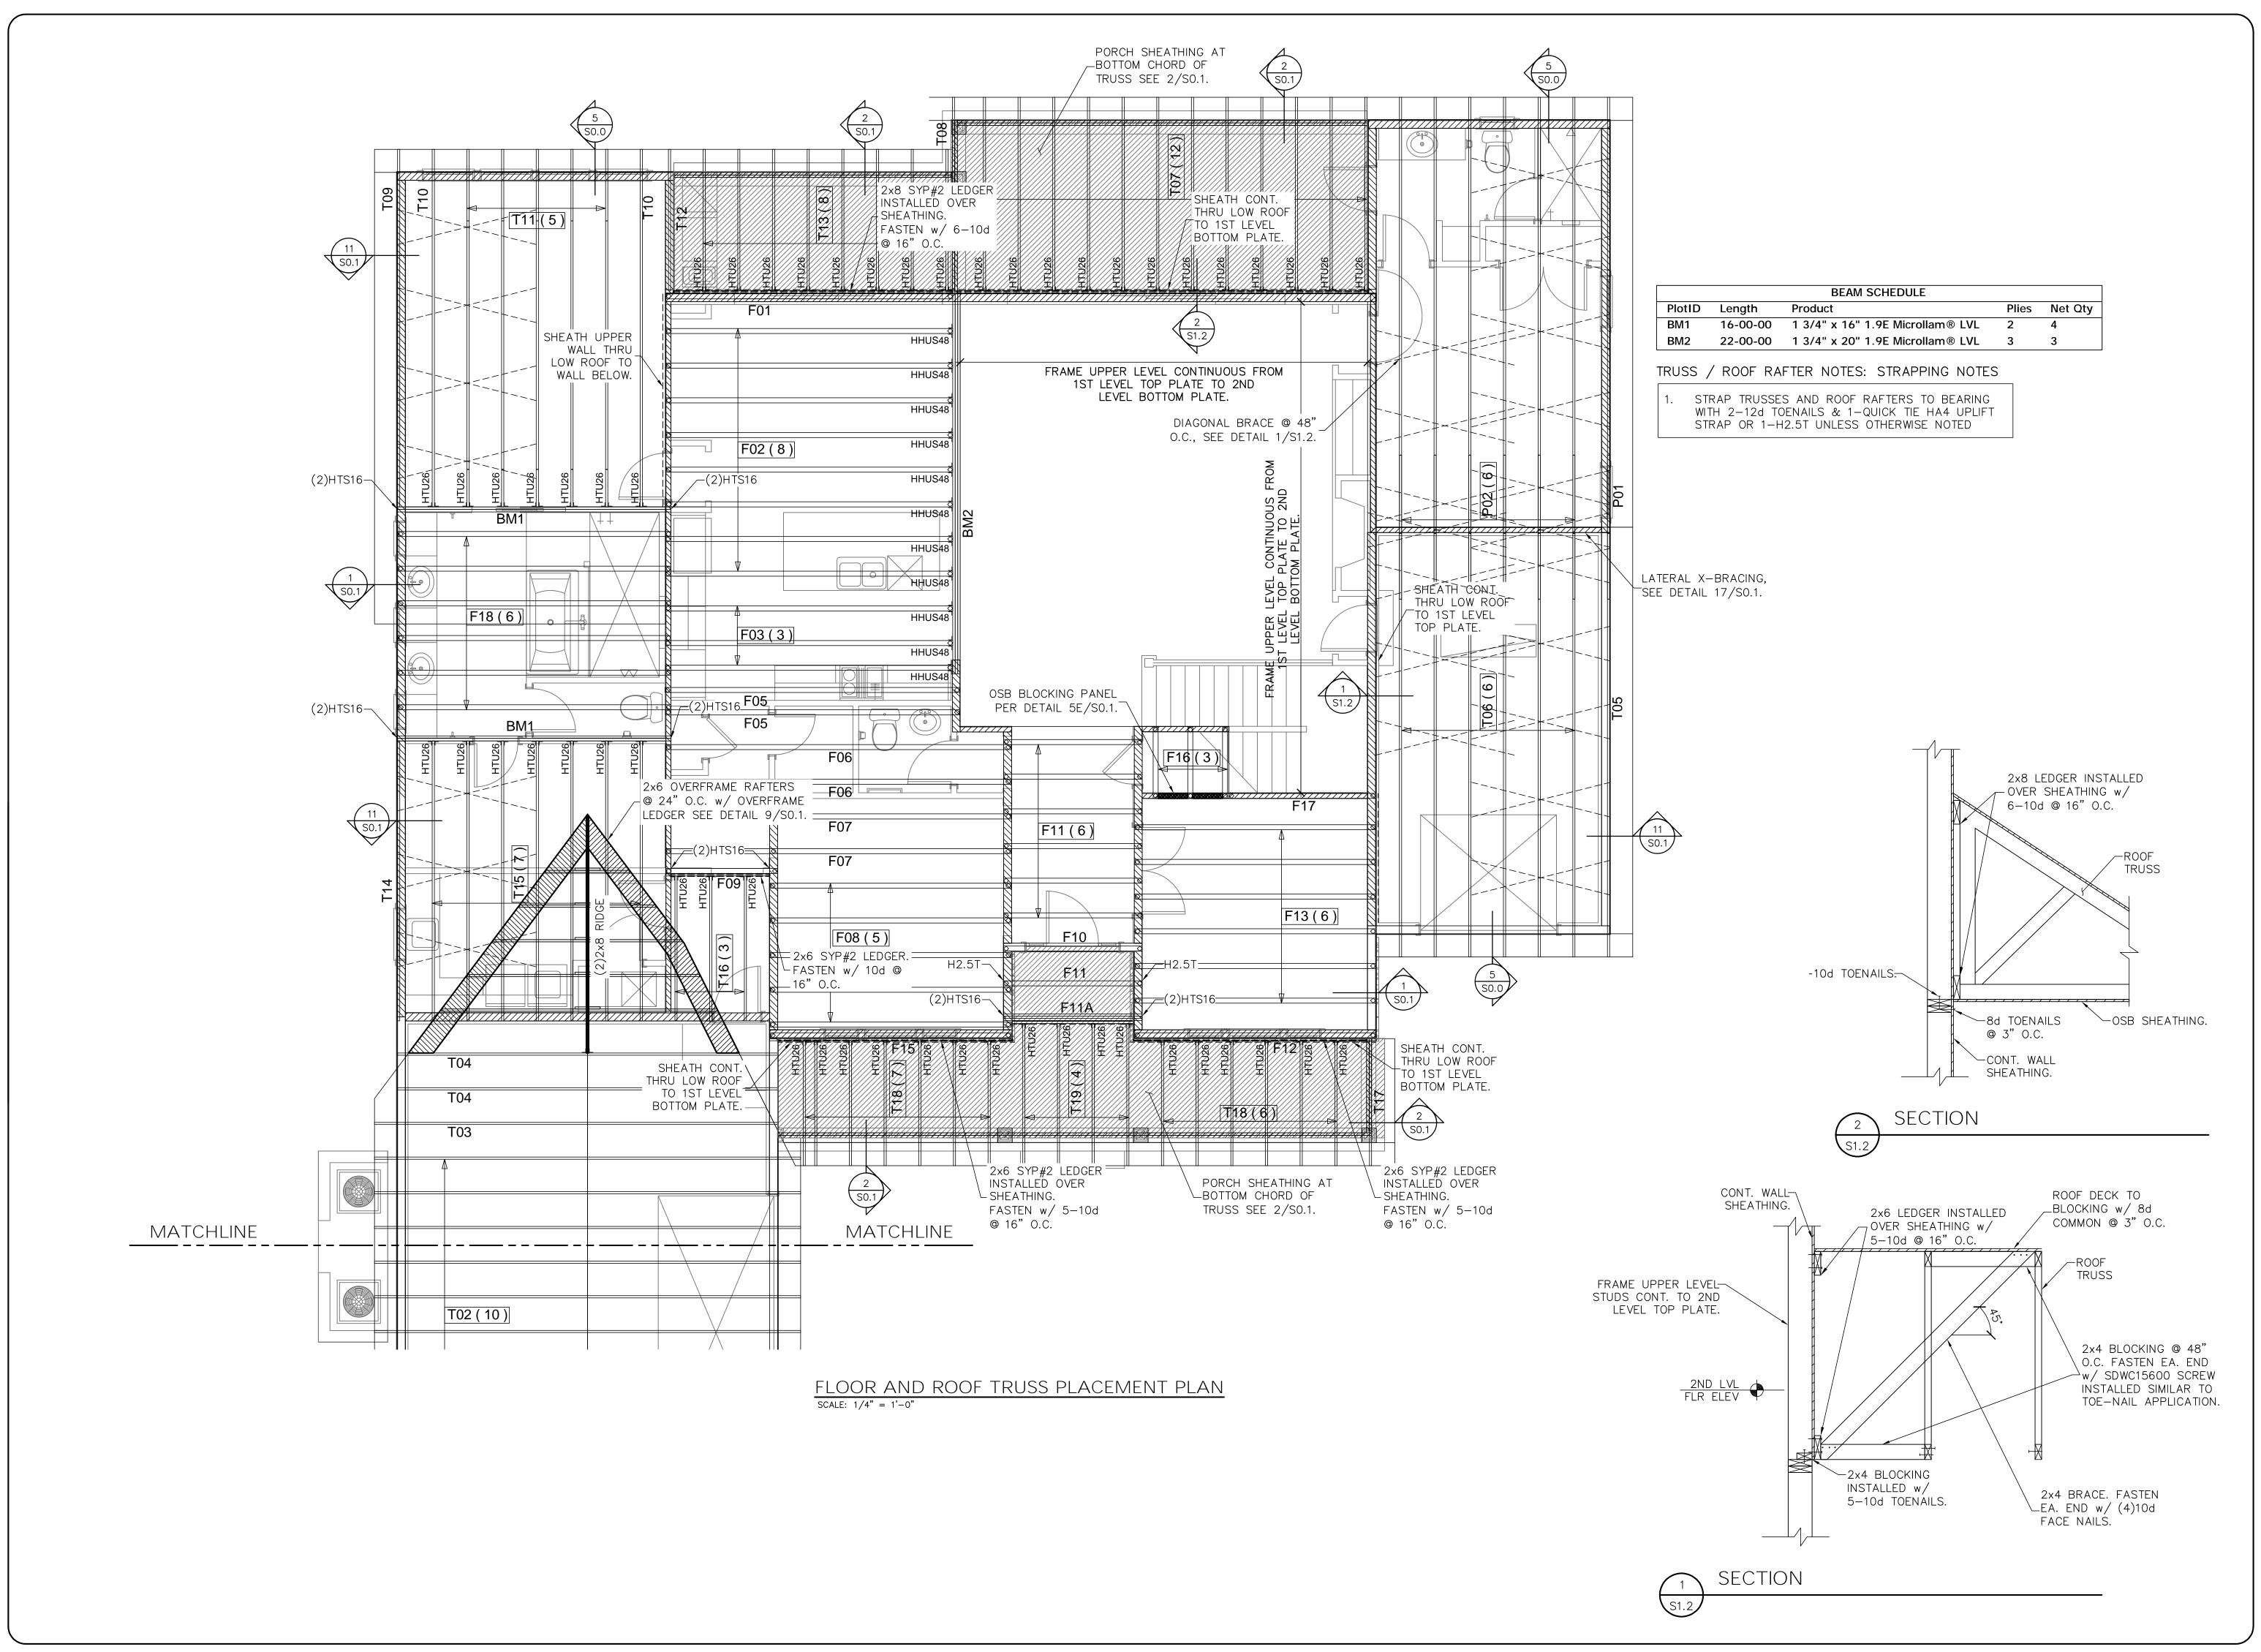



Lou Pontigo and Associates, Inc.

420 Osceola Avenue Jax. Beach, Florida 32250 Ph. 242-0908 Fax. 241-9557 FL: CA # 8344 SC: CA# 3579



Luis A. Pontigo, PE FL PE#53311

REVISIONS

FIFLD ALTERATION MODIFICATIONS WHICH MAY VAR


PONTIGO & ASSOCIATES PRIOR TO MAKING ANY STRUCTURAL FIELD FROM THE INTENT OF THE ORIGINA CONSTRUCTION DOCUMENTS. AN BEING APPROVED BY LOU PONTIGO ASSOCIATES MAY RESULT IN ADDITIONAL ENGINEERING OR INSPECTION FEES.


FLOOR AND **ROOF TRUSS PLACEMENT** PLAN

OO NOT SCALE DIMENSIONS FROM HESE DRAWINGS. IF A DIMENSION UNCLEAR REFER TO THE ARCHITECTURAL DRAWINGS OR CONTACT THE E.O.R.

PLAN NAME SPEC HOME DESIGN/DRAWN/CHECKED CS / JB / LAP 07.13.16 SCALE AS NOTED LPA No. DRBD-16-00465 CONTROL No. 6269 SHEET

SHEET 7 OF 10

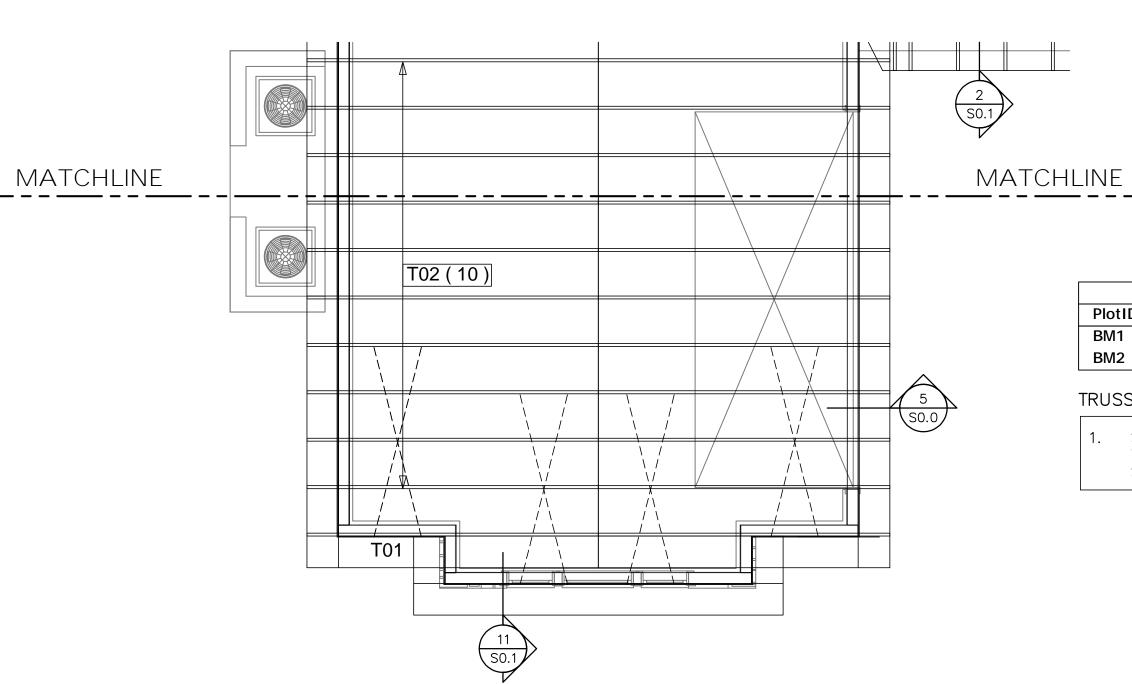

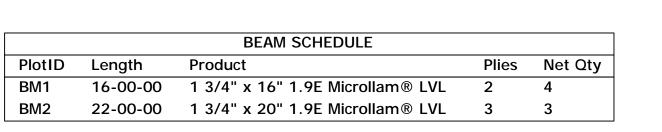

TRUSS / ROOF RAFTER NOTES: STRAPPING NOTES

1. STRAP TRUSSES AND ROOF RAFTERS TO BEARING WITH 2-12d TOENAILS & 1-QUICK TIE HA4 UPLIFT STRAP OR 1-H2.5T UNLESS OTHERWISE NOTED

Associates, Inc. 420 Osceola Avenue Jax. Beach, Florida 32250 Ph. 242-0908 Fax. 241-9557 FL: CA # 8344 SC: CA# 3579



Luis A. Pontigo, PE FL PE#53311

REVISIONS

FIELD ALTERATION

CONTRACTOR SHALL CONTACT LOU
PONTIGO & ASSOCIATES PRIOR TO
MAKING ANY STRUCTURAL FIELD
MODIFICATIONS WHICH MAY VARY
FROM THE INTENT OF THE ORIGINAL
CONSTRUCTION DOCUMENTS. ANY
FIELD ALTERNATIONS MADE PRIOR TO
BEING APPROVED BY LOU PONTIGO &
ASSOCIATES MAY RESULT IN
ADDITIONAL ENGINEERING OR
INSPECTION FEES.

GARAGE ROOF TRUSS PLACEMENT PLAN

DO NOT SCALE DIMENSIONS FROM THESE DRAWINGS. IF A DIMENSION IS UNCLEAR REFER TO THE ARCHITECTURAL DRAWINGS OR CONTACT THE E.O.R.

PLAN NAME SPEC HOME DESIGN/DRAWN/CHECKED

CS / JB /LAP 07.13.16 SCALE


AS NOTED DRBD-16-00465

CONTROL No. 6269 SHEET

SHEET 8 OF 10

GARAGE ROOF TRUSS PLACEMENT PLAN

SCALE: 1/4" = 1'-0"

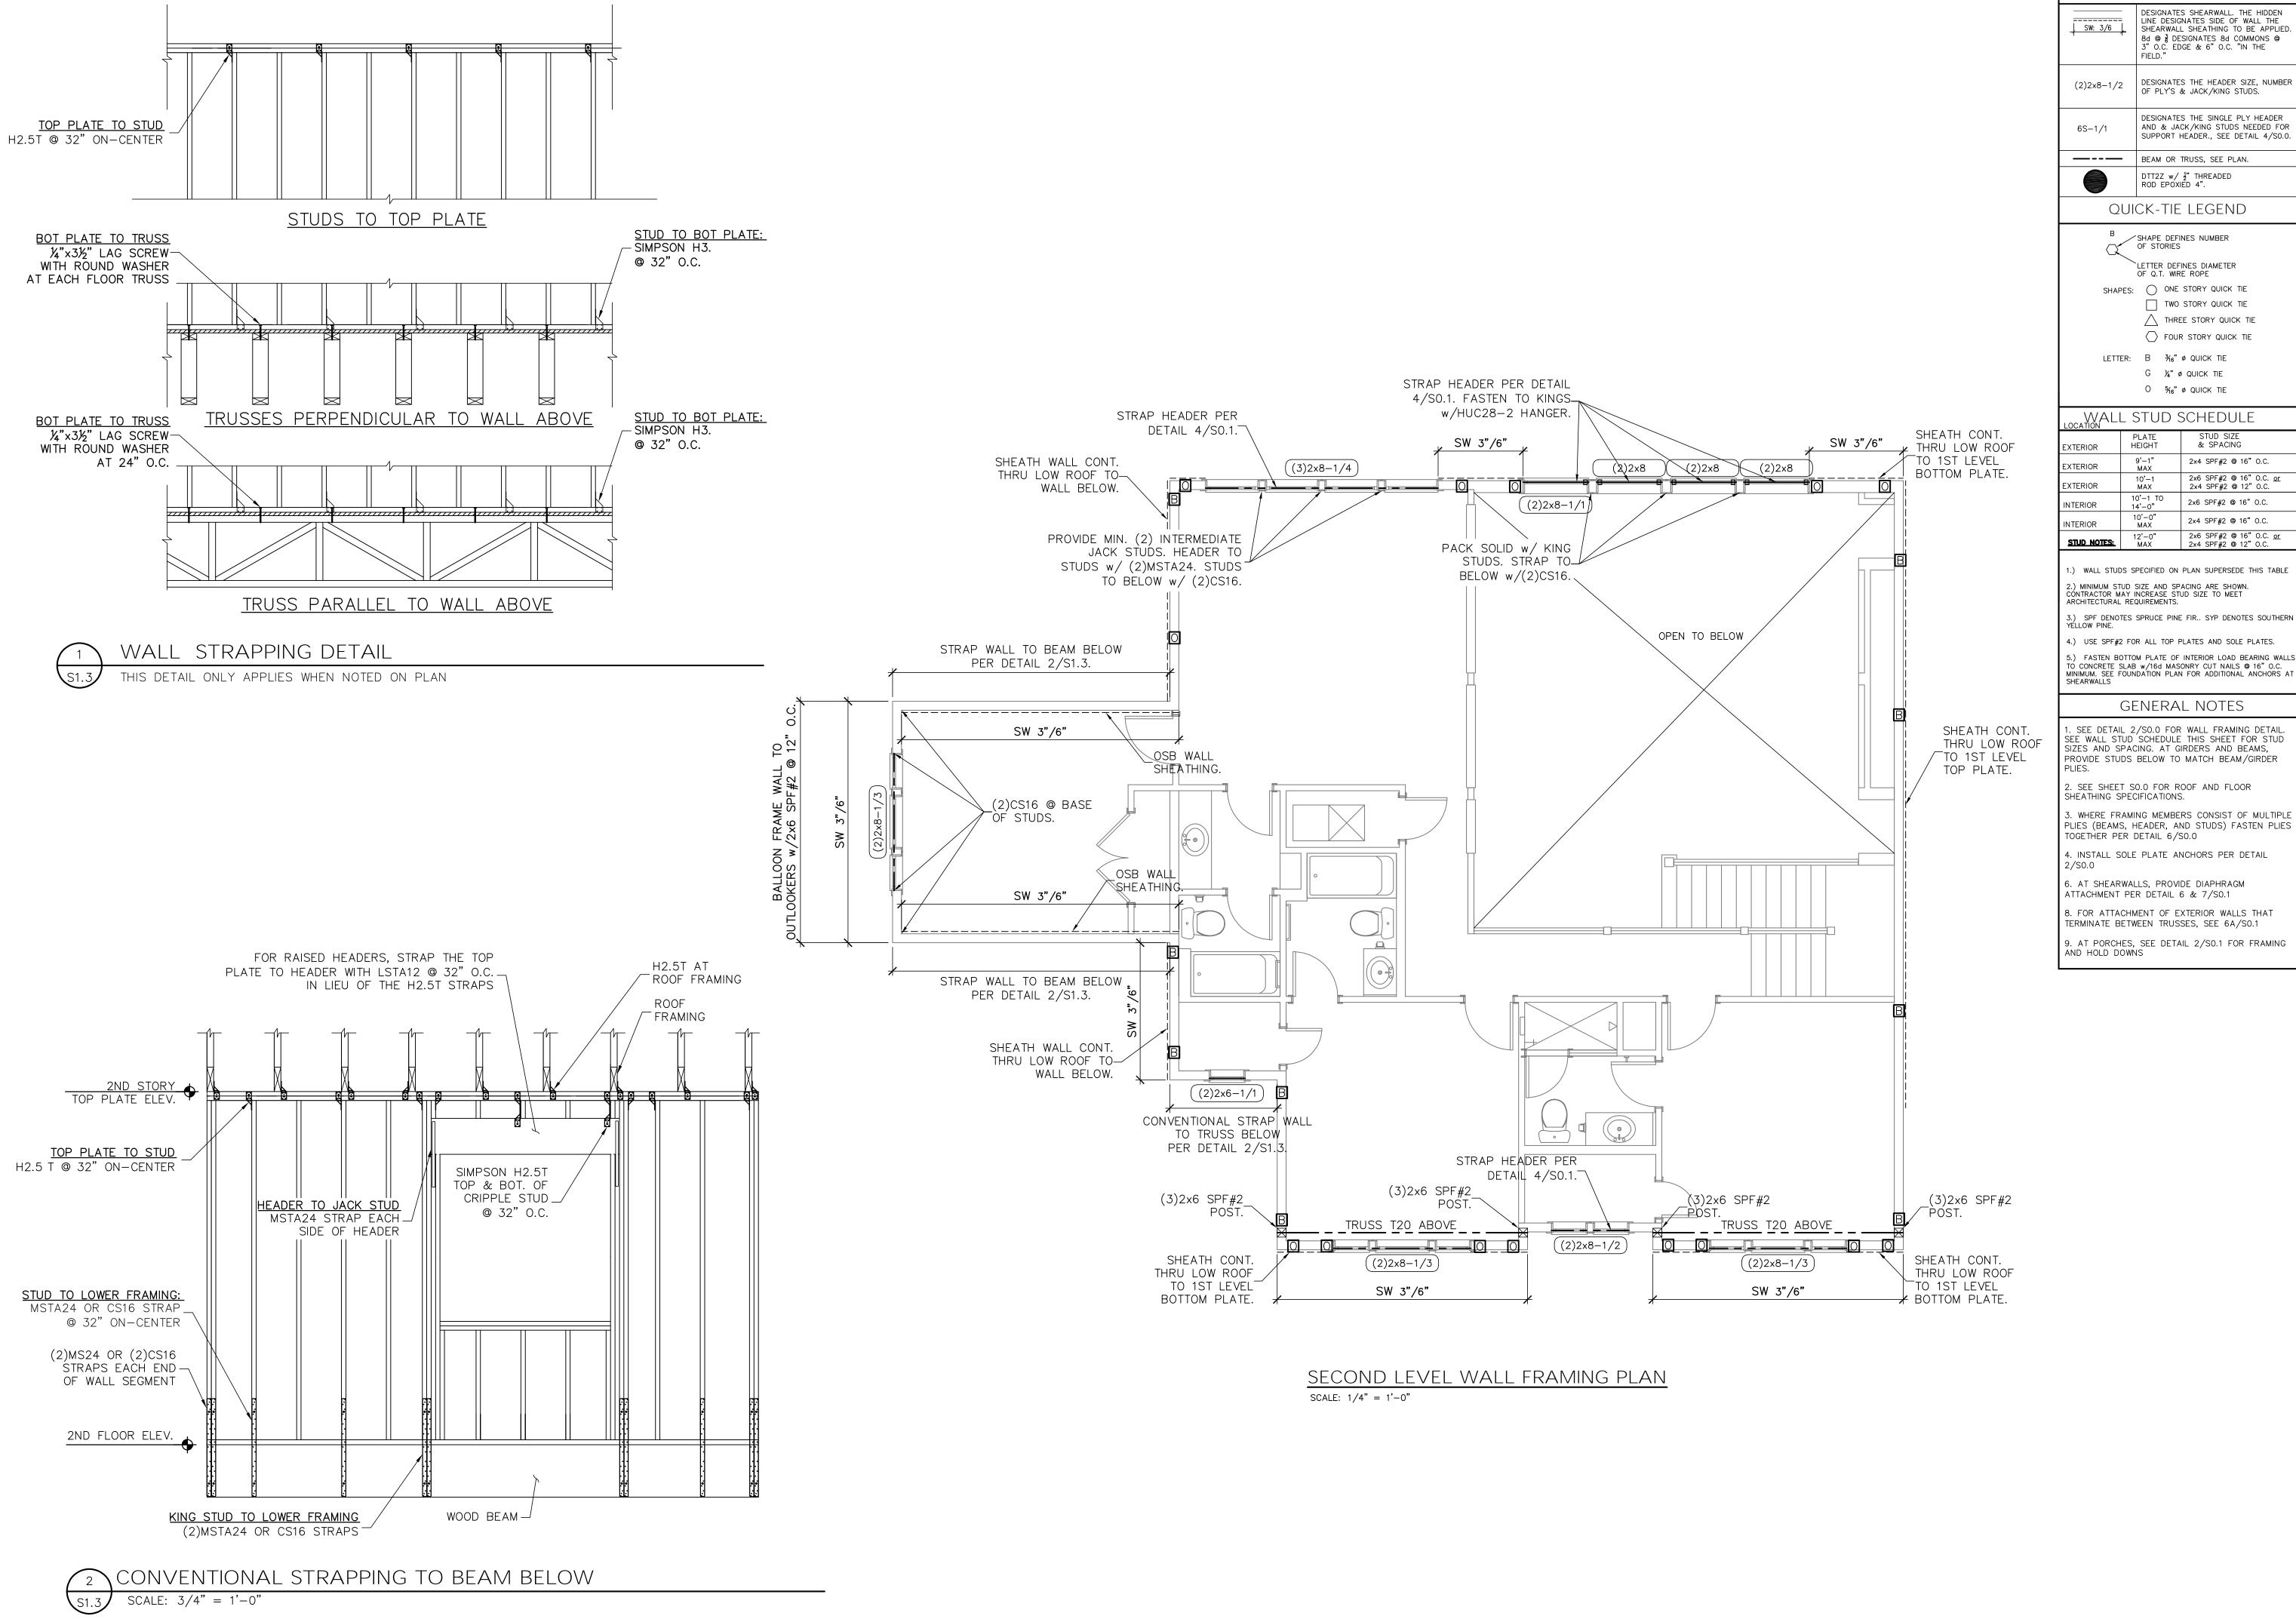


SYMBOLS LEGEND

DESIGNATES SHEARWALL. THE HIDDEN SW: 3/6 LINE DESIGNATES SIDE OF WALL THE SHEARWALL SHEATHING TO BE APPLIED 8d @ § DESIGNATES 8d COMMONS @ 3" O.C. EDGE & 6" O.C. "IN THE FIELD."

OF PLY'S & JACK/KING STUDS.

DESIGNATES THE SINGLE PLY HEADER AND & JACK/KING STUDS NEEDED FOR SUPPORT HEADER., SEE DETAIL 4/SO.0 BEAM OR TRUSS, SEE PLAN.

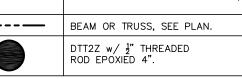

FOUR STORY QUICK TIE

WALL STUD SCHEDULE					
EXTERIOR	PLATE HEIGHT	STUD SIZE & SPACING			
EXTERIOR	9'-1" MAX	2×4 SPF#2 @ 16" O.C.			
EXTERIOR	10'-1 MAX	2x6 SPF#2 @ 16" O.C. <u>or</u> 2x4 SPF#2 @ 12" O.C.			
INTERIOR	10'-1 TO 14'-0"	2x6 SPF#2 @ 16" O.C.			
INTERIOR	10'-0" MAX	2x4 SPF#2 @ 16" O.C.			
	12'-0"	2x6 SPF#2 @ 16" O.C. <u>or</u>			

) WALL STUDS SPECIFIED ON PLAN SUPERSEDE THIS TABLE

4.) USE SPF#2 FOR ALL TOP PLATES AND SOLE PLATES.

TO CONCRETE SLAB w/16d MASONRY CUT NAILS @ 16" O.C. MINIMUM. SEE FOUNDATION PLAN FOR ADDITIONAL ANCHORS /

SEE WALL STUD SCHEDULE THIS SHEET FOR STUD SIZES AND SPACING. AT GIRDERS AND BEAMS, PROVIDE STUDS BELOW TO MATCH BEAM/GIRDER

. WHERE FRAMING MEMBERS CONSIST OF MULTIPLE PLIES (BEAMS, HEADER, AND STUDS) FASTEN PLIES

4. INSTALL SOLE PLATE ANCHORS PER DETAIL

Lou Pontigo and Associates, Inc.

420 Osceola Avenue Jax. Beach, Florida 32250

Ph. 242-0908 Fax. 241-9557 FL: CA # 8344 SC: CA# 3579



Luis A. Pontigo, PE FL PE#53311

_		
	REVISIONS	DATE
		\top

FIFLD ALTERATION

PONTIGO & ASSOCIATES PRIOR TO MAKING ANY STRUCTURAL FIELD MODIFICATIONS WHICH MAY VAR' FROM THE INTENT OF THE ORIGINA CONSTRUCTION DOCUMENTS. AN' ELD ALTERNATIONS MADE PRIOR T BEING APPROVED BY LOU PONTIGO ASSOCIATES MAY RESULT IN ADDITIONAL ENGINEERING OR INSPECTION FEES.

> \triangle \Box

2nd FLOOR **FRAMING PLAN**

DO NOT SCALE DIMENSIONS FROM HESE DRAWINGS. IF A DIMENSION UNCLEAR REFER TO THE ARCHITECTURAL DRAWINGS O CONTACT THE E.O.R.


PLAN NAME SPEC HOME DESIGN/DRAWN/CHECKED CS / JB / LAP


07.13.16 SCALE AS NOTED

LPA No. DRBD-16-00465 CONTROL No.

> 6269 SHEET

SHEET 9 OF 10

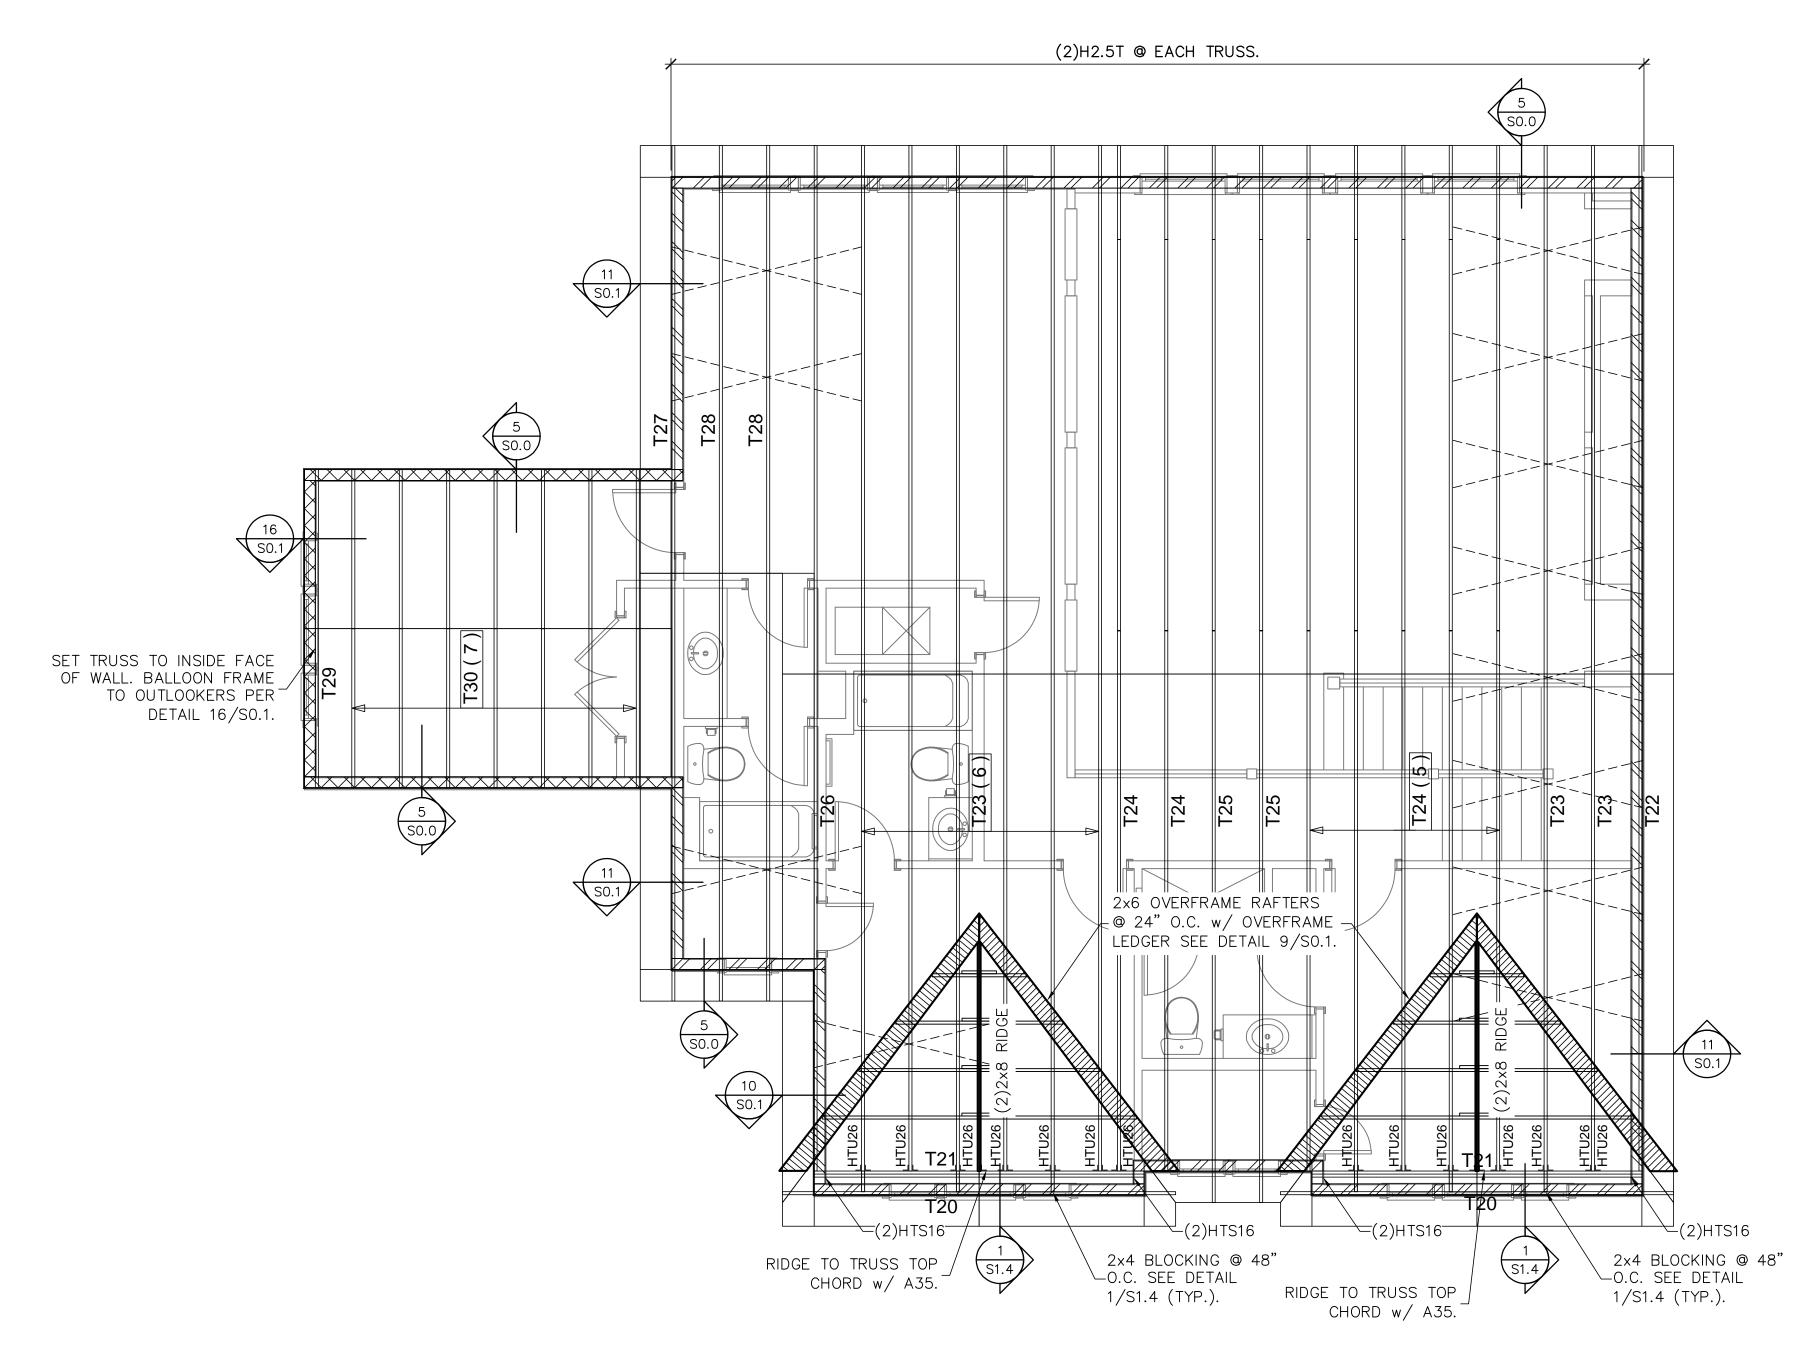

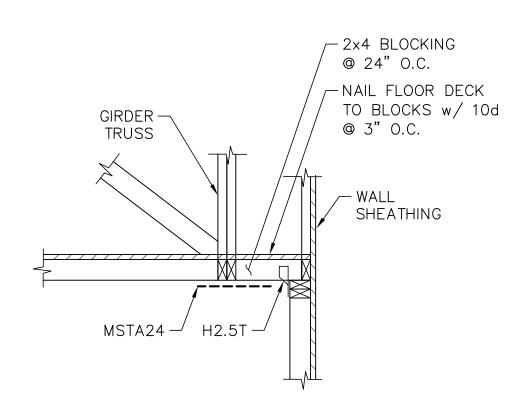

GABLE BLOCKING DETAIL

ROOF TRUSS PLACEMENT PLAN


SCALE: 1/4" = 1'-0"

TRUSS / ROOF RAFTER NOTES: STRAPPING NOTES


STRAP TRUSSES AND ROOF RAFTERS TO BEARING WITH 2-12d TOENAILS & 1-QUICK TIE HA4 UPLIFT STRAP OR 1-H2.5T UNLESS OTHERWISE NOTED

Lou Pontigo and Associates, Inc.

420 Osceola Avenue Jax. Beach, Florida 32250 Ph. 242-0908 Fax. 241-9557 FL: CA # 8344 SC: CA# 3579

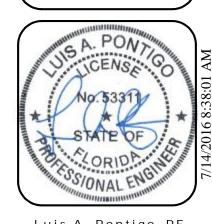

Luis A. Pontigo, PE FL PE#53311

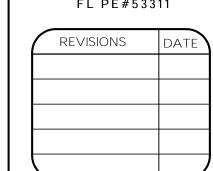

FIELD ALTERATION

PONTIGO & ASSOCIATES PRIOR TO
MAKING ANY STRUCTURAL FIELD
MODIFICATIONS WHICH MAY VARY
FROM THE INTENT OF THE ORIGINAL
CONSTRUCTION DOCUMENTS. ANY
FIELD ALTERNATIONS MADE PRIOR TO
BEING APPROVED BY LOU PONTIGO & ASSOCIATES MAY RESULT IN ADDITIONAL ENGINEERING OR INSPECTION FEES.

TRUSS PLACEMENT PLAN

DO NOT SCALE DIMENSIONS FROM THESE DRAWINGS. IF A DIMENSION IS UNCLEAR REFER TO THE ARCHITECTURAL DRAWINGS OR CONTACT THE E.O.R.

PLAN NAME SPEC HOME

DESIGN/DRAWN/CHECKED CS / JB /LAP

07.13.16

SCALE AS NOTED LPA No. DRBD-16-00465

CONTROL No. 6269 SHEET

SHEET10 OF 10