

FOOTING AND FOUNDATIONS:

FOOTINGS AND FOUNDATIONS SHALL BE IN ACCORDANCE WITH LOCAL BUILDING CODES. FOOTING HAVE BEEN DESIGNED WITH A SOIL BEARING (DESIGN MAXIMUM) OF 2000 PSF. A SOILS INVESTIGATION REPORT IS RECOMMENDED TO VERIFY SUITABLE SUBSURFACE CONDITIONS. IF THE FOOTING ELEVATIONS SHOWN OCCUR IN A DISTURBED OR UNSTABLE SOIL, THE ENGINEER SHALL BE NOTIFIED. SOIL SHALL BE FREE OF ORGANIC MATERIAL AND COHESIVE (CLAY) SOILS. SOIL COMPACTION AND FILI SHALL BE COMPACTED TO A MIN. OF 95% MODIFIED PROCTOR IN ACCORDANCE WITH ASTM D 1557.

FOUNDATION PLAN ONLY CONVEYS STRUCTURAL INFORMATION. FOR GENERAL FEATURES, CONDUITS, ELECTRICAL EMBEDS, STEP HEIGHTS, ETC., SEE ARCHITECTURAL PLANS. DO NOT SCALE FOOTING DIMENSIONS AND LOCATION FROM THE FOUNDATION PLAN SHOWN ON \$1.0. DO NOT DETERMINE FOOTING LOCATION BASED ON EITHER THE ARCHITECTURAL PLAN OR FRAMING PLAN, BUT BY DIMENSIONS PROVIDED ON FOUNDATION PLAN. IF FOOTING SIZE OR LOCATION IS NOT DETERMINED ON PLAN THEN CONTACT ENGINEER OF RECORD (EOR)

UNLESS OTHERWISE NOTED ON DRAWINGS, MINIMUM CONCRETE COVER FOR REINFORCING SHALL BE 3" IN FOOTINGS AND MESH SHALL BE CENTERED IN SLAB ON GRADE. IN ALL CONTINUOUS FOOTINGS PROVIDE #3 @ 48" O.C. OR ROD CHAIRS. PROVIDE CONTINUITY OF REINFORCING AT INTERSECTIONS OF PERPENDICULAR CONCRETE ELEMENTS BY INSTALLING CORNER BARS, MINIMUM OF 40 BAR DIAMETERS INTO EACH ELEMENT, SPLICES IN REINFORCING, WHERE PERMITTED, SHALL BE 48 BAR DIAMETERS

SHALL BE INSTALLED OVER MINIMUM 6 MIL POLYETHYLENE VAPOR RETARDER WITH JOINTS LAPPED 6" AND SEALED OVER CLEAN, COMPACTED EARTH OR FILL WITH APPROVED CHEMICAL SOIL TREATMENT FOR PREVENTION OF SUBTERRANEAN TERMITES. SAWCUTS: FOR CONTROLLED CRACKING CUT A 1" SAWCUT INTO SLAB IN A 12'x12' GRID WITHIN 12 HOURS OF CONCRETE PLACEMENT, PROVIDE SAWCUTS THROUGH OUT SLAB CALL EOR FOR ALTERNATIVE METHODS. WOOD FRAMING SPECIFICATIONS:

ALL WOOD FRAMING HAS BEEN DESIGNED IN ACCORDANCE WITH NATIONAL DESIGN SPECIFICATIONS (NDS) FOR WOOD CONSTRUCTION, LATEST EDITION. ALL WOOD MEMBERS EXPOSED TO WEATHER OR IN CONTACT WITH MASONRY, CONCRETE OR SOIL SHALL BE PRESSURE—TREATED. IF, ACQ OR NON—DOT BORATE PRESERVATIVE TREATMENT IS USED, ALL ATTACHED FASTENERS SHALL BE HOT DIPPED GALVANIZED. IF ACZA PRESERVATIVE IS USED, ALL ATTACHED FASTENERS SHALL BE STAINLESS STEEL. PRE-ENGINEERED WOOD TRUSSES:


SHALL BEAR THE SEAL OF AN ENGINEER IN THE STATE WHERE PROJECT IS BEING BUILT AND SHALL COMPLY WITH NFPA, TPI, AND AITC 100. CONTRACTOR SHALL VERIFY THAT ADEQUATE TRUSS BEARING IS INSTALLED AT ALL TRUSSES AS INDICATED IN THE TRUSS SHOP DRAWINGS. ALL TRUSS-TO-TRUSS CONNECTIONS AND TRUSS PROFILES ARE THE RESPONSIBILITY OF THE DELEGATED TRUSS ENGINEER. ALL TRUSSES SHALL HAVE TEMPORARY BRACING PER 'COMMENTARY' AND RECOMMENDATION FOR HANDLING, INSTALLING & BRACING METAL PLATE CONNECTED WOOD TRUSSES, HIB-91." AT MULTIPLE STRAP CONNECTIONS, SPREAD STRAPS TO AVOID NAILING CONFLICTS THROUGH TRUSS. WHEN USING (2) STRAPS ON

SINGLE PLY TRUSSES, PLACE STRAPS DIAGONALLY ACROSS DBL. TOP PLATE FROM EA. OTHER. THE CONTRACTOR SHALL BE RESPONSIBLE FOR THE DESIGN AND INSTALLATION OF THE ROOF COVERING SYSTEM. ASPHALT SHINGS SHALL COMPLY WITH ASTM D3161 AND BE INSTALLED ACCORDING TO THE MANUFACTURER'S REQUIREMENTS. CLAY

AND TILE ROOFS SHALL BE INSTALLED PER THE "CONCRETE AND CLAY ROOF TILE INSTALLATION MANUAL." AND THE MANUFACTURER'S REQUIREMENTS. STANDING SEAM METAL ROOFS SHALL COMPLY WITH ASTM E1514 AND BE INSTALLED ACCORDING TO THE MANUFACTURER'S REQUIREMENTS. THE CONTRACTOR SHALL BE RESPONSIBLE FOR THE DESIGN AND INSTALLATION OF ALL METAL FLASHING AND VALLEY MATERIALS.


IHE CONTRACTOR SHALL BE RESPONSIBLE FOR THE DESIGN/INSTALLATION OF ALL WATER PROOFING.

WOOD FASTENING SCHEDULE		BRICK NOTES / LINTEL SCHD			PLAN LEGEND AND ABBREVIATIONS	
MEMBERS	CONNECTION FASTENER	LINTEL DIMENSION	MIN. BRG.	MAX. SPAN	INTERIOR LOAD BEARING WALL	BUILT-UP POST IN THE WALL
TOP PLATE TO TOP PLATE	FACE NAIL 2-GUN NAILS @ 12" STAG.	L3 ¹ / ₂ ×3 ¹ / ₂ × ¹ / ₄	4"	6'-0"	GABLE X-BRACE, SEE DETAIL 11/S2.	
TOP PLATE, LAPS/INTERSECTION	FACE NAIL (2-16d) 3-GUN NAILS	L4x3 ¹ / ₂ "x ¹ / ₄	 6"	8'-0"		H6-1/2 HEADER SIZE, JACK AND KING STUD
DBL. TOP PLATE TO STUD	FACE NAIL (2-16d) 3-GUN NAILS	L5x3 ¹ / ₂ "x ¹ / ₄	6"	10'-0"	DESIGNATES SHEARWALL. THE HIDDEN LINE DESIGNATES SIDE OF	QUANTITY.
RIM JOIST TO TOP PLATE	TOE NAIL (8d @ 6") GUN NAIL @ 6"	L6x3 ¹ / ₂ "x ¹ / ₄	6"	12'-0"	SW WALL THE SHEARWALL SHEATHING TO BE APPLIED. 8d @ 3/6	
CEILING JOIST TO TOP PLATE	TOE NAIL (3-8d) 5-GUN NAILS	L7x3 ¹ / ₂ "x ¹ / ₄	6"	16'-0"	NAILING: DESIGNATES 8d COMMONS @ 3"	
CEILING JOIST, OVER PARTITIONS	FACE NAIL (3-16d) 4-GUN NAILS	1. STEEL LINTELS TO BE MINIMAL 36"		10 -0	O.C. EDGE & 6" O.C. "IN THE FIELD"	
CEILING JOIST TO ROOF RAFTER	FACE NAIL (6-16d) 8-GUN NAILS	LINTEL MUST HAVE CORROSION		BRICK	ADJ — ADJACENT	LG — Lona
JOIST/TRUSS TO PLATE	TOE NAIL (2-16d) 3-GUN NAILS	RESISTANT COATING OF EPOXY BASED PAINT.)	VENEER	BM — BEAM	MANUF — Manufacture
RAFTER TO PLATE	TOE NAIL (3-8d) 3-GUN NAILS			WEATHER BARRIER	BOT — BOTTOM BRG — BEARING	MONO — Monolithic OC — On Center
JACK RAFTER TO HIP	TOE NAIL (3-10d) 4-GUN NAILS	2. LINTEL MORE THAN 8'-0". SHOULD BE LATERALLY SUPPORTED NOT TO	' <u> </u>		CMU - CONCRETE MASONRY UNIT	OSB — Oriented Strand Board
ROOF RAFTER TO 2x_ RIDGE BM.	TOE NAIL (2-16d) 3-GUN NAILS	EXCEED 6 FT. O.C. $w/2-\frac{1}{4} \times 3$ WD.	\ <i>\</i>	M	DBL — DOUBLE DIA — DIAMETER	PERP — Perpendicular PRE ENG — Pre Engineered
CONT. HEADER, TWO PIECES	FACE NAIL 16d@ 16" O.C. @ EDGE	SCREWS INTO HEADER PROVIDE A $\frac{1}{2}$ VERTICAL SLOTTED HOLE FOR SCREW.	"	LINTEL ATTACHMENT	EA — EACH EE — EACH END	PSF — Pounds per Square Foot PSI — Pounds per Square Inch
CONT. HEADER TO STUD	TOE NAIL (3-16d) 4-GUN NAILS		\ \	SEE NOTE 2	EOR — ENGINEER OF RECORD	PT — PRESSURE TREATED
STUD TO SOLE PLATE	TOE NAIL (3-16d) 4-GUN NAILS	3. BRICK VENEER ATTACHMENT: HORIZONTAL TIES @ 24" O.C., VERT.	<u> </u>	<u>-₹₽0.</u> 	EQ — EQUAL EXT — EXTERIOR	QT — Quick Tie REINF — Reinforce
SOLE PLATE TO JOIST/BLOCKING	FACE NAIL (16d @ 16") GUN NAIL @ 8"	TIES @ 12" O.C (FOR 110mph	HEADER,_	FLASHING	FBC — FLORIDA BUILDING CODE	SF — Square Foot
·	ECIFICATIONS $2"x0.113"\phi = RINK SHANK$ $2^{1}/_{2}"x0.131"\phi = 8d$ $3^{1}/_{2}"x0.162"\phi = 16d$	WIND-ZONE VERT. TIES @ 16" O.C.). AT ALL OPENINGS SPACE TIES WITHIN 12" OF OPENINGS. PROVIDE 3/16" Ø WEE HOLES @ 33" O.C. IMMEDIATELY ABOV FLASHING.	SEE PLAN	BRICK LINTEL, SEE SCHEDULE ECTION VIEW BRICK LINTEL	FDN — FOUNDATION FT — FOOT FTG — FOOTING HDR — HEADER HORIZ — HORIZONTAL LBS — POUNDS	SPF —Spruce Pine Fur SYP — Southern Yellow Pine THRU — Through TYP — Typical UON — Unless Otherwise Noted VERT — Vertical WWF — Welded Wire Fabric

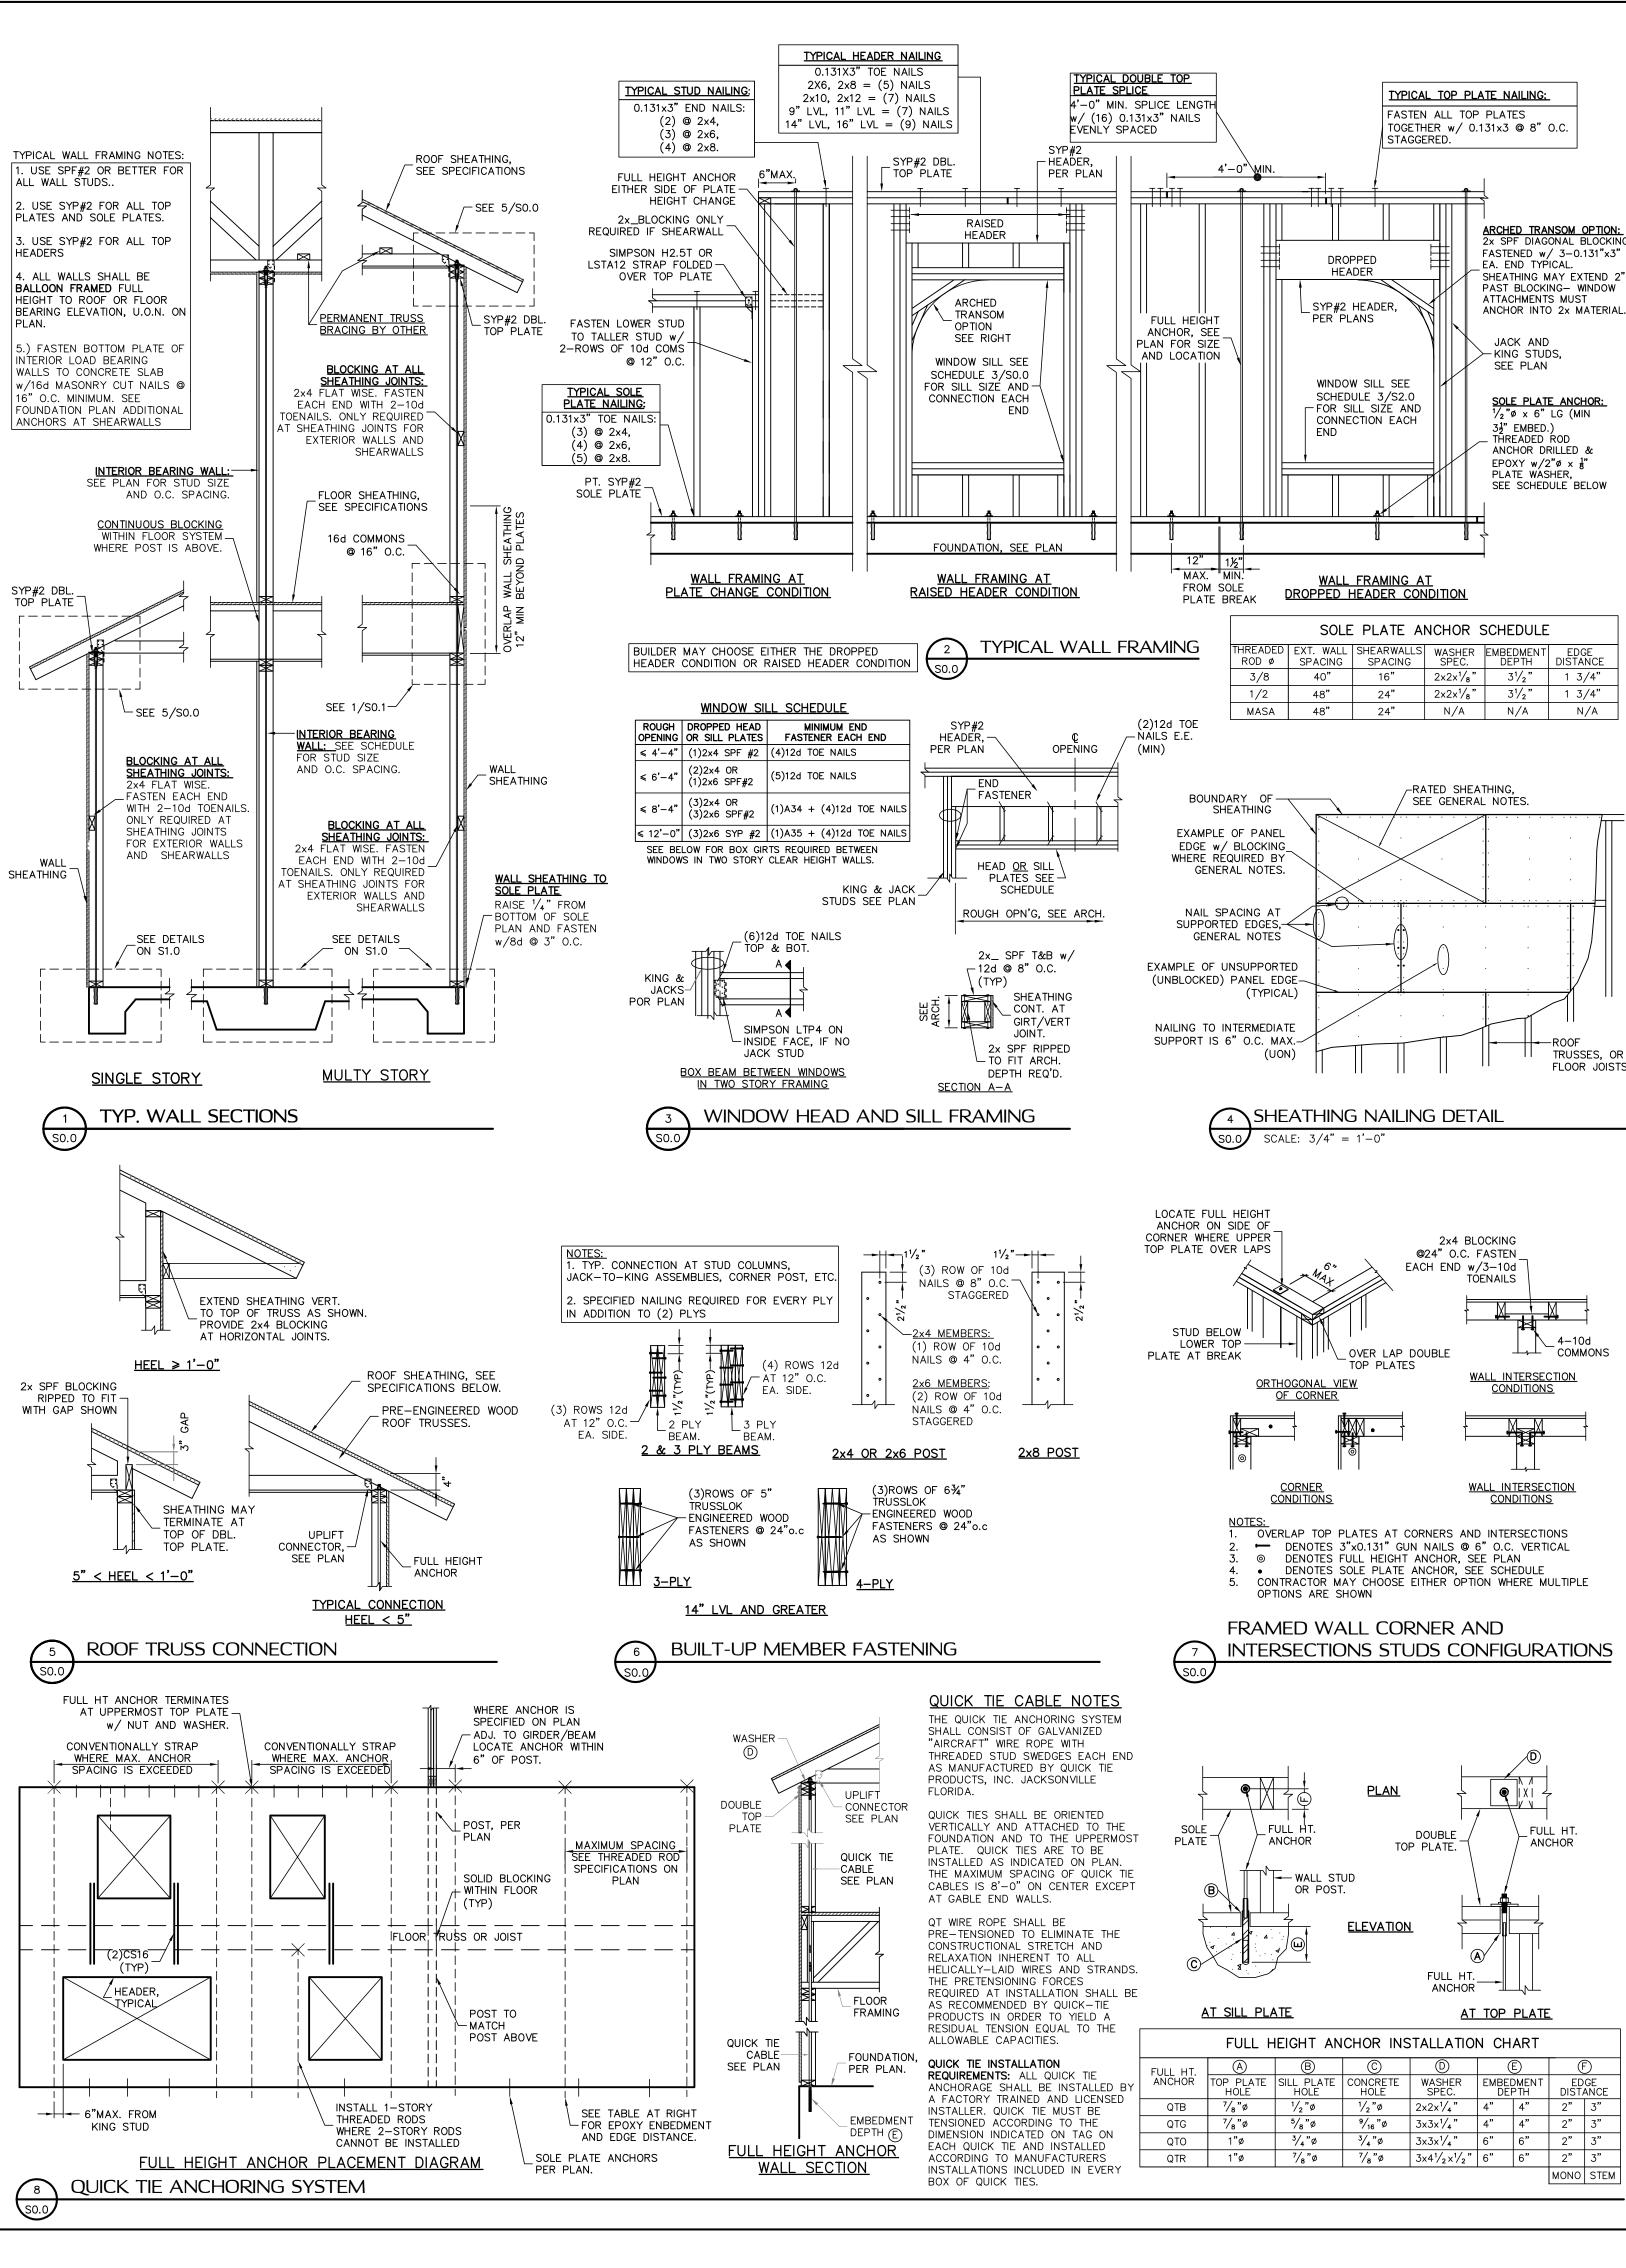




Iax. Beach. Florida 32250 Ph. 242-0908 Fax. 241-9557 FL: CA # 8344 SC: CA# 3579

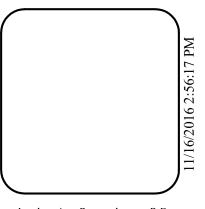

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FIELD ALTERATION CONTRACTOR SHALL CONTACT LOL PONTIGO & ASSOCIATES PRIOR TO MAKING ANY STRUCTURAL FIELD MODIFICATIONS WHICH MAY VARY FROM THE INTENT OF THE ORIGINAL CONSTRUCTION DOCUMENTS, ANY BEING APPROVED BY LOU PONTIGO 8 ASSOCIATES MAY RESULT IN

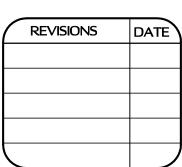ADDITIONAL ENGINEERING OR INSPECTION FEES.

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DESIGN AND **GENERAL**


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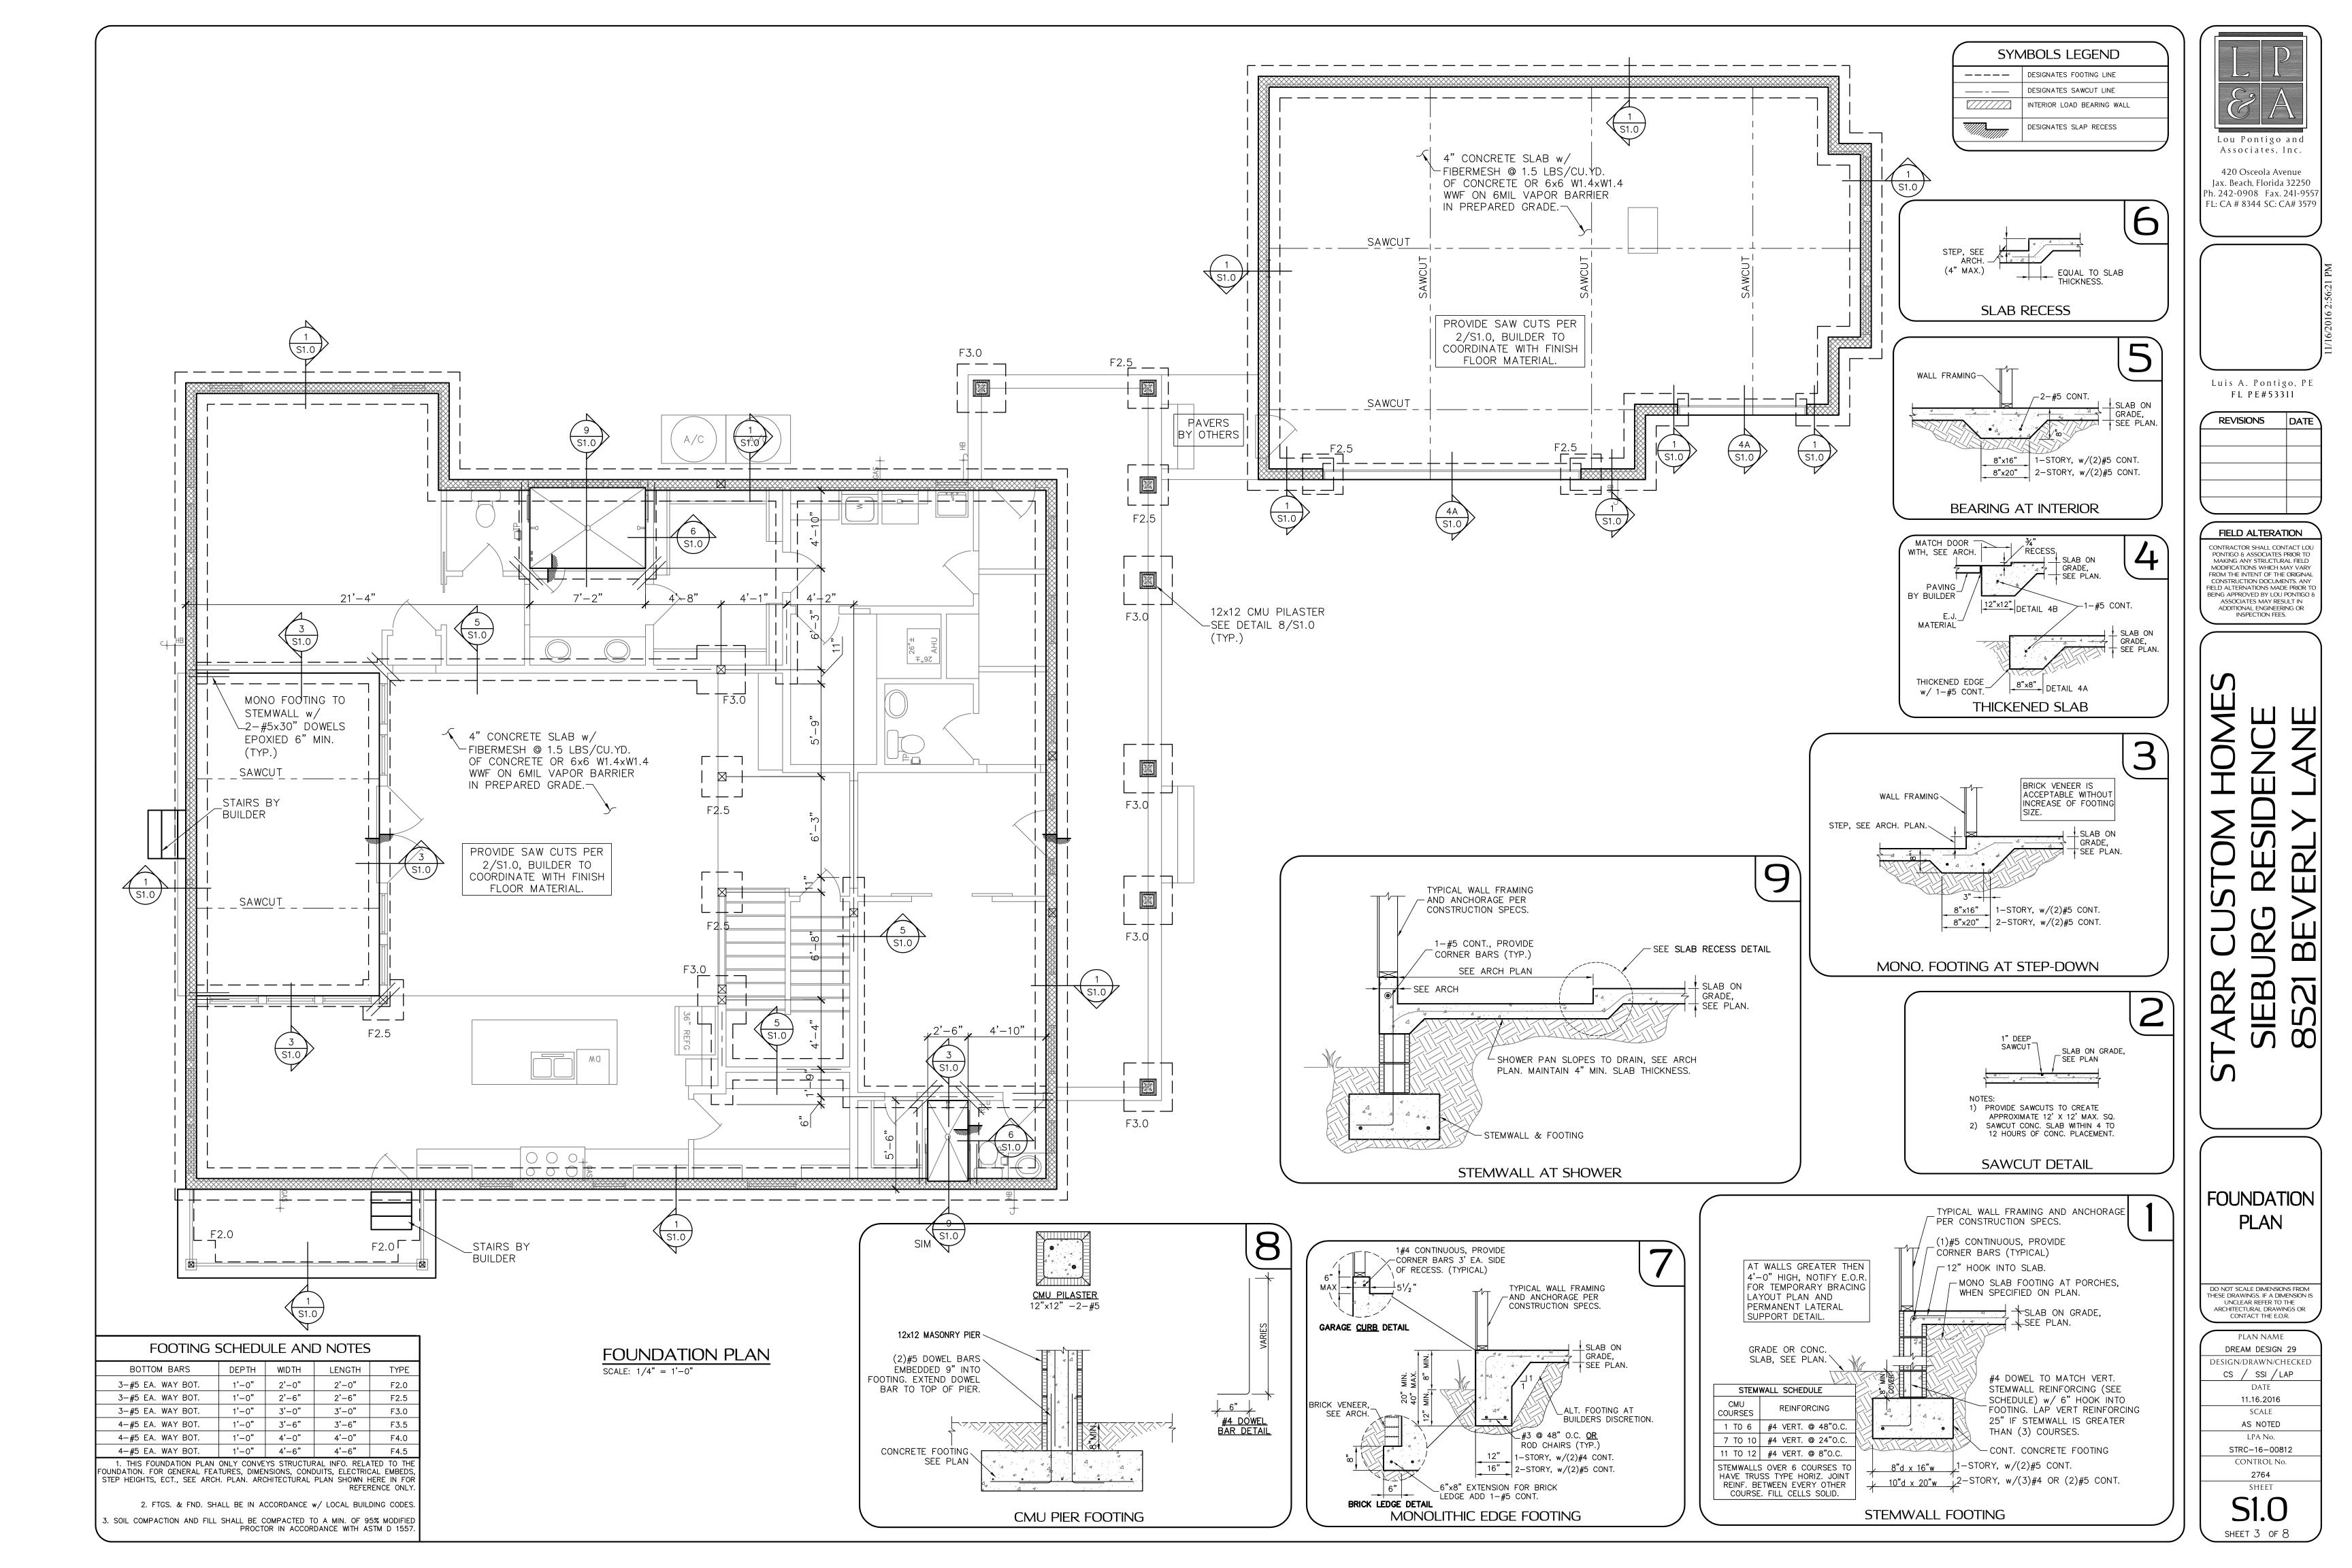
CONTACT THE E.O.R.


PLAN NAME DREAM DESIGN 29 DESIGN/DRAWN/CHECKED CS / SSI / LAP 11.16.2016 SCALE AS NOTED LPA No. STRC-16-00812 CONTROL No.

SHEET

2764



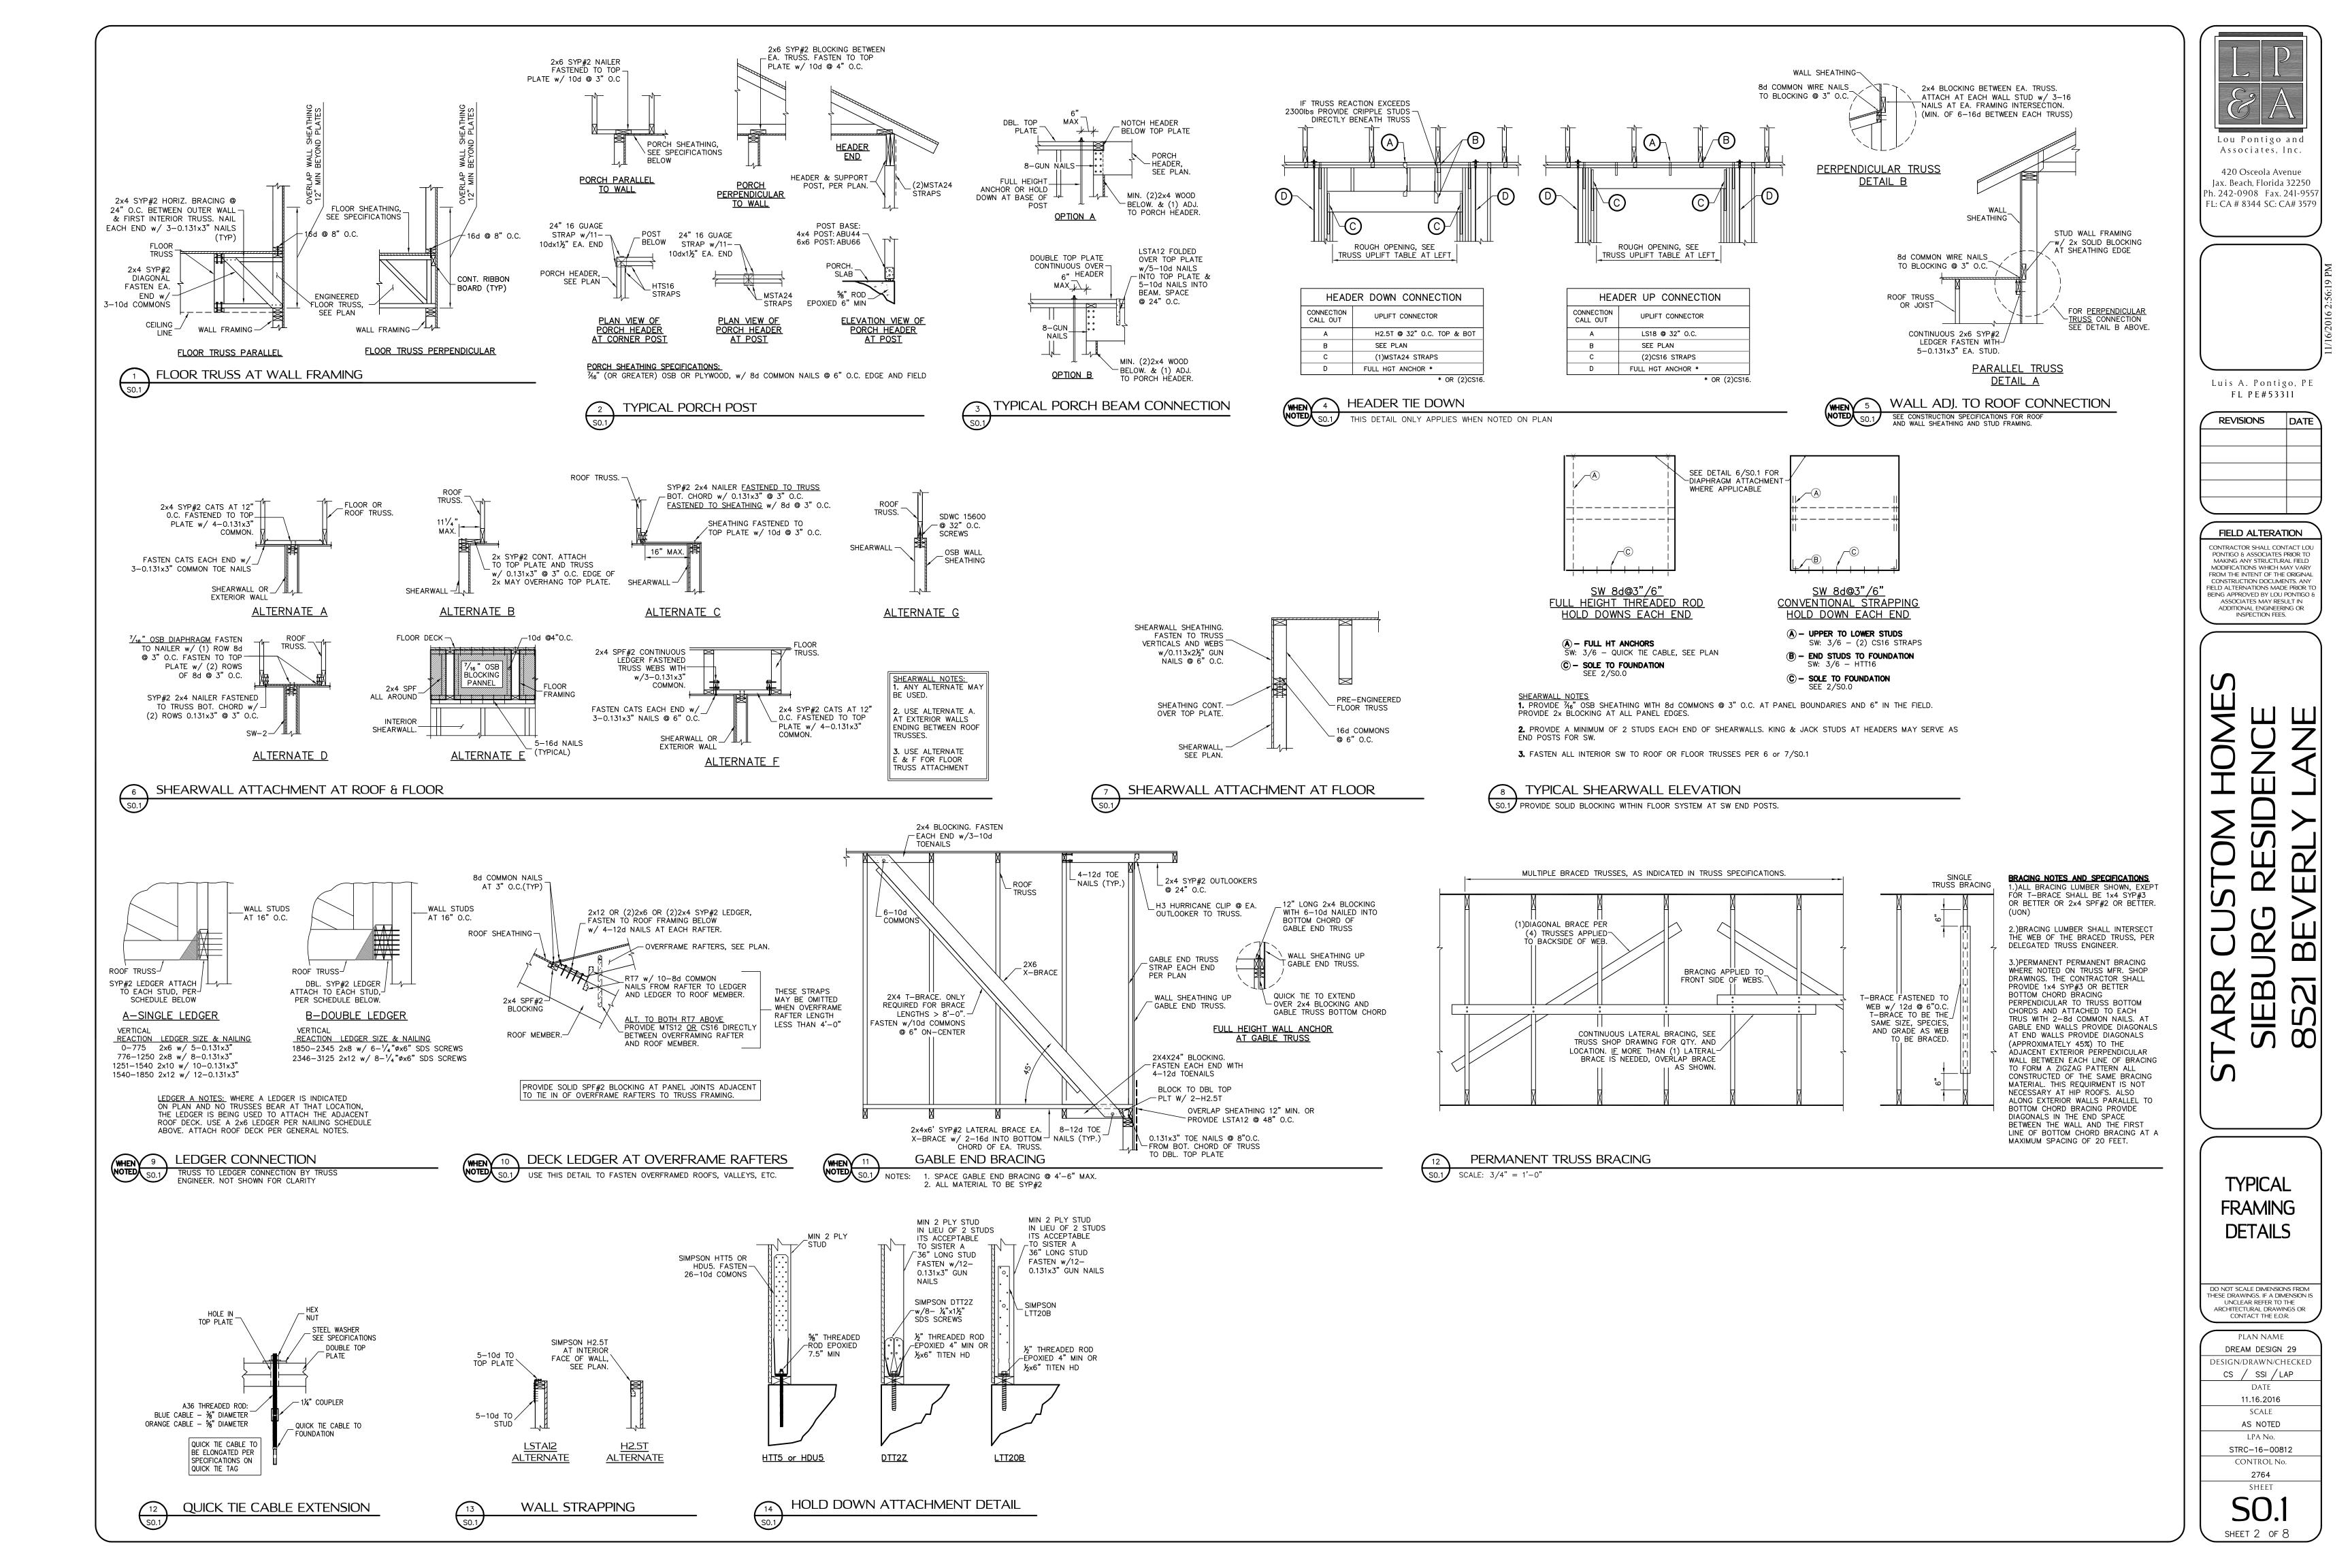

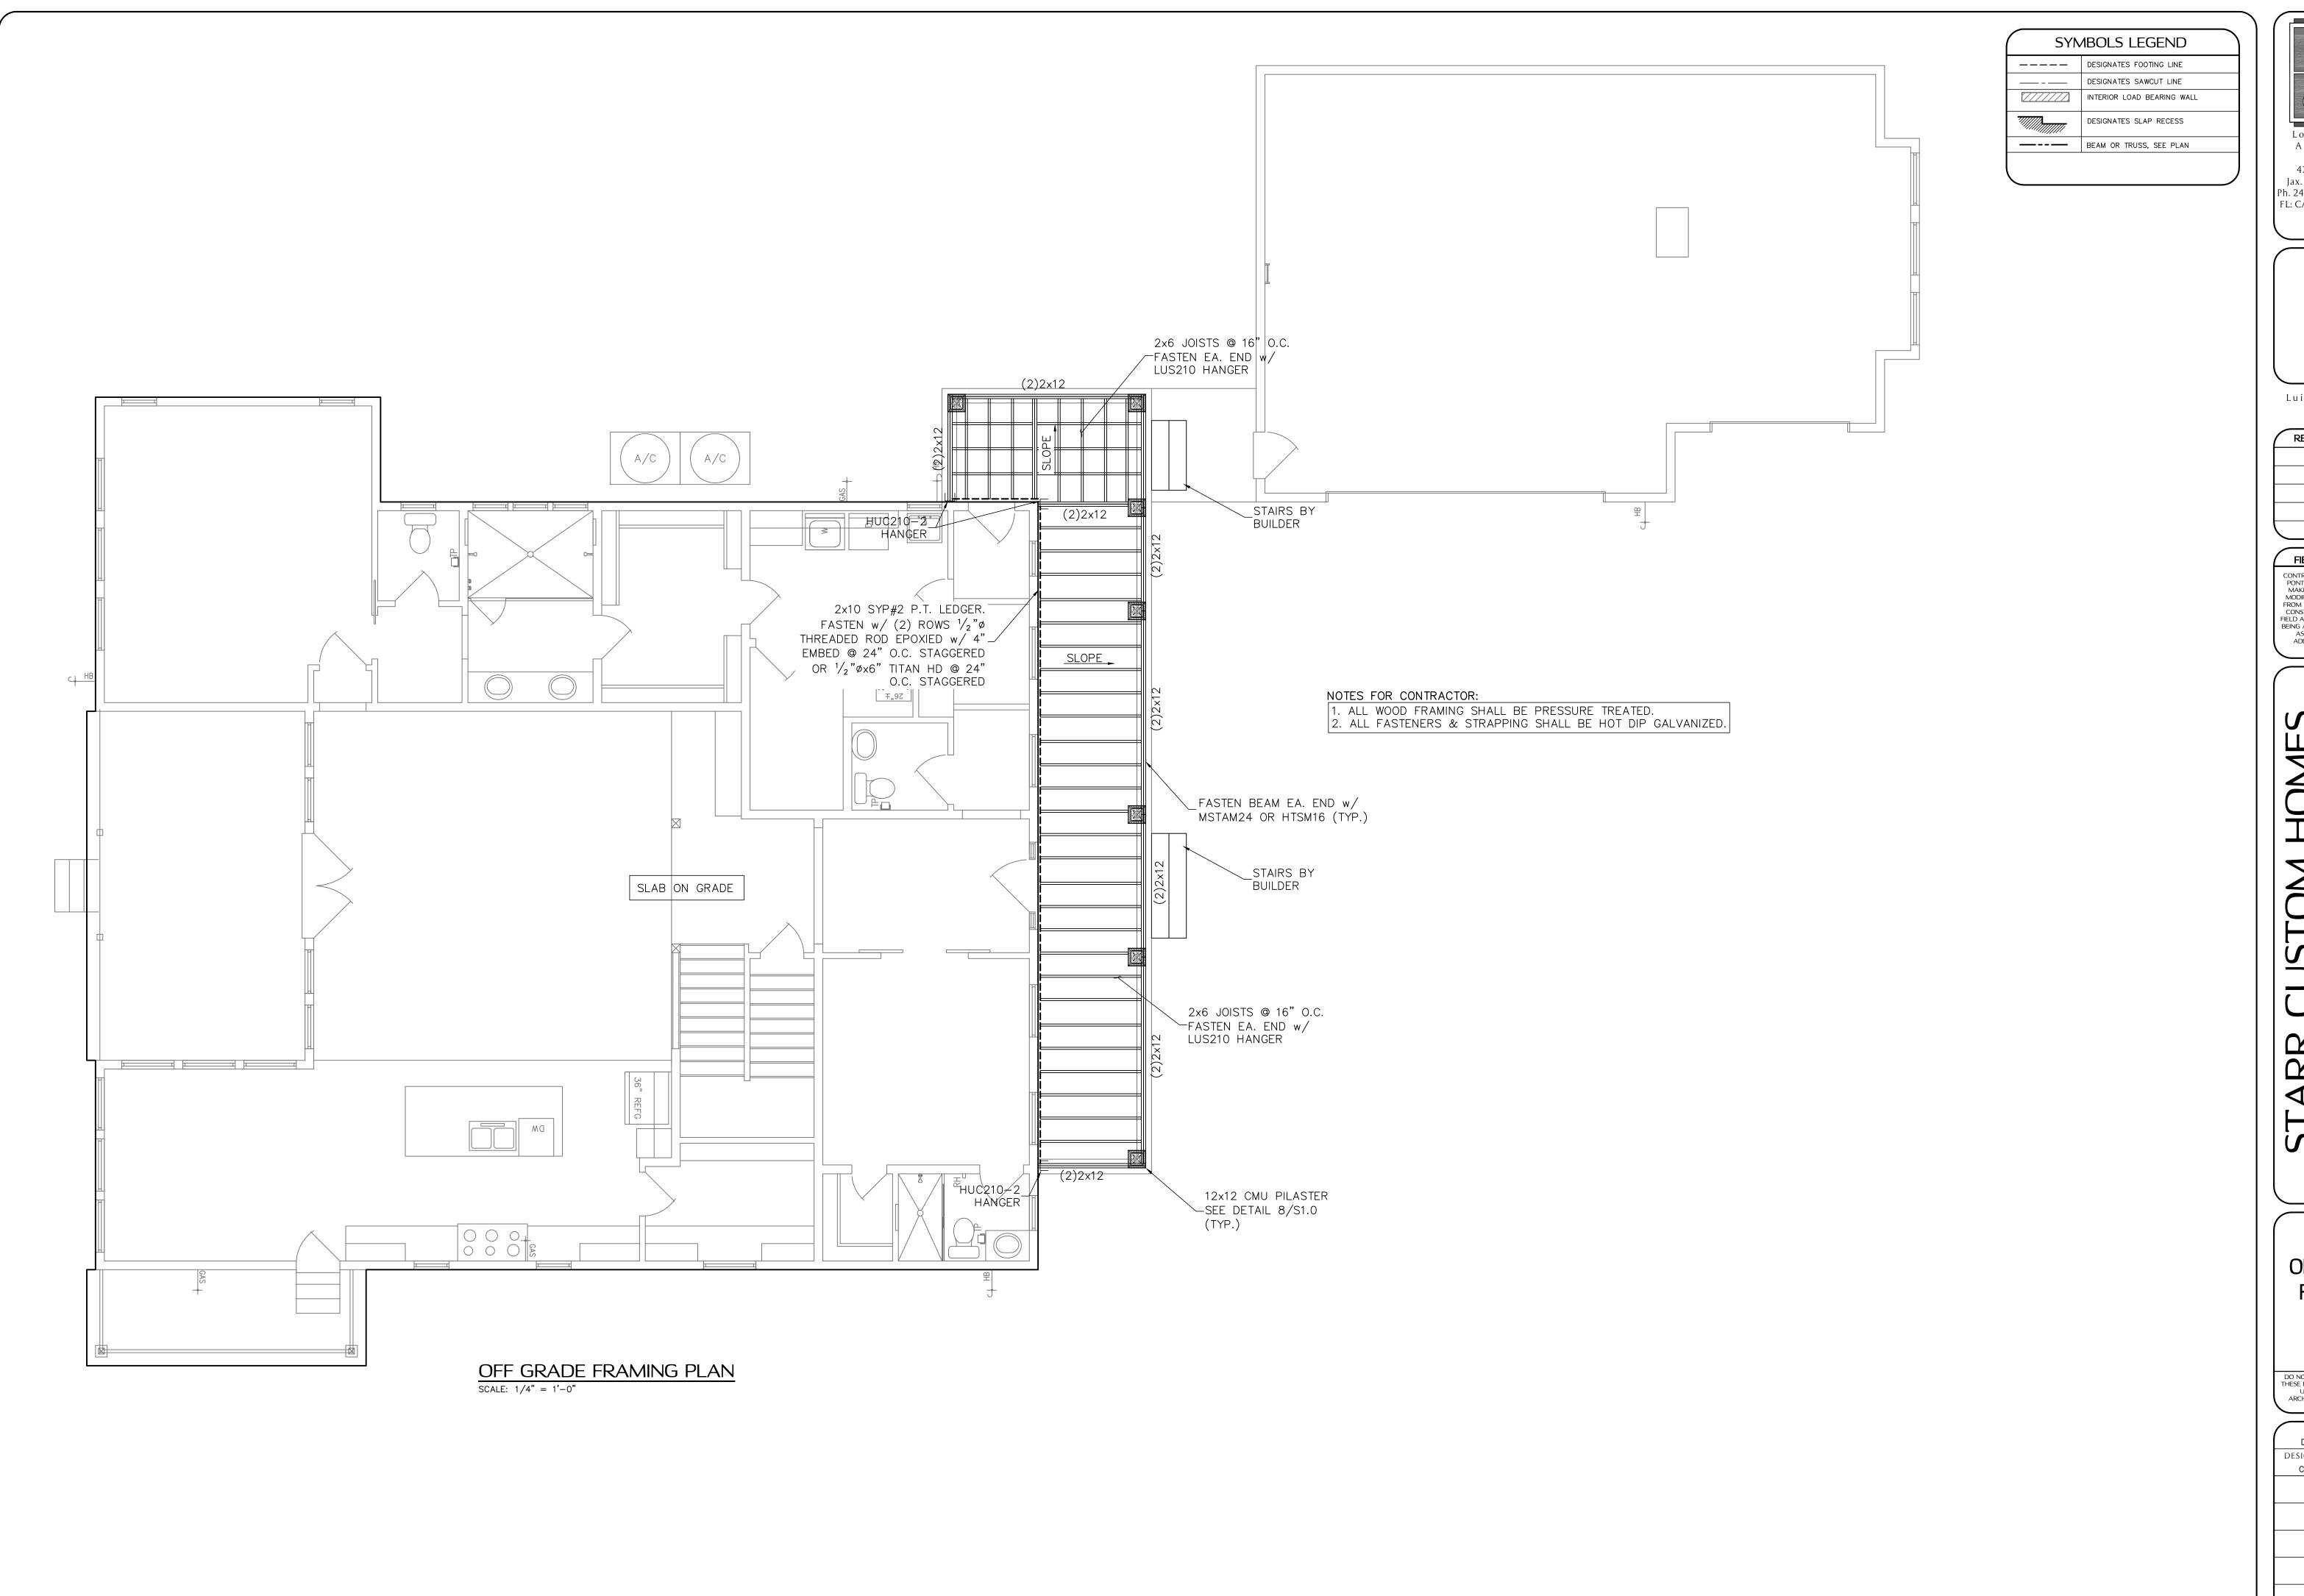

Lou Pontigo and Associates, Inc.

420 Osceola Avenue Jax. Beach, Florida 32250 Ph. 242-0908 Fax. 241-9557 FL: CA # 8344 SC: CA# 3579

Luis A. Pontigo, PE FL PE#53311

REVISIONS DATE

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OFF GRADE **FRAMING** PLAN


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REVISIONS DATE BREEZEWAY REVISION 11.21.16

FIELD ALTERATION CONTRACTOR SHALL CONTACT LOU PONTIGO & ASSOCIATES PRIOR TO MAKING ANY STRUCTURAL FIELD MODIFICATIONS WHICH MAY VARY FROM THE INTENT OF THE ORIGINAL CONSTRUCTION DOCUMENTS. ANY BEING APPROVED BY LOU PONTIGO 8 ADDITIONAL ENGINEERING OR INSPECTION FEES.

IST FLOOR FRAMING PLAN


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ARCHITECTURAL DRAWINGS OR CONTACT THE E.O.R. PLAN NAME DREAM DESIGN 29 DESIGN/DRAWN/CHECKED CS / SSI / LAP 10.18.16

SCALE AS NOTED LPA No. STRC-16-00812

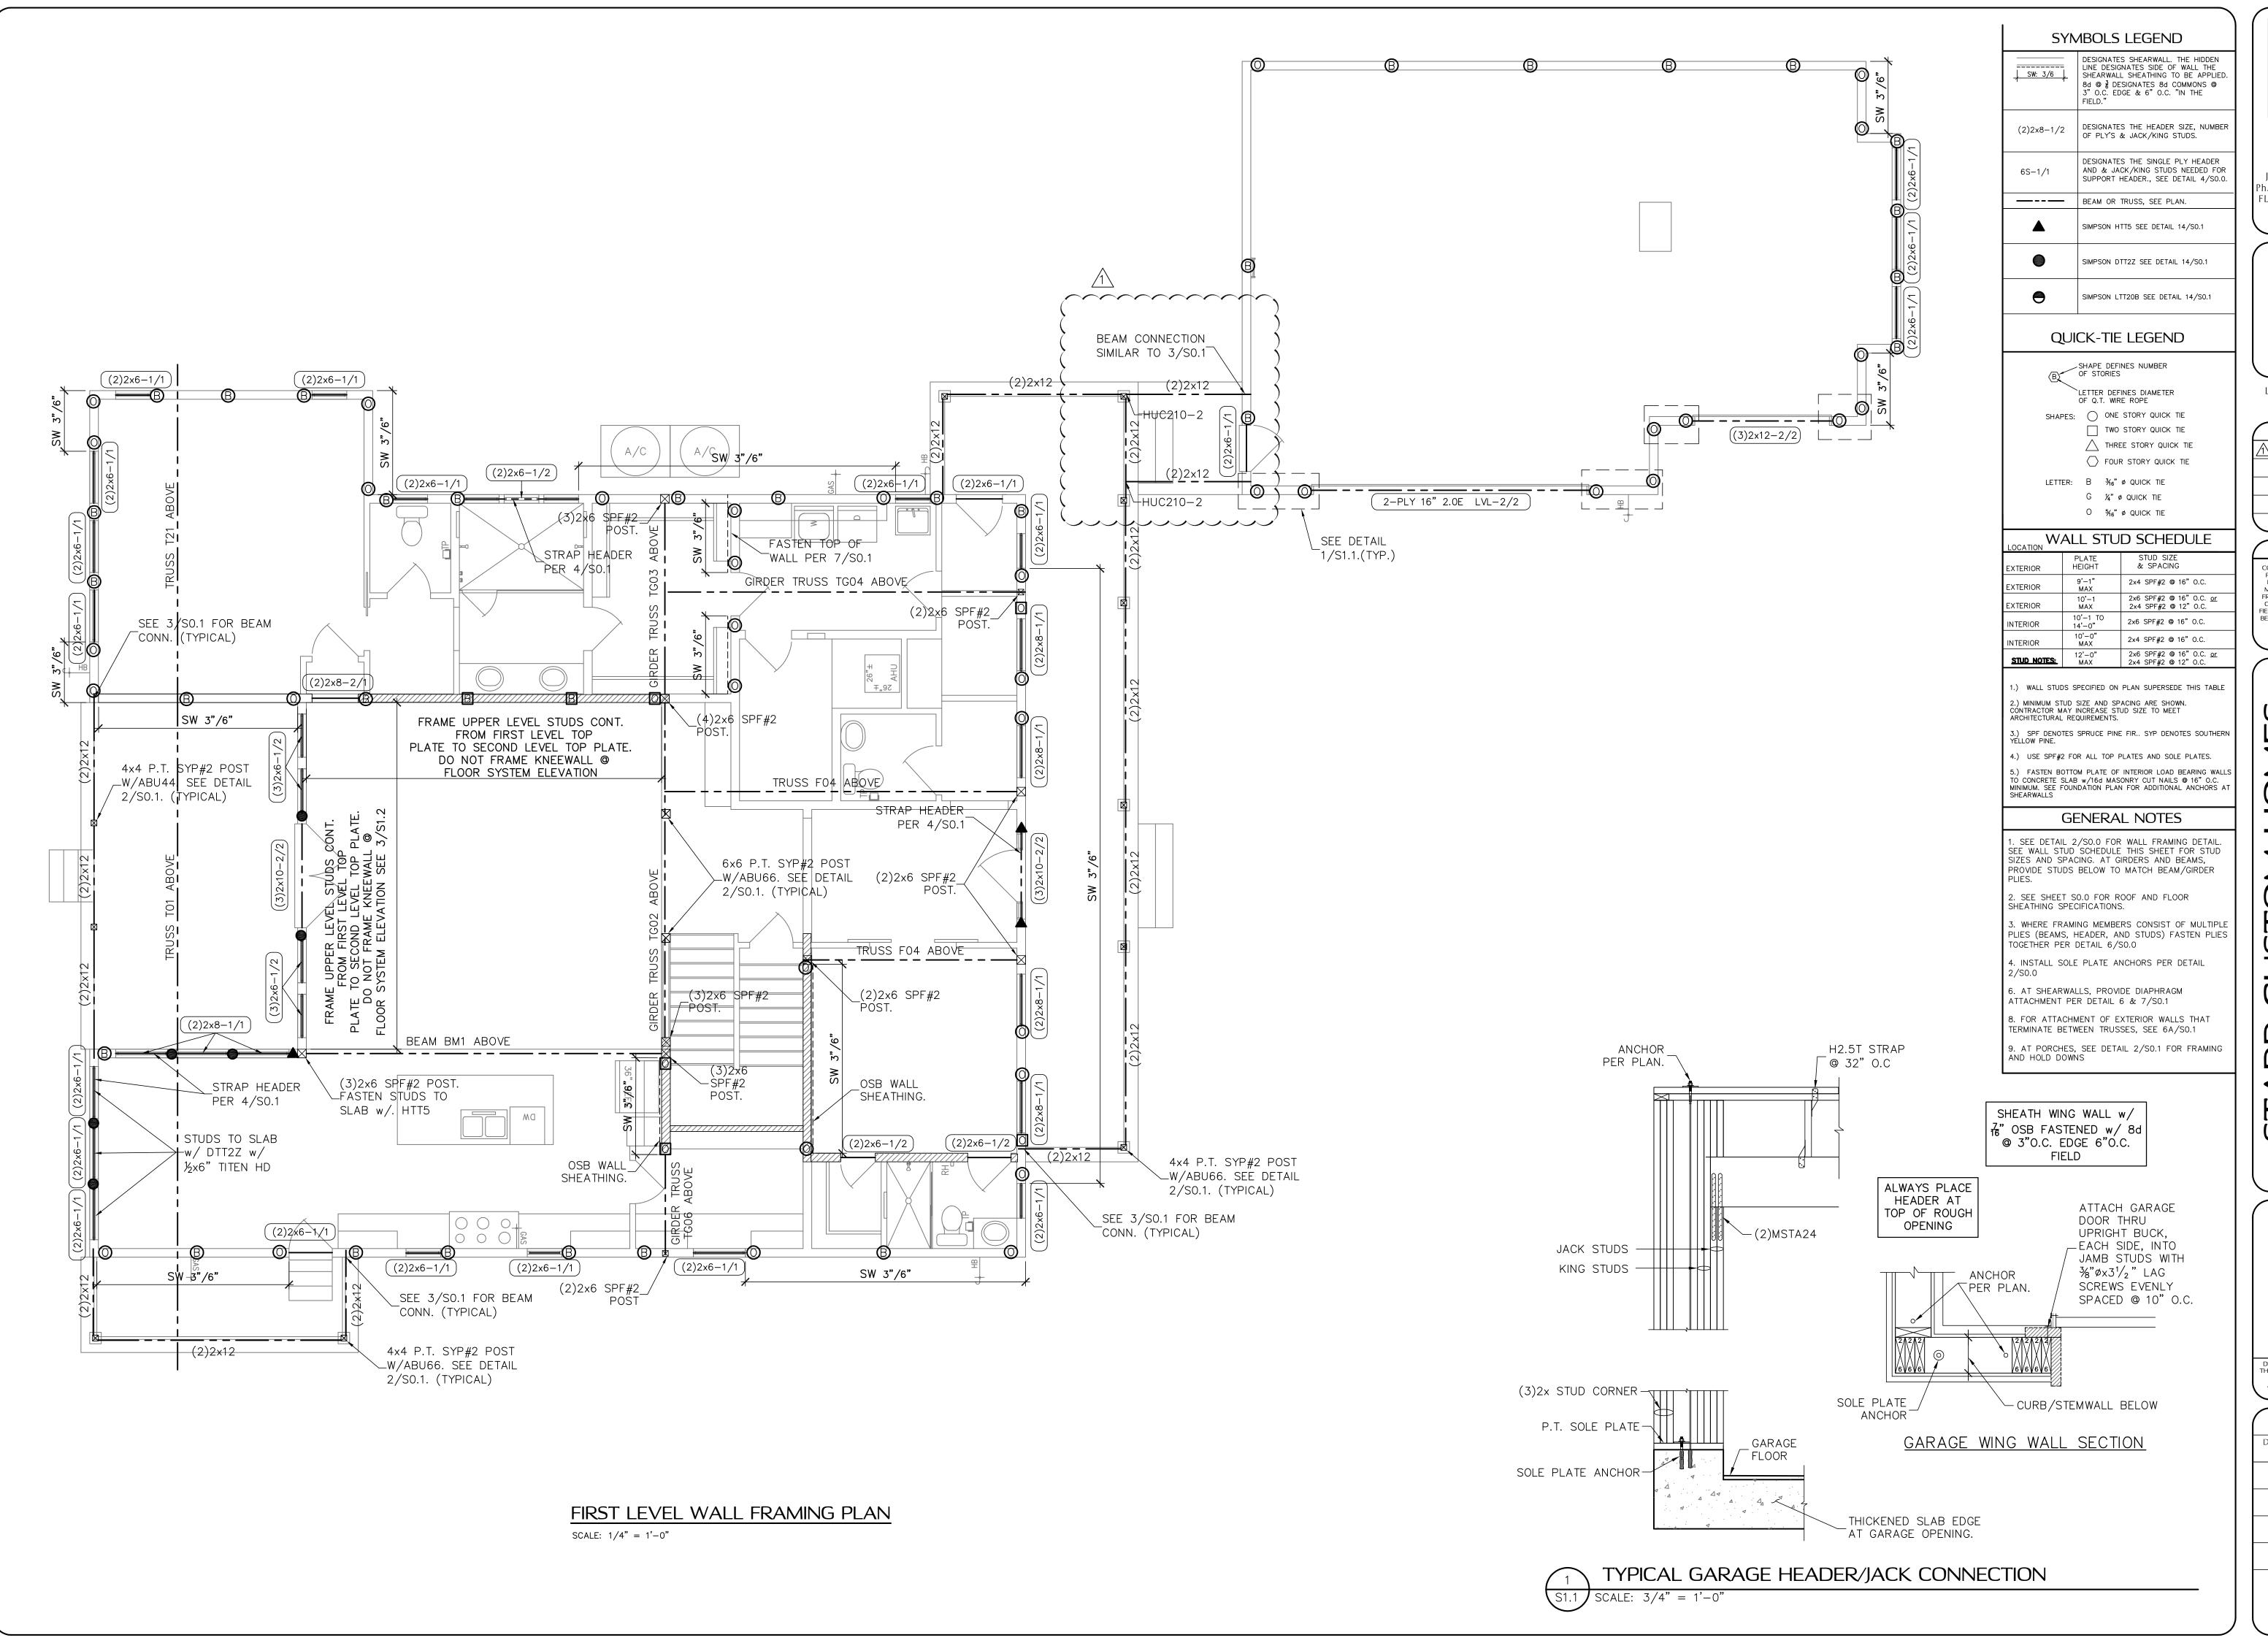CONTROL No. 2764 SHEET

S1.1 SHEET 5 OF 8



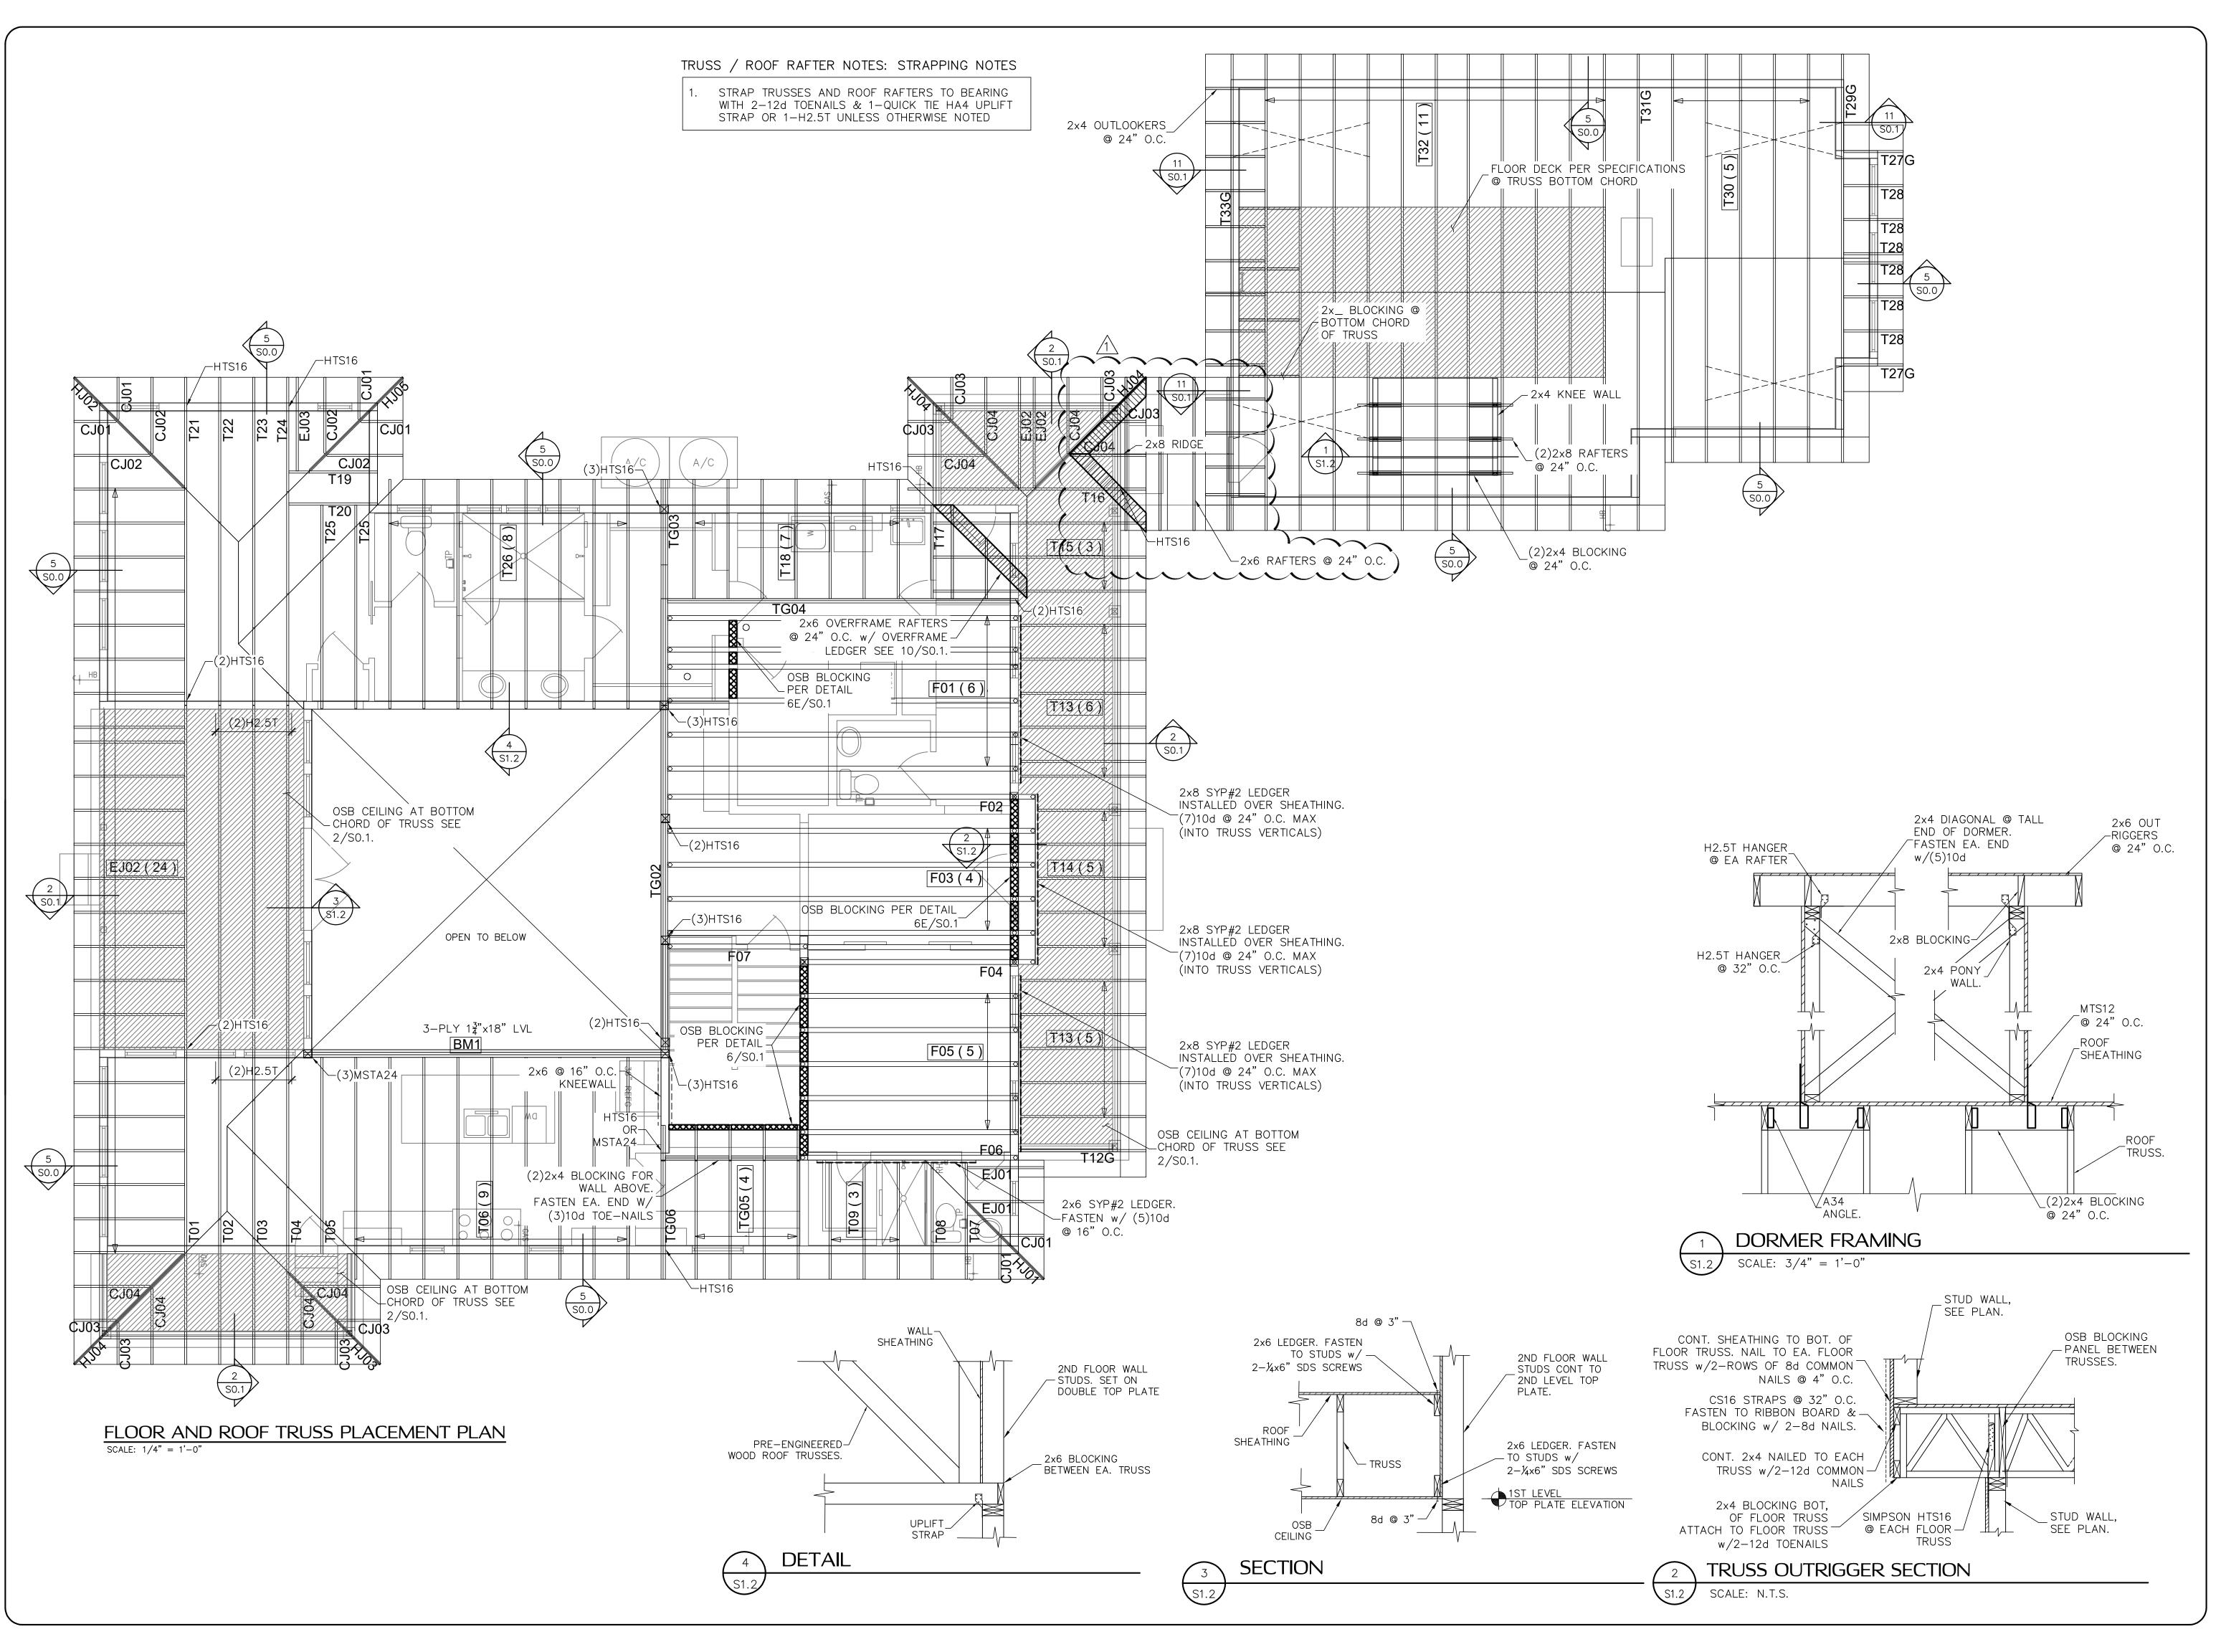

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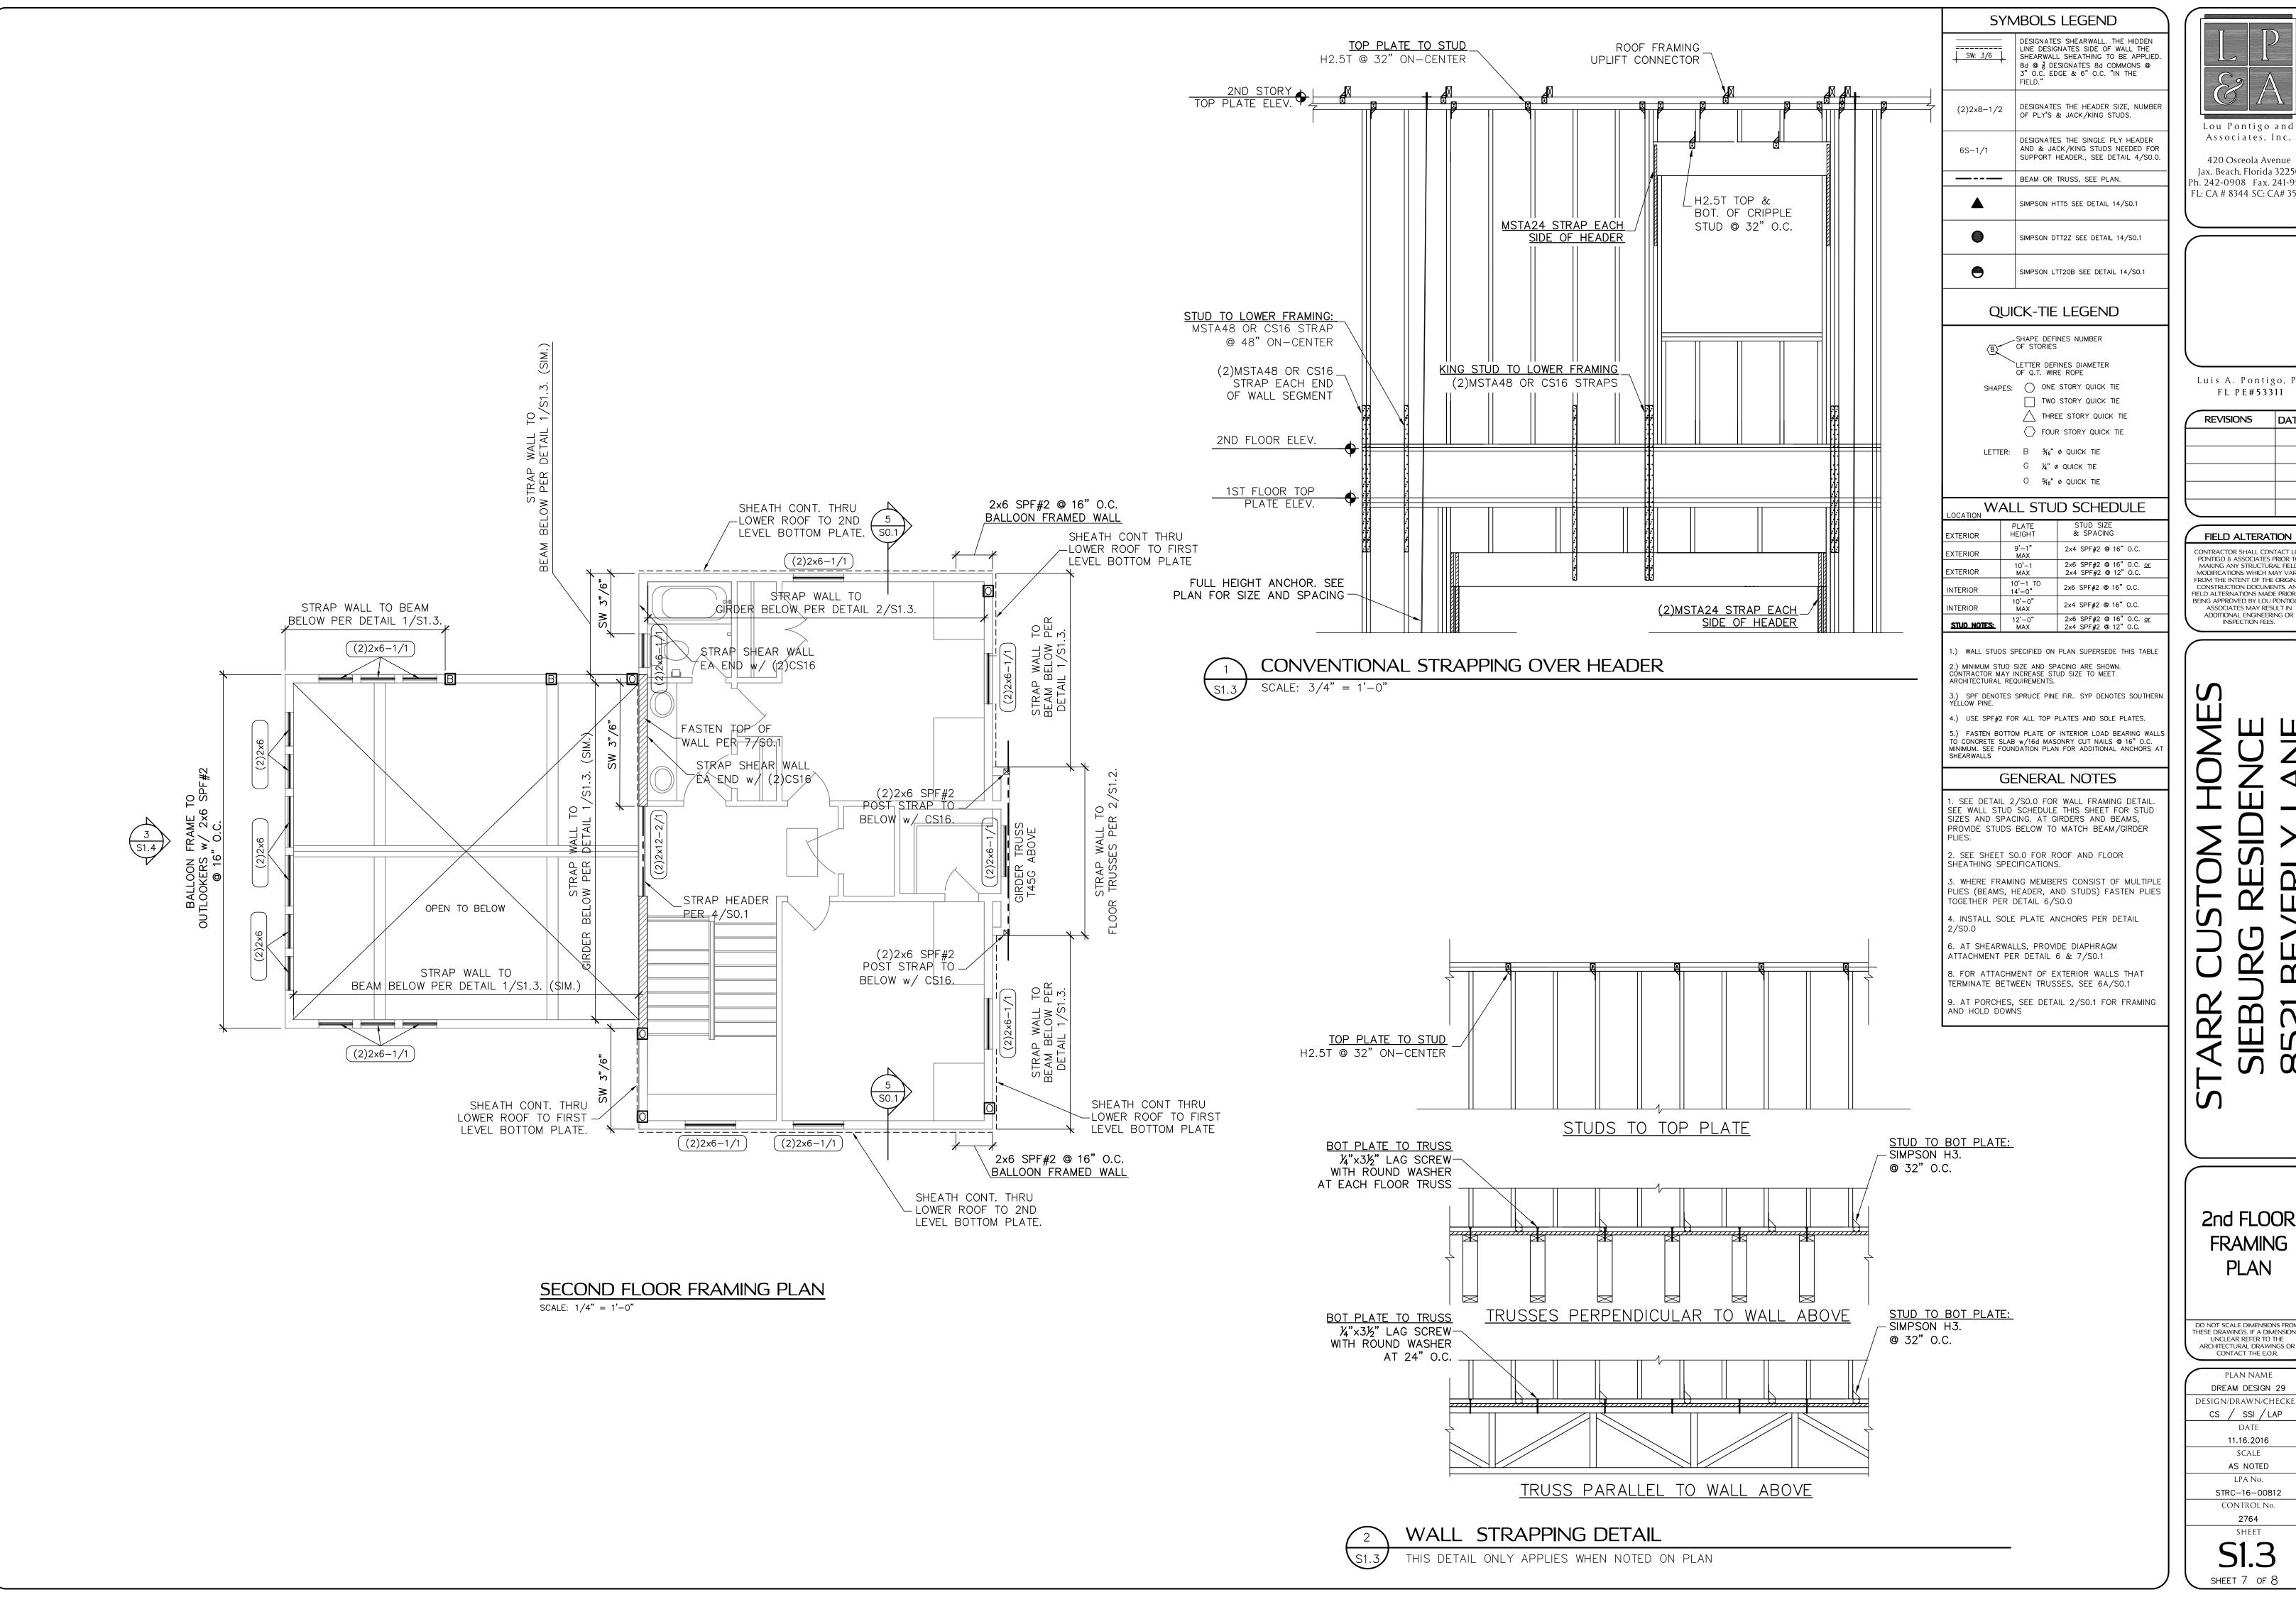
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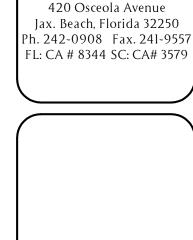
FLOOR AND ROOF TRUSS **PLACEMENT** PLAN

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SHEET S1.2 SHEET 6 OF 8





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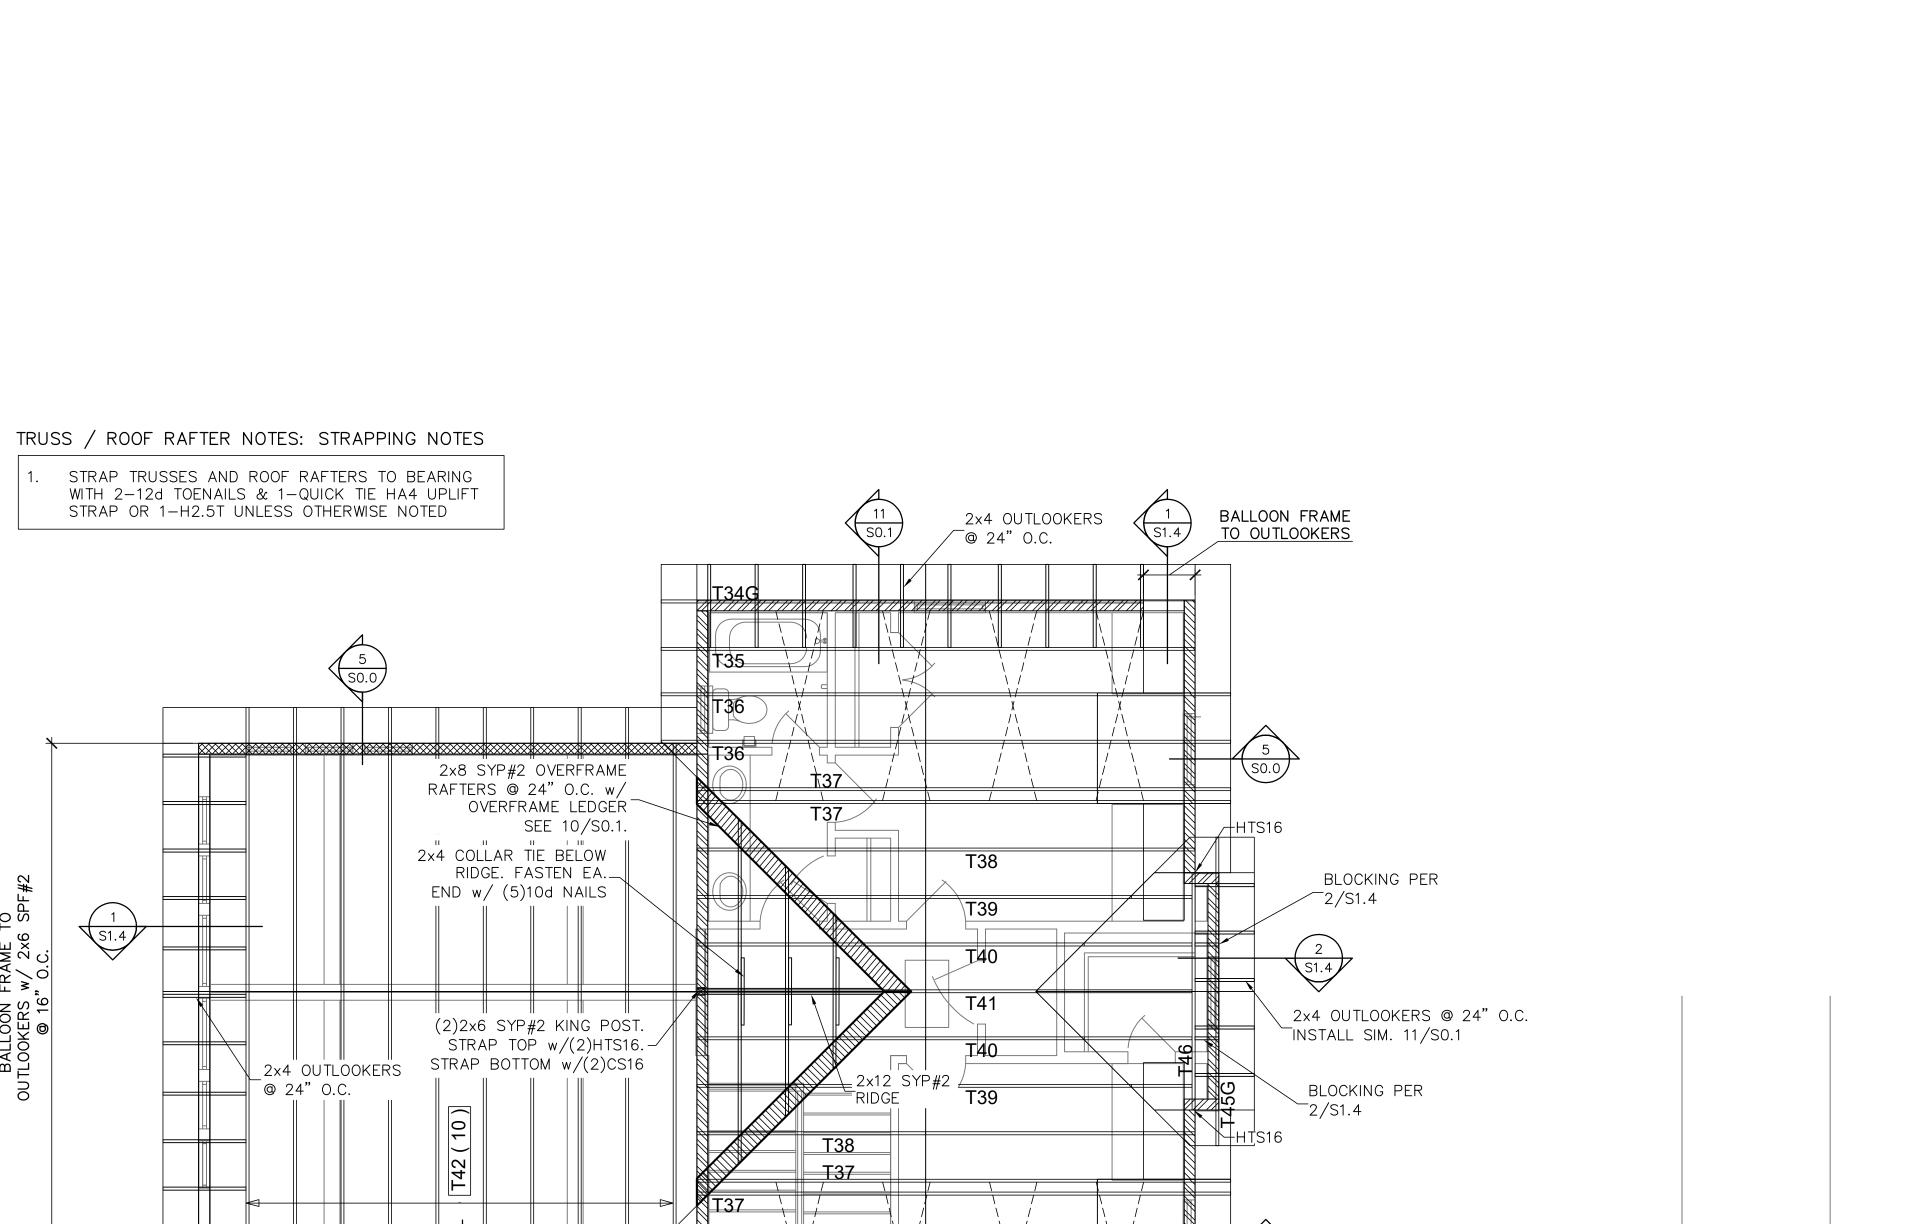
2nd FLOOR **FRAMING PLAN**

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> 2764 SHEET S1.3 SHEET 7 OF 8

CONTROL No.




ROOF TRUSS PLACEMENT PLAN SCALE: 1/4" = 1'-0"

_2x4 OUTLOOKERS @ 24" O.C.


S1.4

BALLOON FRAME


TO OUTLOOKERS

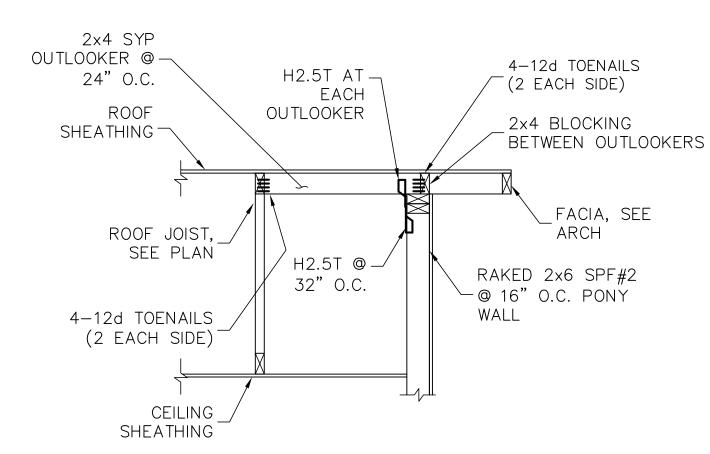

BALLOON FRAME GABLE END SCALE: 3/4" = 1'-0"

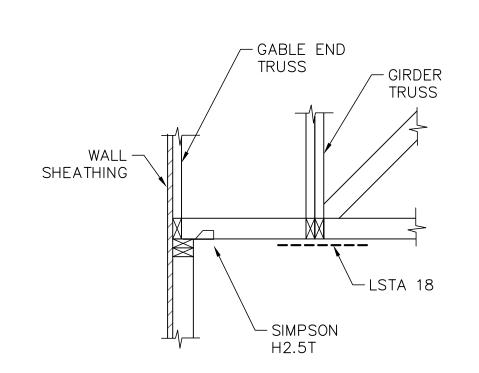


BLOCKING DETAIL

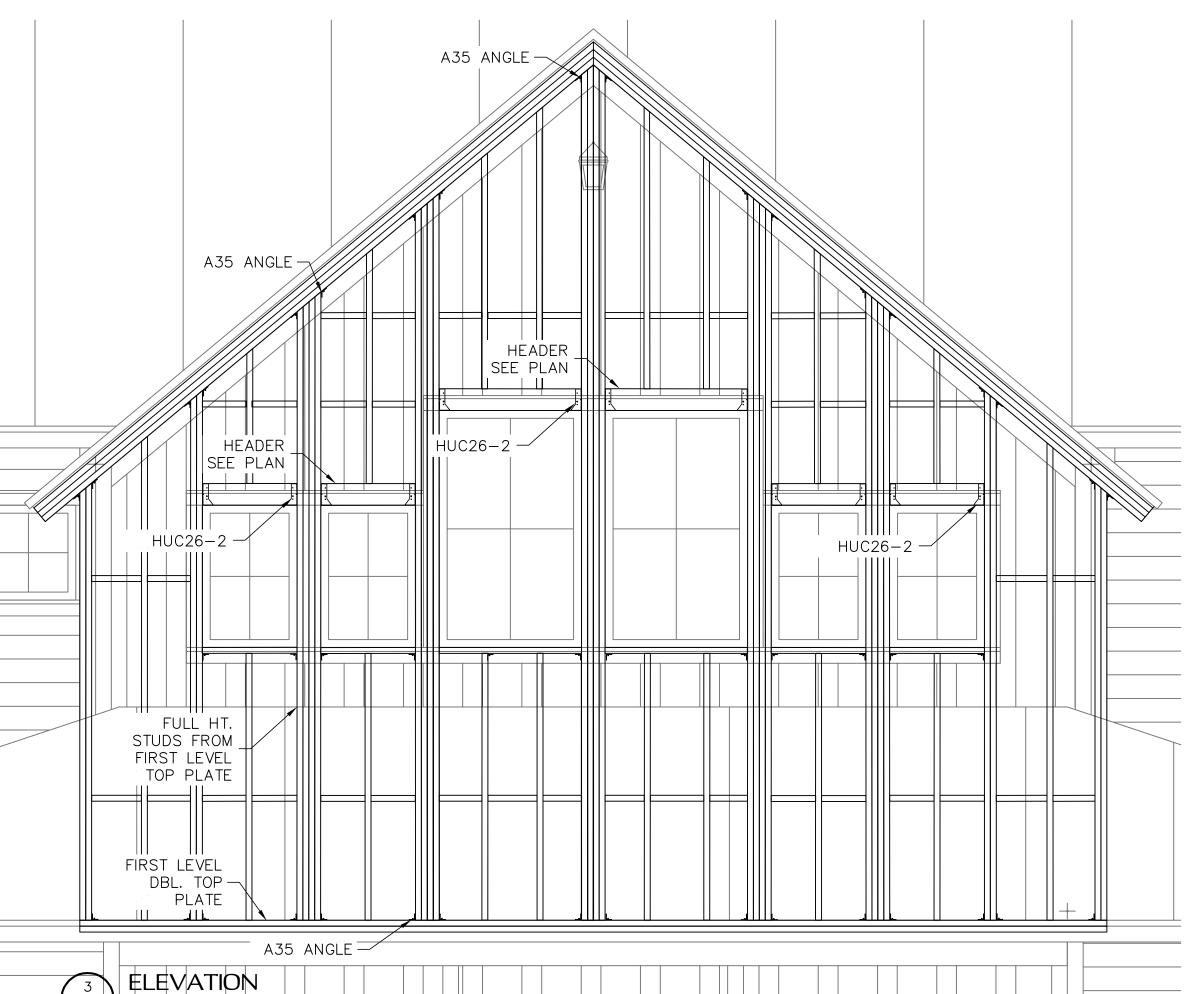



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TRUSS PLACEMENT PLAN
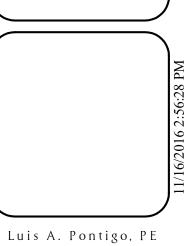
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