

# DreamDesign 29 Sieburg



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- FULL FRONT AND SIDE ELEVATION
- SECTION/ DETAILS
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- FLASHING DETAILS

# **REVISION INDEX**

					,
REV #	DISCRIPTION:	DATE:	DRAWN BY:	FOUNDATION REQUIRED:	ENGINEERING REQUIRED:
1.	ADDED A 4 COURSE STEM WALL AND CRAWL SPACE TO FRONT PORCH	07.25.16	PATRICK MANGUS	YES	YES
2.	ADDED A 5'X15' GRILLING PORCH OFF OF THE CASUAL DINING ROOM	07.28.16	PATRICK MANGUS	YES	YES
3.	MADE COST SAVING CHANGES TO WINDOWS, BRACKETS, & STAIRS	09.15.16	PATRICK MANGUS	NO	YES

# AREA EVALUATION

	11011
FIRST FLOOR-	2234 SQFT
SECOND FLOOR-	603 SQFT
TOTAL HVAC-	2837 SQFT
GARAGE-	852 SQFT
COV. ENTRY-	308 SQFT
COV. PORCH-	238 SQF1
GRIILING PORCH-	75 SQFT
TOTAL UNDER ROOF-	4283 SQFT

OVER ALL 69'-0"X 102'-6" HIGHEST PEAK 26'-4"

- 1. ALL EXTERIOR WALLS SHALL BE ASSUMED TO BE LOAD BEARING. SEE STRUCTURAL FLOOR PLAN AND FOUNDATION PLAN FOR WALL REINFORCEMENT LOCATIONS.

  2. WINDOW AND FOUNDATION PLAN FOR WALL REINFORCEMENT LOCATIONS.

  2. WINDOW AND DORS SUPPLIERS SHALL PROVIDE CURRENT ROUGH OPENING INTO WHICH SHALL HAVE PECCEDENCE OVER THE WINDOW HALL HAVE PECCEDENCE OVER THE INTERIOR CABINET ELEVATIONS SHOWN.

  3. HOWEVER THE FLOOR SHOWN.

  4. DO NOT SCALE PLANS. DIMENSIONS ARE TO BE FOLLOWED AS NOTED.

  5. ALL GLASS LOCATED IN HAZARDOUS LOCATIONS SHALL COMPLY WITH SCTION ROSD OF THE FLOORIDA BUILDING CODE STATE OF THE FLOORIDA SHOWN.

  6. IN THE FLOORIDA SHOWN.

  6. IN THE FLOORIDA SHOWN.

  6. IN WATER BASED CELING TEXTURE MATERIAL IS USED, PROVIDE 1/2" GYPSUM BOARD FOR 14" O.C. FRAIMING, OR 5/8" GYPSUM BOARD FOR 16" O.C. FRAIMING, OR 16" CAREAS BY NOT LESS THAN ½"—INCH (12.7 MM) GYPSUM BOARD FOR 16" O.C. FRAIMING, OR 5/8" GYPSUM BOARD FOR 16" O.C. FRAIMING, OR 5/8"

CURRENT BUILDING CODE.......2014
RESIDENTIAL
OCCUPANCY CLASSIFICATION.....
CONSTRUCTION TYPE.......5B

No.	DELETED WINDOWS	9.15.16
No.	Revision/Issue	Date

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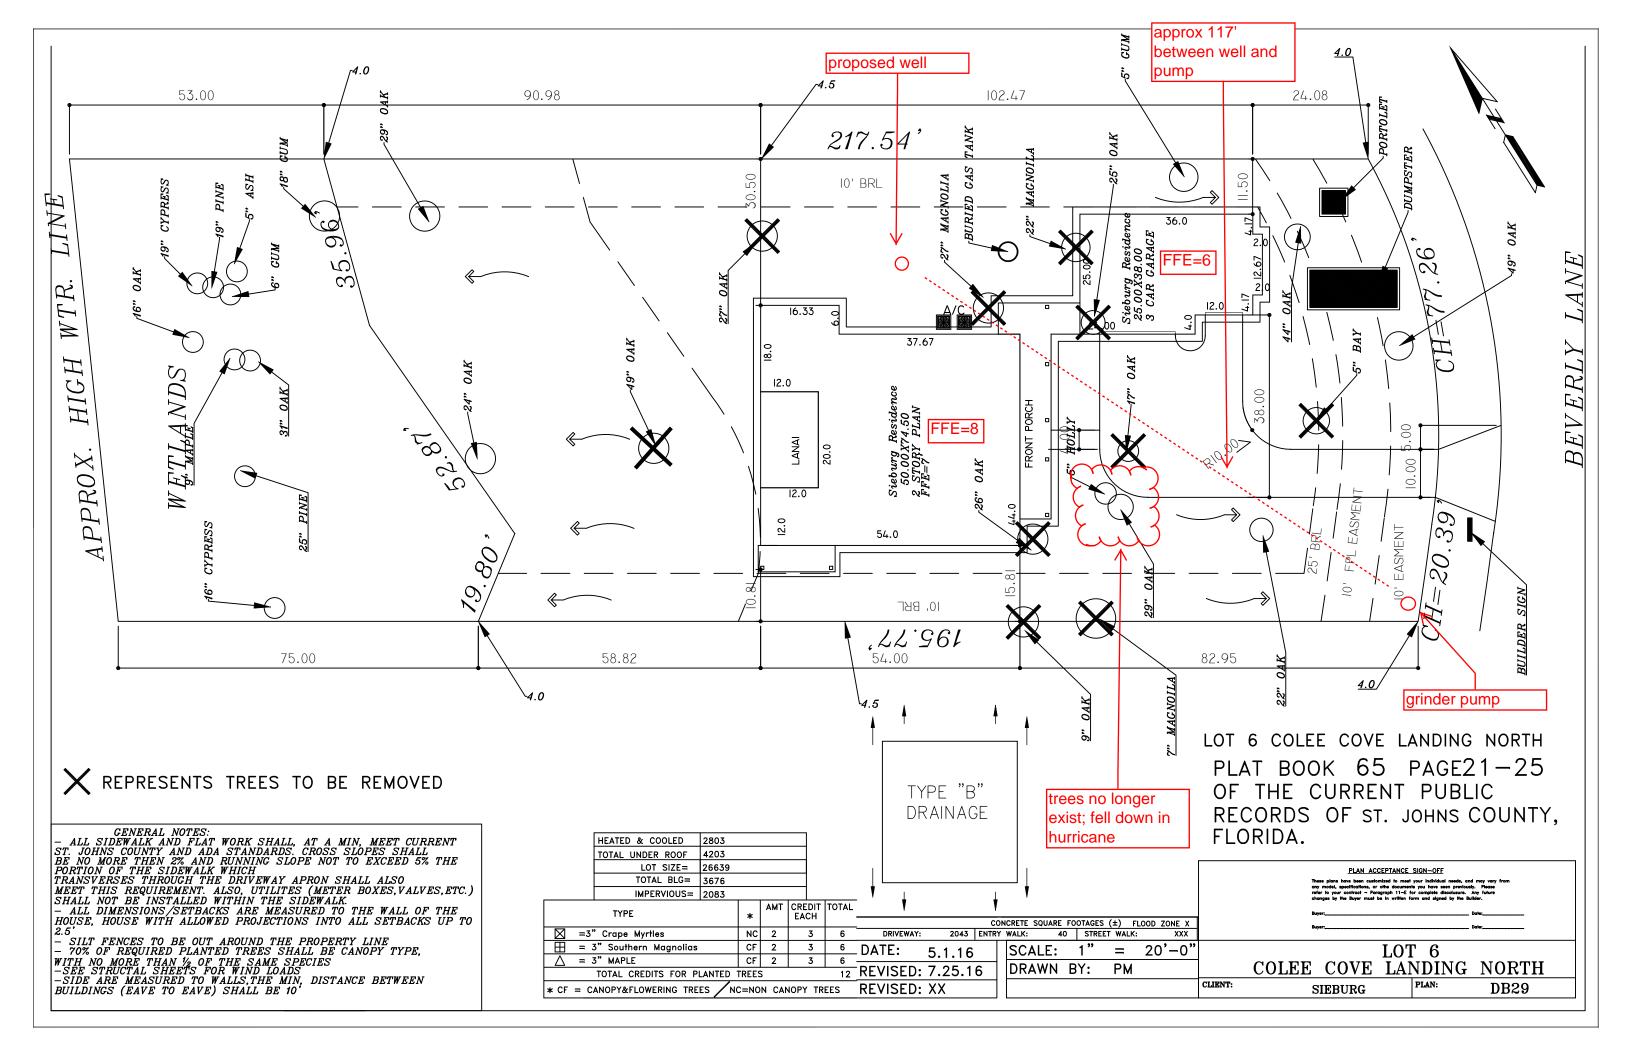
-INTERIOR DESIGNER: MS J DESIGN JOSIE MYRES MSJDESIGNINC@AOL.COM (904)535-1981


-DRAWN BY: PATRICK MANGUS PATRICKMANGUS@YAHOO.COM 904-806-2478


LOU PONTIGO & ASSOCIATES LOU PONTIGO LOU@LP-A.COM 904-242-0908


SIEBURG RESIDENCE 8521 BEVERLY LANE ST. AUGUSTINE, FL. 32092 **COLEE COVE LOT 6** 

	Project		Sheet	`
			1 of 14	
	Date	05.12.16	COVER SHE	
/	Scale	1/4"=1'-0"	NOTES	 ر



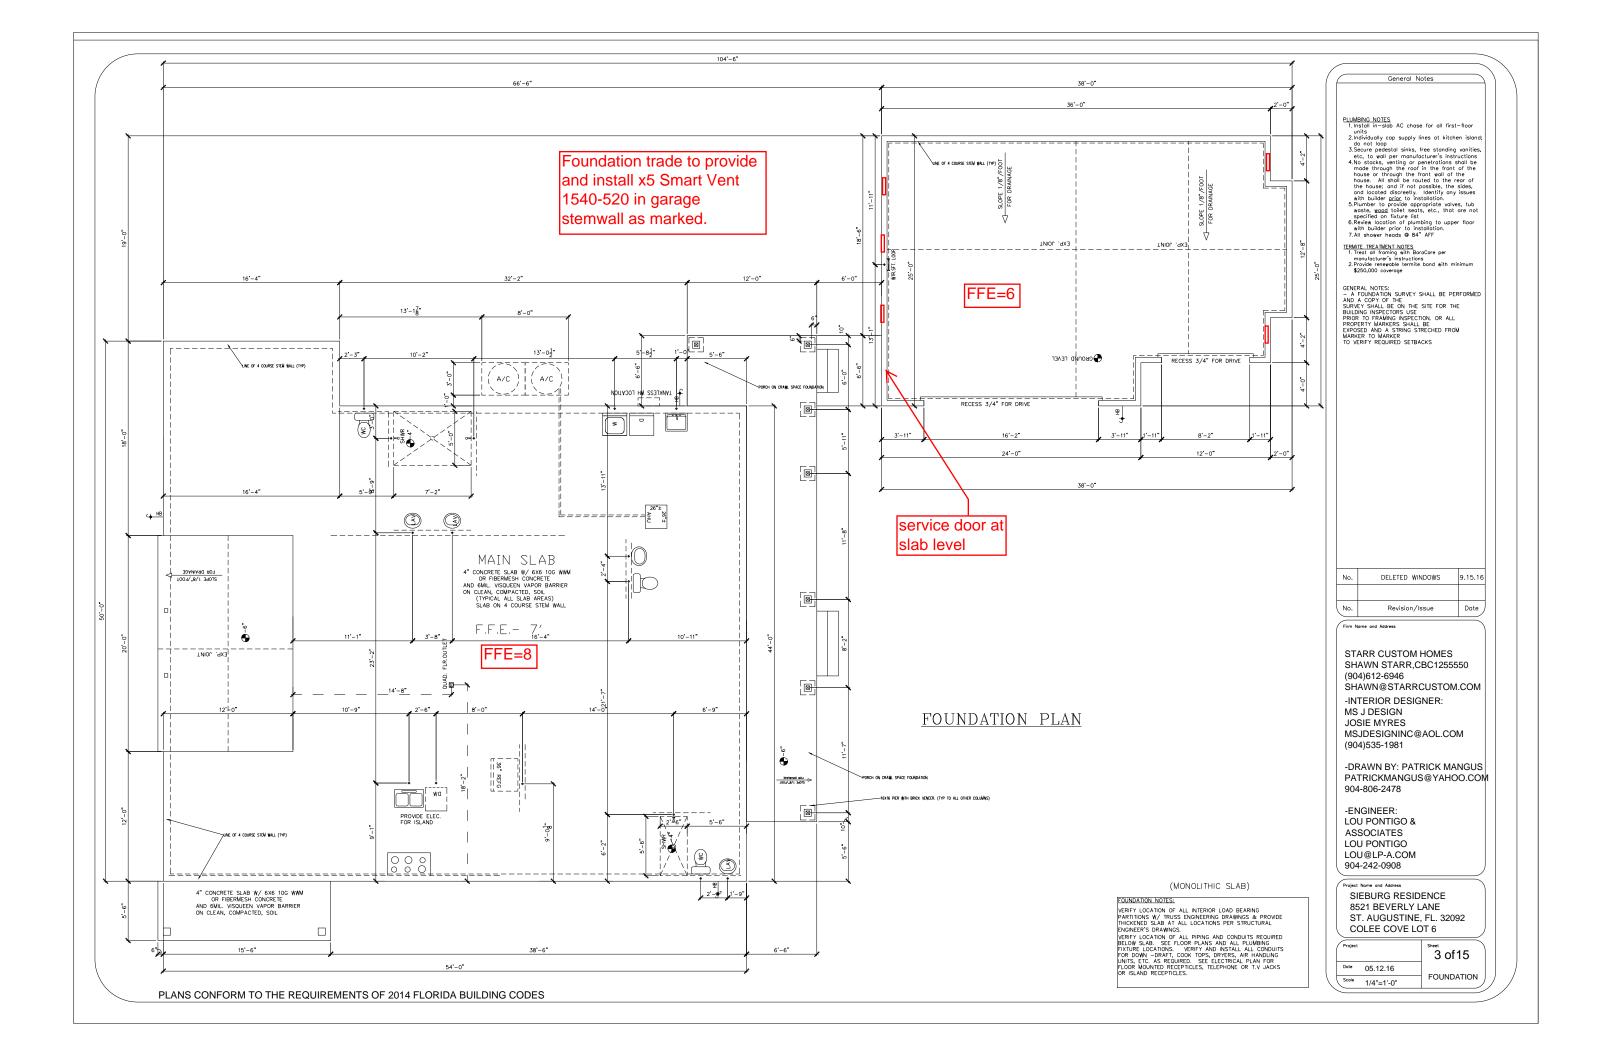

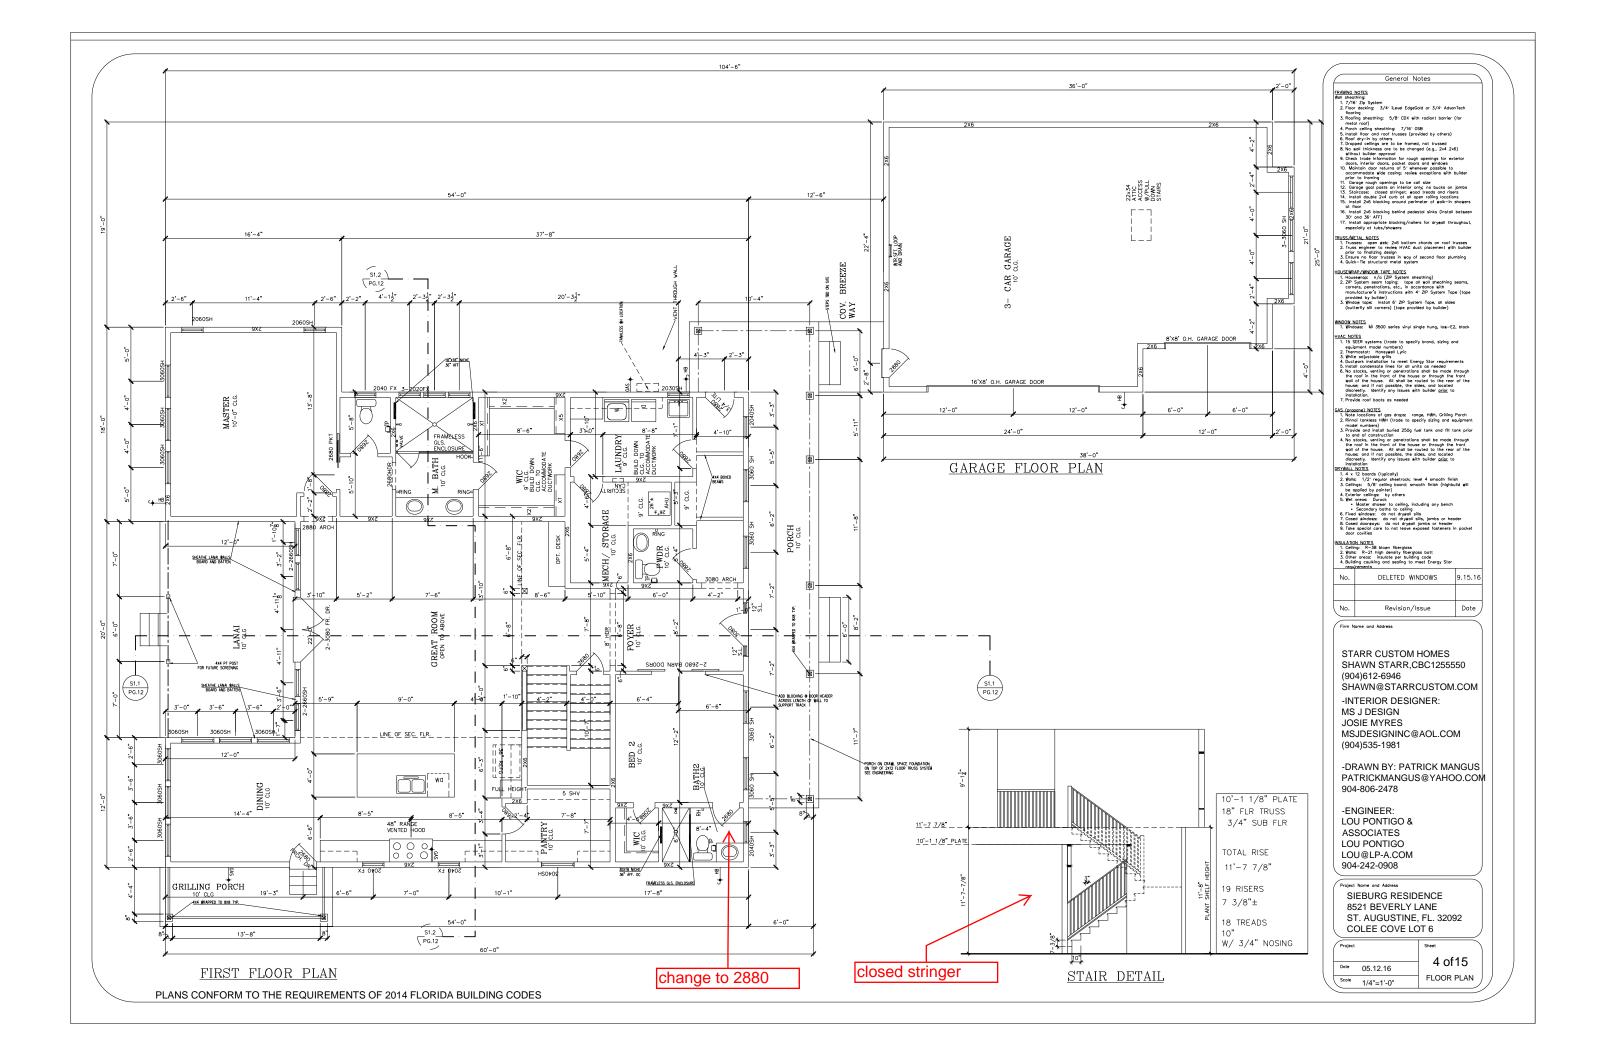

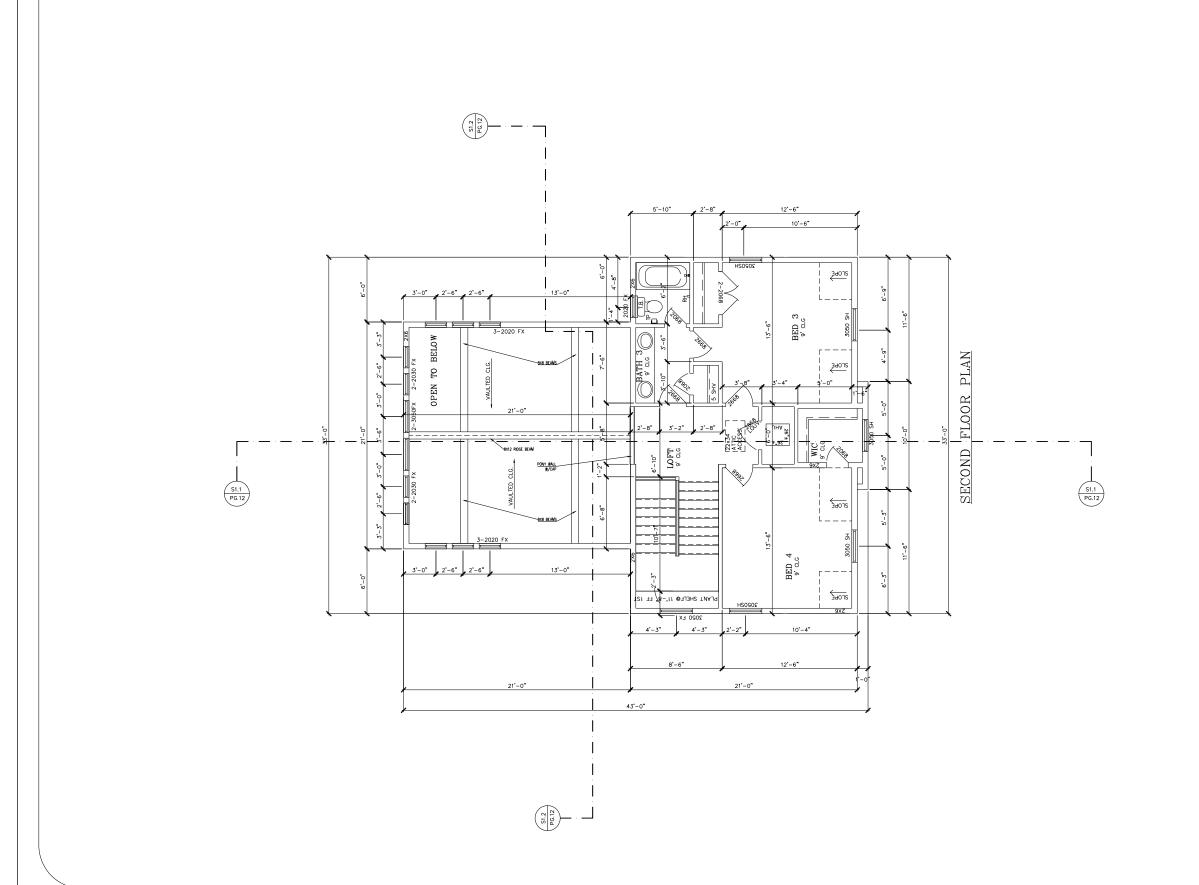

- General Notes

  FRAMINC NOITS

  Wall sheet/hing
  System
  1. Floor desking: 3/4\* Level EdgeGold or 3/4\* Advantech
  flooring
  3. Roseling sheething: 5/8\* CDX with radiant barrier (for
  4. Peach ceiling sheething: 5/8\* CDX with radiant barrier (for
  4. Peach ceiling sheething: 7/8\* CDX with radiant barrier (for
  4. Peach ceiling sheething: 7/8\* CDX with radiant barrier (for
  5. Rosel of syrth by others a formation of trusted
  8. No wall thickness are to be changed (e.g., 24 246) sithout bulber approval
  9. distribut bulber approval
  9. distribut bulber approval
  10. Marinia door returns of 7 sheethever possible to
  accommodate wide coshing review acceptions with bulbder
  11. Garage rough appeals to be call size
  12. Garage good posts on interfor only no bucks on jambs
  14. Install Cab blocking around perimeter of asth-in shoees
  15. Install 2/6 blocking around perimeter of asth-in shoees
  30 and 36 AFT)
  17. Install appropriate blocking/notlers for drywall throughout,
  especially of trusk shoemers

- IRUSS/METAL NOTES

  1. Irusses: Open seb; 2x6 bottom chords on roof trusses

  2. Truss engineer to review HVAC duct placement with builder prior to finalizing design

  3. Ensure no floor trusses in way of second floor plumbing

  4. Quick—Tie structural metal system

- Duck- Ire Structural metal system
   MUDERMAPE/MODIN TAPE, NDIS
   Housewage: n/a (2P System shealthing)
   Posystem seem loging: lose all wall shealthing seams, and the seem seem seem seems of the seems of th

# WINDOW NOTES 1. Windows: MI 3500 series vinyl single hung, low-E2, black

- 1. Windows: Mi 5000 series why single hung, logis-LZ, block HVAC NOTES.
  1. In SEEP systems (trode to specify brond, sizing and equipment mode numbers).
  3. White adjustable grist.
  3. White adjustable grist.
  4. Ducters installation to meet Energy Stor requirements.
  6. No stocks, wenting or penetrations shall be made through the roof in the front of the base or through the roof in the front of the stocks, wenting or penetrations shall be made through the roof in the front of the stocks.

  6. No stocks, wenting or penetrations shall be made through the roof to stock the stock of the discrete of the discrete stocks.

  7. In contact the stock of the stock of the discrete stock of the stock of

- 7. Provide not boots as needed

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  I have boots an lifet (trade to specify sizing and equipment

  model numbers)

  A Provise on install buried 250g lest tonk and fit tons prior

  to end of construction

  to receive the pass of those of the construction

  to construction

  to fit the front of the flowse or through the front wail of the

  house. All shall be routed to the rear of the house; and if not

  possible, the shies, and located discretely, identify any issues

  shall be a provided to the rear of the house; and if not

  possible, the shies, and located discretely, identify any issues

  and the construction of the constructio

# INSULATION NOTES 1. Calling: R-38 blown fibergloss 2. Wolls: R-21 high density fibergloss bott 3. Other areas: insulate per building code 4. Building coulking and sealing to meet Energy Star requirements

No.	DELETED WINDOWS	9.15.16
No	Paulaine /Innue	Data

Firm Name and Address

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(904)612-6946 SHAWN@STARRCUSTOM.COM

## -INTERIOR DESIGNER:

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### -DRAWN BY: PATRICK MANGUS PATRICKMANGUS@YAHOO.COM 904-806-2478


### -ENGINEER: LOU PONTIGO & ASSOCIATES


LOU PONTIGO LOU@LP-A.COM 904-242-0908

# Project Name and Address

SIEBURG RESIDENCE 8521 BEVERLY LANE ST. AUGUSTINE, FL. 32092 COLEE COVE LOT 6

Project		Sheet
		5 of 15
Date	05.12.16	3 01 13
Scale	1/4"=1'-0"	FLOOR PLAN

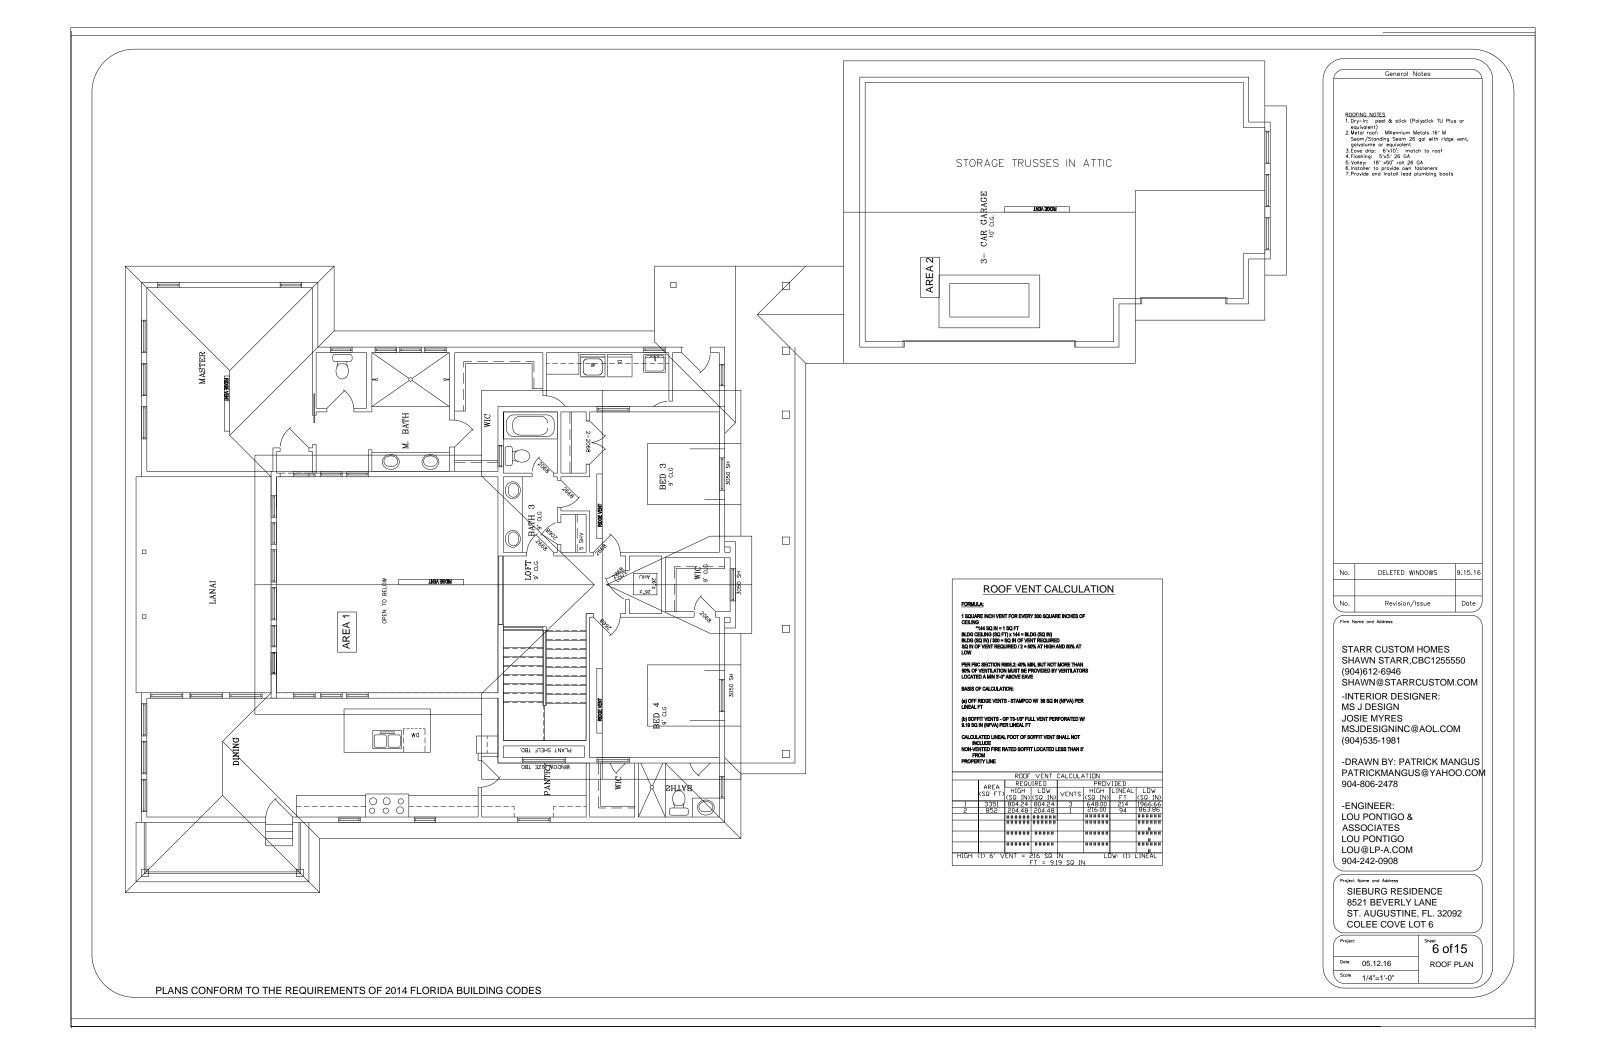


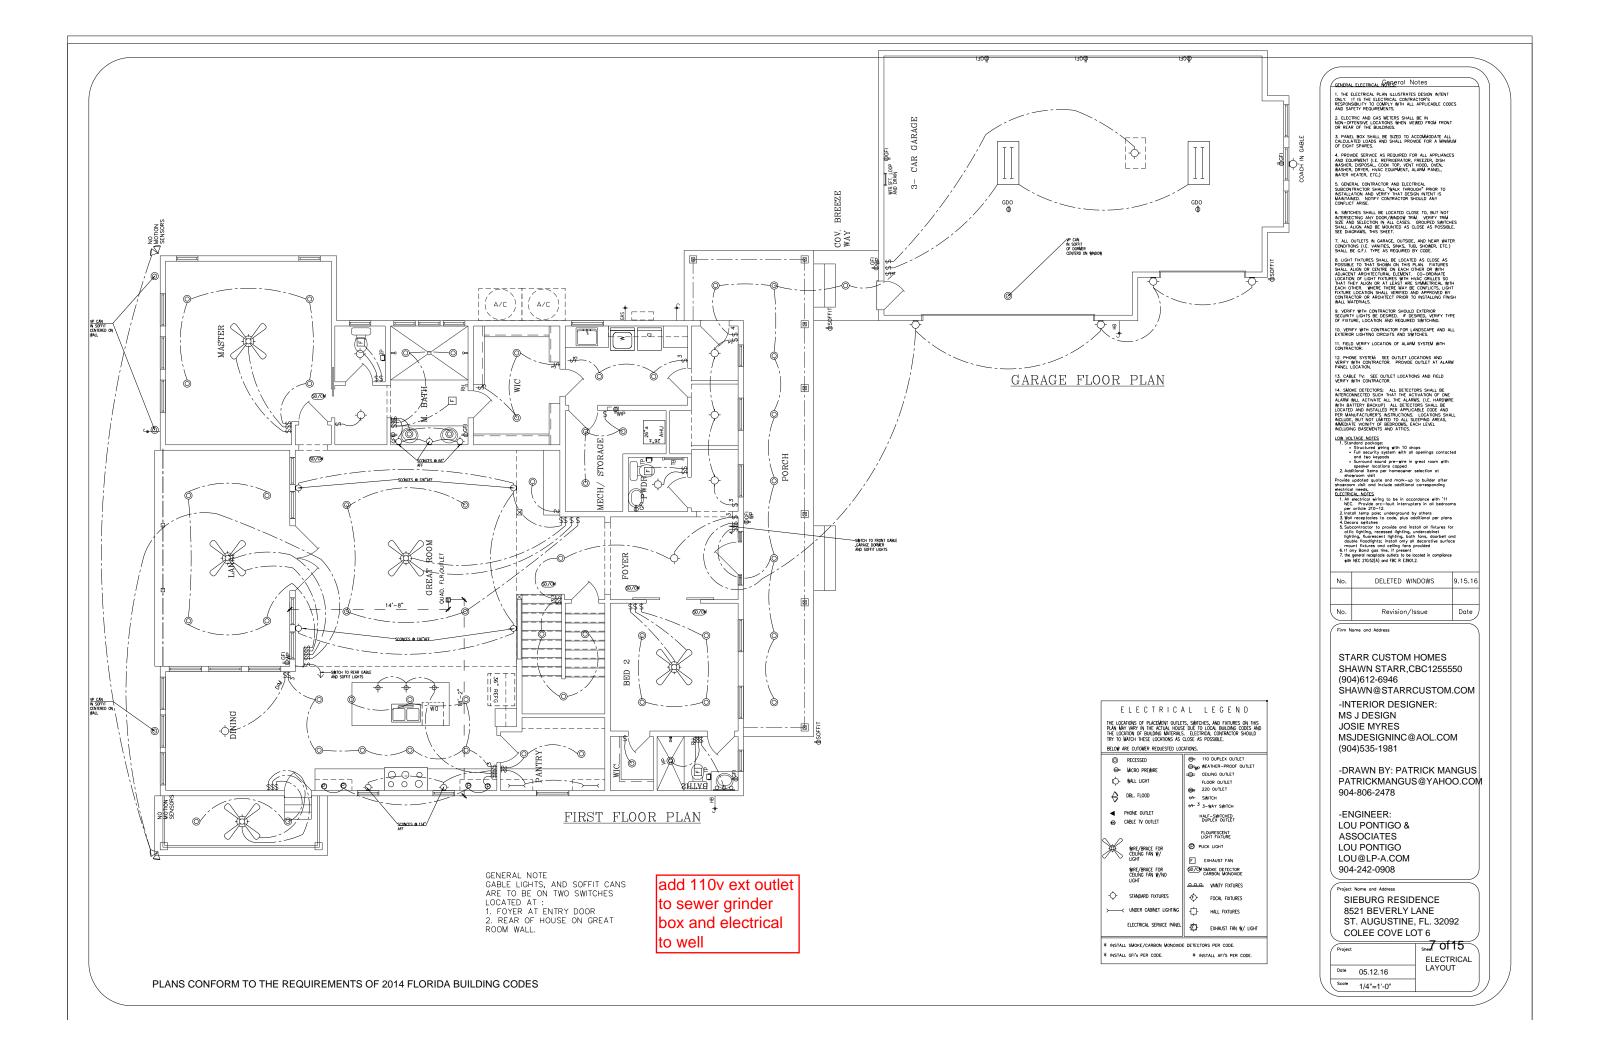

GENERAL NOTE GABLE LIGHTS, AND SOFFIT CANS ARE TO BE ON TWO SWITCHES LOCATED AT:

1. FOYER AT ENTRY DOOR

2. REAR OF HOUSE ON GREAT ROOM WALL.

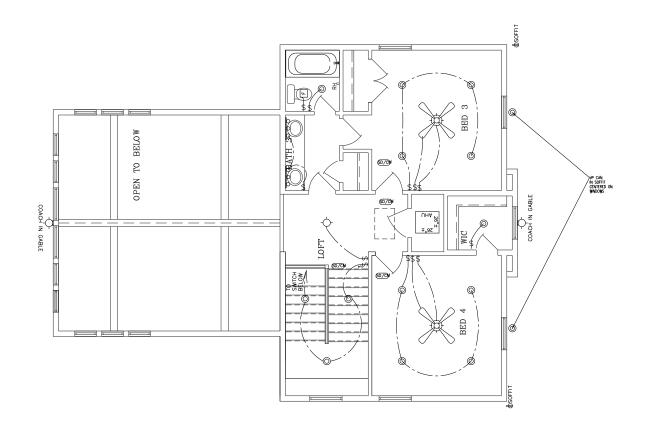

SECOND FLOOR PLAN

## ELECTRICAL LEGEND

THE LOCATIONS OF PLACEMENT OUTLETS, SWITCHES, AND FIXTURES ON THIS PLAN MAY WARY IN THE ACTUAL HOUSE DUE TO LOCAL BUILDING CODES AND THE LOCATION OF BUILDING METRIALS. ELECTRICAL CONTRACTOR SHOULD TRY TO MATCH THESE LOCATIONS AS CLOSE AS POSSIBLE.

### BELOW ARE CUTOMER REQUESTED LOCATIONS.

O- WALL LIGHT FLOOR OUTLET

# 220 OUTLET €7- 3 3-WAY SWITCH

E EXHAUST FAN

SD/CH SMOKE DETECTOR CARBON MONOXIDE ANNTY FIXTURES

-- FOCAL FIXTURES

BBL. FLOOD

■ PHONE OUTLET ⊕ CABLE TY OUTLET

HALF-SWITCHED DUPLEX OUTLET FLOURESCENT LIGHT FIXTURE WIRE/BRACE FOR CEILING FAN W/

WIRE/BRACE FOR CEILING FAN W/NO LIGHT  $\Diamond$ 

+ HALL FIXTURES ELECTRICAL SERVICE PANEL | - C)- EXHAUST FAN W/ LIGHT

\* INSTALL GFI'S PER CODE.

THE ELECTRICAL PLAN ILLUSTRATES DESIGN INTENT ONLY. IT IS THE ELECTRICAL CONTRACTOR'S RESPONSIBILITY TO COMPLY WITH ALL APPLICABLE CODES AND SAFETY REQUIREMENTS.

2. ELECTRIC AND GAS METERS SHALL BE IN NON-OFFENSIVE LOCATIONS WHEN VIEWED FROM FRONT OR REAR OF THE BUILDINGS.

GENERAL ELECTRICAL NOTES

3. PANEL BOX SHALL BE SIZED TO ACCOMMODATE ALL CALCULATED LOADS AND SHALL PROVIDE FOR A MINIMUM OF EIGHT SPARES.

4. PROWDE SERWICE AS REQUIRED FOR ALL APPLIANCES
AND EQUIPMENT (I.E. REFRICERATOR, FREEZER, DISH
WASHER, DISPOSAL, COOK TOP, WENT HOOD, OVEN,
WASHER, DIFFER, HYAC EQUIPMENT, ALARM PANEL,
WATER HEATER, ETC.)

5. GENERAL CONTRACTOR AND ELECTRICAL SUBCONTRACTOR SHALL "WALK THROUGH" PRIOR TO INSTALLATION AND VERIEV THAT DESIGN INTENT IS MAINTAINED. NOTIFY CONTRACTOR SHOULD ANY CONFLICT ARISE.

CONTROL MAISE.

6. SMITCHES SHALL BE LOCATED CLOSE TO, BUT NOT INTERSECTING ANY DOOR/MINDOW TRIM. VERIFY TRIM SIZE AND SELECTION IN ALL CASES. GROUPED SMITCHES SHALL ALLOW AND BE MOUNTED AS CLOSE AS POSSIBLE. SEE DIAGRAMS, THIS SHEET.

7. ALL OUTLETS IN GARAGE, OUTSIDE, AND NEAR WATER CONDITIONS (I.E. VANITIES, SINKS, TUB, SHOWER, ETC.) SHALL BE G.F.I. TYPE AS REQUIRED BY CODE.

SMILE DE COST. 11TH: AN INCURRED BY CODE:

8. LIGHT FRUITES SMALL BE LOCATED AS CLOSE AS
POSSBEL TO THAT SHOWN ON THIS PLAN. FRUITES
SHALL ALGO RECRIBE ON EACH OTHER OR WITH
ADACKITY ARCHITECTURAL ELEMENT. CO-CRONATE
THAT THEY ALGO OF AT ILEAST ARE SYMMETRICAL, WITH
EACH OTHER. WHERE THERE WAY BE CONSULTS, LIGHT
FRUITE LOCATION SHALL KERNER AND APPROVED BY
TRIVIER LOCATION SHALL KERNER AND APPROVED BY
WALL MATERIALS.

9. VERIFY WITH CONTRACTOR SHOULD EXTERIOR SECURITY LIGHTS BE DESIRED. IF DESIRED, VERIFY TYPE OF FIXTURE, LOCATION AND REQUIRED SWITCHING.

10. VERIFY WITH CONTRACTOR FOR LANDSCAPE AND ALL EXTERIOR LIGHTING CIRCUITS AND SWITCHES.

11. FIELD VERIFY LOCATION OF ALARM SYSTEM WITH CONTRACTOR.

12. PHONE SYSTEM: SEE OUTLET LOCATIONS AND VERIFY WITH CONTRACTOR. PROVIDE OUTLET AT ALARM PANEL LOCATION.

13. CABLE TV: SEE OUTLET LOCATIONS AND FIELD VERIFY WITH CONTRACTOR.

H. SMORE DETECTORS: ALL DETECTORS SHALL BE 
ALRAW MEL. ACTIVATE ALL THE ALARMS, LISE HARDWE 
MITH BATTERY PACKUP) ALL DETECTORS SHALL BE 
LOCATED AND MSTALLED PER APPLICABLE CODE AND 
MITH COUNTY OF THE METHOD PER APPLICABLE CODE AND 
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2. Auditor of the structure of the str

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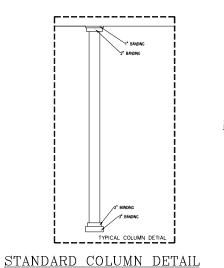
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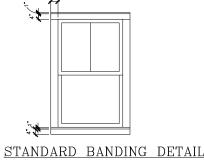
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Project Name and Address SIEBURG RESIDENCE 8521 BEVERLY LANE ST. AUGUSTINE, FL. 32092 **COLEE COVE LOT 6** 

⁵\*8 of 15 ELECTRICAL Dote 05.12.16 LAYOUT Scole 1/4"=1'-0"







- SIDING NOTES

  1. All materials primed
  2. HardiePlank Lap Siding Smooth 7 ¼\*
  (6\* reveal) lap siding
  3.5/4 HardiePrim boards, smooth
  4.4\* width Hardie panel, smooth
  5.% x 2 % Hardie batten strips, OC per
  plan, smooth
  6. Porch ceiling finish: 1x6 T&G pine
  7. Hardie-wropped columns are to be
  sandwiched with sanded seams
  8. Gable vents: paintable vinyl size on
  plans
  9. Brackets: on front poet peal
  10. Installation according to

Installation according to manufacturer's instructions
 All trim and seams to be straight, plumb and tight

# SOFFIT/FASCIA/PORCH\_CEILING/GUTTERS\_NOTES


- f vinyl:

  1. Kaycan, full 0 vent, linen
  2. Porch ceilings by others
  3. If needed: Gutters: 6" seamless;
  see gutter plan detail for locations

# STUCCO NOTES 1. Skip trowel stem wall only

STONE NOTES (on porch piers) Eldorado Stone Tundra Brick, Hartford, gray mortar

# FRONT ELEVATION

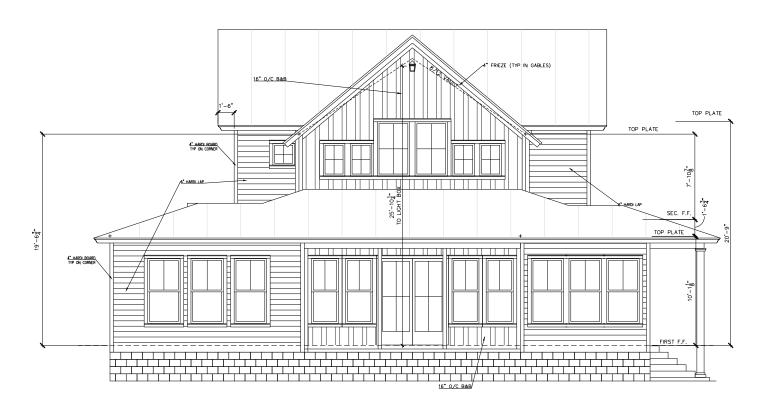

REAR ELEVATION

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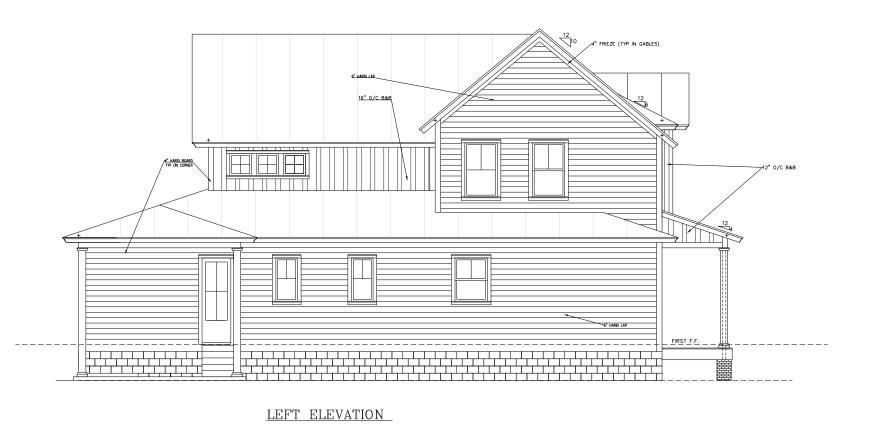
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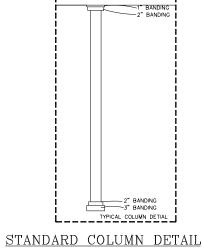
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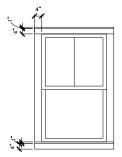
Project		Sheet	1
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Date	05.12.16	FRONT / REAF	2
Scale	1/4"=1'-0"	ELEVATIONS	

PLANS CONFORM TO THE REQUIREMENTS OF 2014 FLORIDA BUILDING CODES










RIGHT ELEVATION

STANDARD BANDING DETAIL

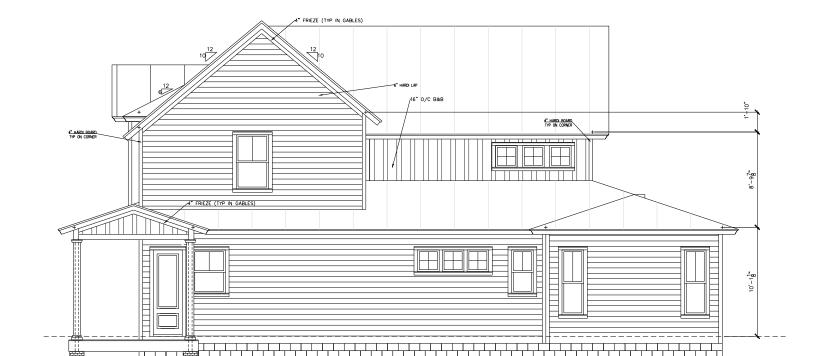

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DELETED WINDOWS

Revision/Issue

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SHAWN@STARRCUSTOM.COM

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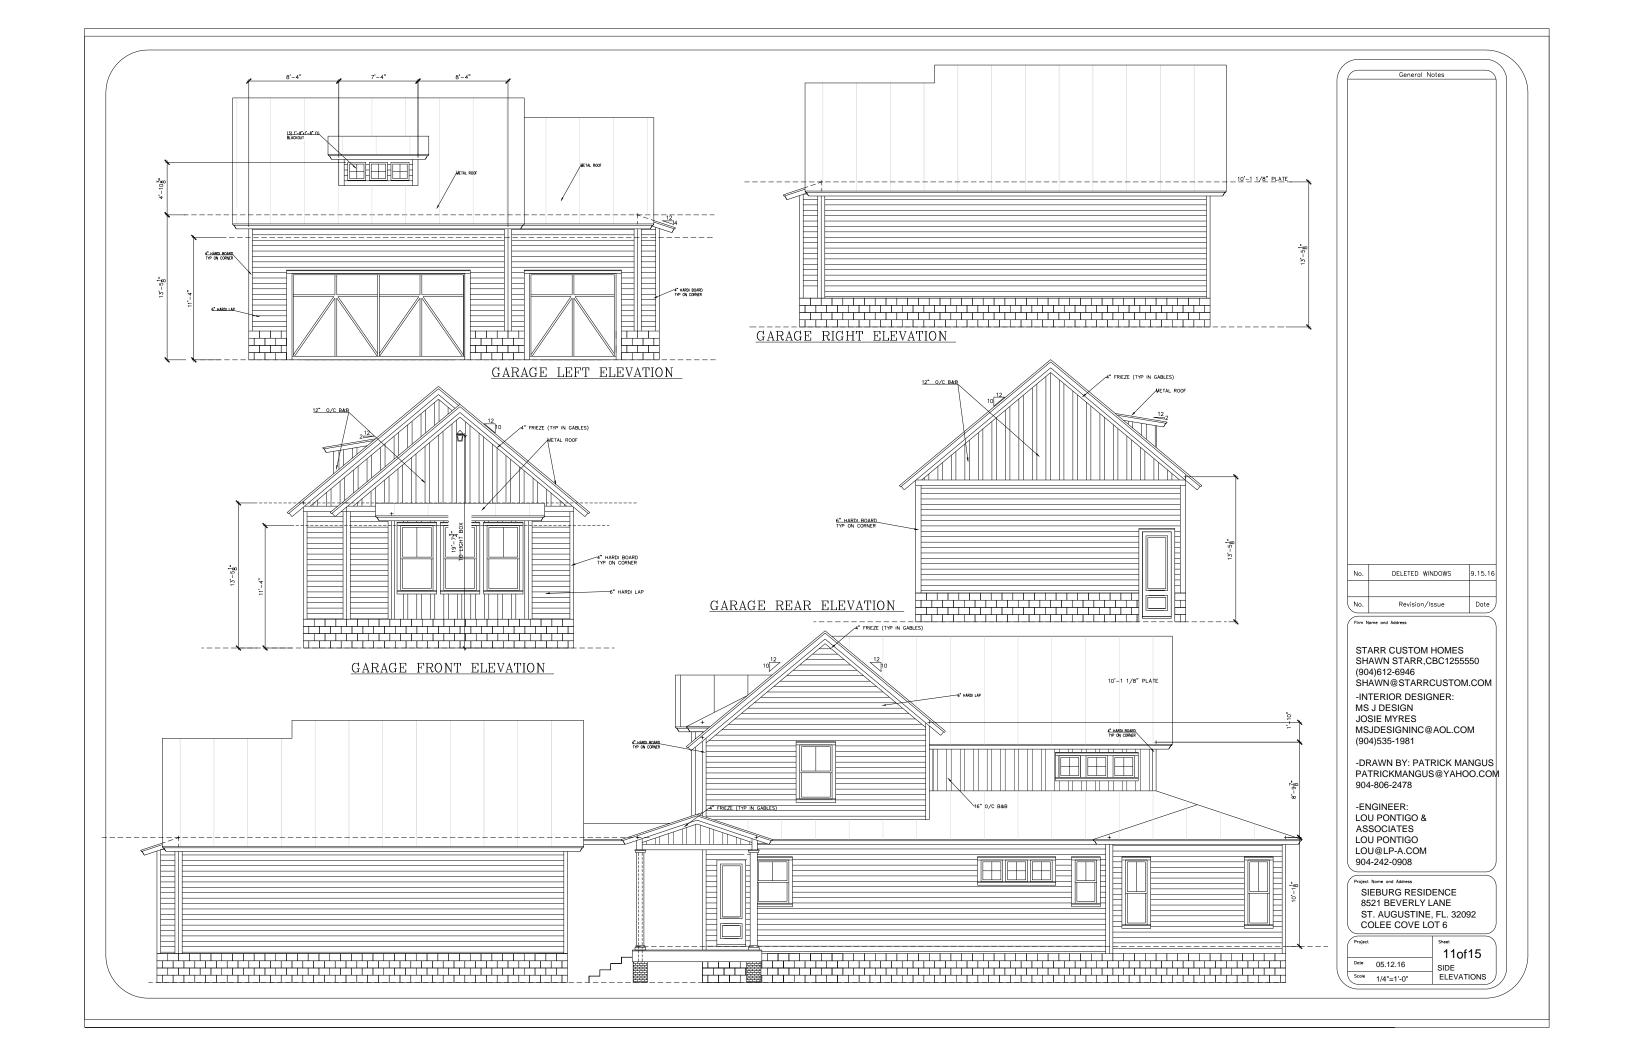
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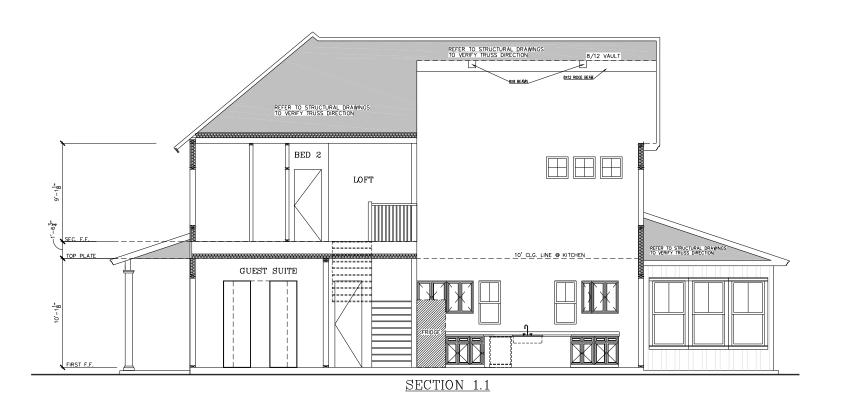
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COLEE COVE LOT 6

	Project		10of15
	Date	05.12.16	
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DELETED WINDOWS Date ) Revision/Issue


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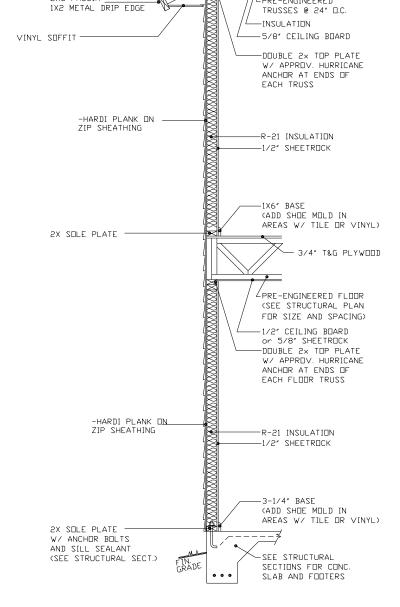
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Project		Sheet	١
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Date	05.12.16	DETAIL	
Scale	1/4"=1'-0"	WALL SECTIONS	Ι,



(SIDING)



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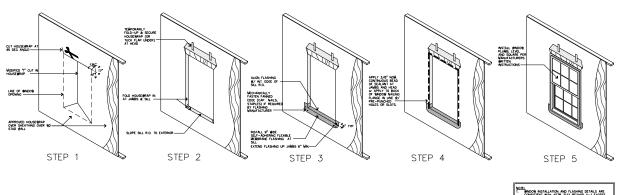
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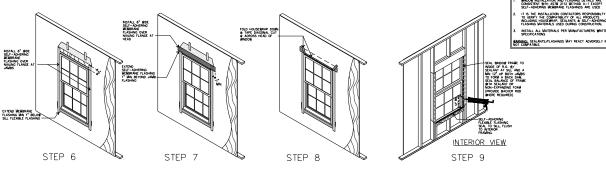
TYPICAL WALL SECTION

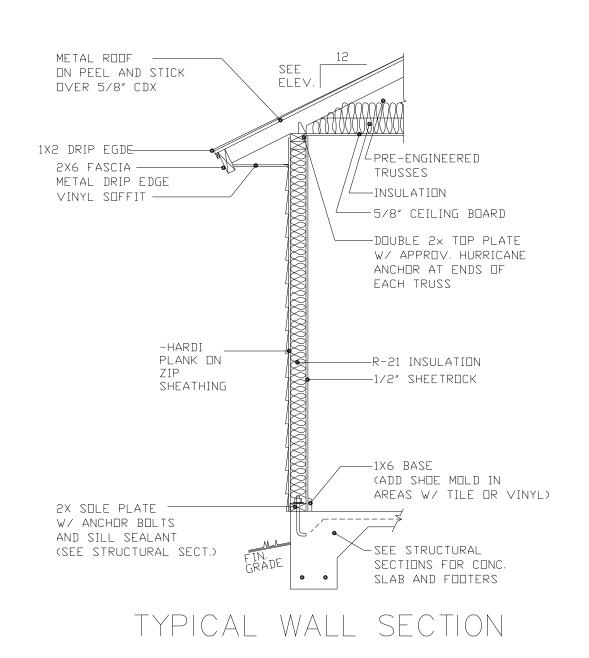TWO STORY

(SIDING)


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WINDOW FLASHING INSTALLATION DETAILS

SCALE: NTS



ALONG RAKE PLACE DRIP EDG ON TOP OF UNDERLAYMENT

-36" MIDE UNDERLAYMENT INSTALLED WITHOUT WRINKLES, USE ONLY ENOUGH NALS TO HOLD UNDERLAYMENT IN PLACE UNIL COVERED BY SHINGLES

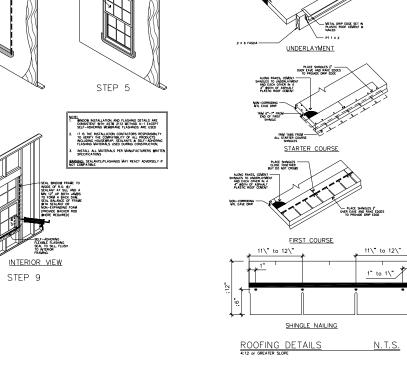FIBERCLASS SHINGLE ROOFING OVER 15# FELT OVER 7/16" OSB OVER PRE-ENG NO TRUSSES


1. INSTALL IN STRICT ACCORDANCE WITH

2. APPLY ROOFING CEMENT OR SELF-ADHERING FLASHING OVER FLANCE HEAD ONLY

DETAIL OFF-RIDGE VENT


GALVANIZED WETAL OFF-RIDG VENT WITH BAFFLE, SET IN PLASTIC ROOF CEWENT OR SEALANT

NSTALL OFF-ROGE VENT-FLANGE OVER SHINGLE AT BASE - ALONG EAVES PLACE UNDERLAYMENT ON TOP OF WETAL DRIP EDGE

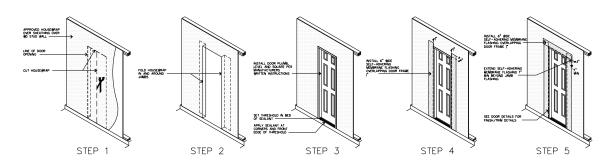

DOOR FLASHING INSTALLATION DETAILS

SCALE NS

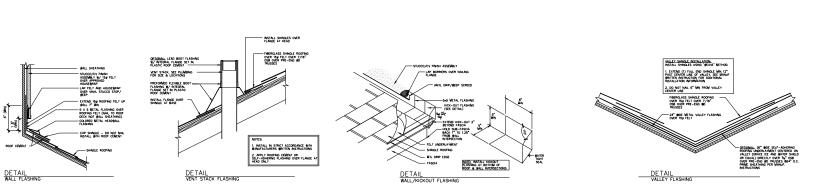

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			15of15
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