

MASONRY STEMWALLS: ALL CONCRETE MASONRY UNITS SHALL BE COMPOSED OF ASTM C90E, E GRADE N-1 HOLLOW CONCRETE MASONRY UNITS WITH TYPE 'S' MORTAR. WALL COURSING SHALL BE RUNNING BONDS, STACK BOND SHALL NOT BE USED. GROUT ALL CELLS CONTAINING VERTICAL REINFORCEMENT WITH 3000 PSI PEA ROCK CONCRETE GROUT. SPLICES IN REINFORCING, WHERE PERMITTED, SHALL BE 48 BAR DIAMETERS. ALL EXTERIOR WALLS SHALL BE REINFORCED FULL HEIGHT WITH - #4 @ 4'-0" O.C. MAX. AND AT EACH CORNER, WALL END, AND WALL INTERSECTIONS. PROVIDE CONTINUITY OF REINFORCING AT INTERSECTIONS OF PERPENDICULAR MASONRY ELEMENTS BY INSTALLING CORNER BARS, MINIMUM OF 40 BAR DIAMETERS INTO EACH ELEMENT. AT STEMWALL CONSTRUCTED OF 5 OR MORE COURSES, PROVIDE HORIZONTAL JOINT REINFORCEMENT AT 16" O.C. VERTICALLY, (EVERY OTHER COURSE), AND VERTICAL REINF. SHALL BE INCREASED AS NOTED ON

BRICK SHALL BE IN ACCORDANCE WITH ASTM C62, C216, OR C652 FOR BUILDING BRICK, FACING BRICK, & HOLLOW BRICK. RESPECTFULLY.

CONCRETE AT GARAGE AND PORCH SLABS SHALL HAVE A COMPRESSIVE STRENGTH OF 3000 PSI.

FOOTING AND FOUNDATIONS: FOOTINGS AND FOUNDATIONS SHALL BE IN ACCORDANCE WITH LOCAL BUILDING CODES. FOOTING HAVE BEEN DESIGNED WITH A SOIL BEARING (DESIGN MAXIMUM) OF 2000 PSF. A SOILS INVESTIGATION REPORT IS RECOMMENDED TO VERIFY SUITABLE SUBSURFACE CONDITIONS. IF THE FOOTING ELEVATIONS SHOWN OCCUR IN A DISTURBED OR UNSTABLE SOIL, THE ENGINEER SHALL BE NOTIFIED. SOIL SHALL BE FREE OF ORGANIC MATERIAL AND COHESIVE (CLAY) SOILS. SOIL COMPACTION AND FILL SHALL BE COMPACTED TO A MIN. OF 95% MODIFIED PROCTOR IN ACCORDANCE WITH ASTM D 1557.

FOUNDATION PLAN ONLY CONVEYS STRUCTURAL INFORMATION. FOR GENERAL FEATURES, CONDUITS, ELECTRICAL EMBEDS, STEP HEIGHTS, ETC., SEE ARCHITECTURAL PLANS. DO NOT SCALE FOOTING DIMENSIONS AND LOCATION FROM THE FOUNDATION PLAN SHOWN ON \$1.0. DO NOT DETERMINE FOOTING LOCATION BASED ON EITHER THE ARCHITECTURAL PLAN OR FRAMING PLAN, BUT BY DIMENSIONS PROVIDED ON FOUNDATION PLAN. IF FOOTING SIZE OR LOCATION IS NOT DETERMINED ON PLAN THEN CONTACT ENGINEER OF RECORD (EOR)

UNLESS OTHERWISE NOTED ON DRAWINGS, MINIMUM CONCRETE COVER FOR REINFORCING SHALL BE 3" IN FOOTINGS AND MESH SHALL BE CENTERED IN SLAB ON GRADE. IN ALL CONTINUOUS FOOTINGS PROVIDE #3 @ 48" O.C. OR ROD CHAIRS. PROVIDE CONTINUITY OF REINFORCING AT INTERSECTIONS OF PERPENDICULAR CONCRETE ELEMENTS BY INSTALLING CORNER BARS, MINIMUM OF 40 BAR DIAMETERS INTO EACH ELEMENT. SPLICES IN REINFORCING, WHERE PERMITTED. SHALL BE 48

CONCRETE SLABS ON GRADE: SHALL BE INSTALLED OVER MINIMUM 6 MIL POLYETHYLENE VAPOR RETARDER WITH JOINTS LAPPED 6" AND SEALED OVER CLEAN, COMPACTED EARTH OR FILL WITH APPROVED CHEMICAL SOIL TREATMENT FOR PREVENTION OF SUBTERRANEAN

SAWCUTS: FOR CONTROLLED CRACKING CUT A 1" SAWCUT INTO SLAB IN A 12'x12' GRID WITHIN 12 HOURS OF CONCRETE PLACEMENT, PROVIDE SAWCUTS THROUGH OUT SLAB CALL EOR FOR ALTERNATIVE METHODS.


ALL WOOD FRAMING HAS BEEN DESIGNED IN ACCORDANCE WITH NATIONAL DESIGN SPECIFICATIONS (NDS) FOR WOOD CONSTRUCTION, LATEST EDITION. ALL WOOD MEMBERS EXPOSED TO WEATHER OR IN CONTACT WITH MASONRY, CONCRETE OR SOIL SHALL BE PRESSURE—TREATED. IF, ACQ OR NON—DOT BORATE PRESERVATIVE TREATMENT IS USED, ALL ATTACHED FASTENERS SHALL BE HOT DIPPED GALVANIZED. IF ACZA PRESERVATIVE IS USED, ALL ATTACHED FASTENERS SHALL BE STAINLESS STEEL

PRE-ENGINEERED WOOD TRUSSES: SHALL BEAR THE SEAL OF AN ENGINEER IN THE STATE WHERE PROJECT IS BEING BUILT AND SHALL COMPLY WITH NFPA, TPI, AND AITC 100. CONTRACTOR SHALL VERIFY THAT ADEQUATE TRUSS BEARING IS INSTALLED AT ALL TRUSSES AS INDICATED IN THE TRUSS SHOP DRAWINGS. ALL TRUSS-TO-TRUSS CONNECTIONS AND TRUSS PROFILES ARE THE RESPONSIBILITY OF THE DELEGATED TRUSS ENGINEER. ALL TRUSSES SHALL HAVE TEMPORARY BRACING PER 'COMMENTARY' AND RECOMMENDATION FOR HANDLING, INSTALLING & BRACING METAL PLATE CONNECTED WOOD TRUSSES, HIB-91." AT MULTIPLE STRAP CONNECTIONS, SPREAD STRAPS TO AVOID NAILING CONFLICTS THROUGH TRUSS. WHEN USING (2) STRAPS ON SINGLE PLY TRUSSES, PLACE STRAPS DIAGONALLY ACROSS DBL. TOP PLATE FROM EA. OTHER.

THE CONTRACTOR SHALL BE RESPONSIBLE FOR THE DESIGN AND INSTALLATION OF THE ROOF COVERING SYSTEM. ASPHALT SHINGS SHALL COMPLY WITH ASTM D3161 AND BE INSTALLED ACCORDING TO THE MANUFACTURER'S REQUIREMENTS. CLAY AND TILE ROOFS SHALL BE INSTALLED PER THE "CONCRETE AND CLAY ROOF TILE INSTALLATION MANUAL." AND THE MANUFACTURER'S REQUIREMENTS. STANDING SEAM METAL ROOFS SHALL COMPLY WITH ASTM E1514 AND BE INSTALLED ACCORDING TO THE MANUFACTURER'S REQUIREMENTS. THE CONTRACTOR SHALL BE RESPONSIBLE FOR THE DESIGN AND INSTALLATION OF ALL METAL FLASHING AND VALLEY MATERIALS.

THE CONTRACTOR SHALL BE RESPONSIBLE FOR THE DESIGN/INSTALLATION OF ALL WATER PROOFING.

WOOD FASTENING SCHEDULE			BRICK NOTES / LINTEL SCHD		PLAN LEGEND AND ABBREVIATIONS		
MEMBERS	CONNECTION TYPE	FASTENER	LINTEL DIMENSION	MIN. BRG.	MAX. SPAN	INTERIOR LOAD BEARING WALL	BUILT-UP POST IN THE WALL
TOP PLATE TO TOP PLATE	FACE NAIL	2-GUN NAILS @ 12" STAG.	L3½x3½x1/4	4"	6'-0"	GABLE X-BRACE, SEE DETAIL 11/S0	
TOP PLATE, LAPS/INTERSECTION	FACE NAIL	(2-16d) 3-GUN NAILS	L4x3 ¹ / ₂ "x ¹ / ₄	6"	8'-0"		(2)2x6-1/2 HEADER SIZE, JACK AND KING STUD QUANTITY.
DBL. TOP PLATE TO STUD	FACE NAIL	(2-16d) 3-GUN NAILS	L5x3 ¹ / ₂ "x ¹ / ₄	6"	10'-0"	DESIGNATES SHEARWALL. THE HIDDEN LINE DESIGNATES SIDE OF	QUANTITY.
RIM JOIST TO TOP PLATE	TOE NAIL	(8d @ 6") GUN NAIL @ 6"	L6x3 ¹ / ₂ "x ¹ / ₄	6"	12'-0"	SW WALL THE SHEARWALL SHEATHING NAMED TO BE APPLIED. 8d @ 3/6	
CEILING JOIST TO TOP PLATE	TOE NAIL	(3-8d) 5-GUN NAILS	L7×3 ¹ / ₂ "x ¹ / ₄	6"	16'-0"	NAILING: DESIGNATES 8d COMMONS @ 3" DESIGNATES 8d COMMONS @ 3" O.C. EDGE & 6" O.C. "IN THE	
CEILING JOIST, OVER PARTITIONS	FACE NAIL	(3-16d) 4-GUN NAILS	1. STEEL LINTELS TO BE MINIMAL 36'		10 0	FIELD"	
CEILING JOIST TO ROOF RAFTER	FACE NAIL	(6-16d) 8-GUN NAILS	LINTEL MUST HAVE CORROSION		BRICK	ADJ — ADJACENT	LG - Long
JOIST/TRUSS TO PLATE	TOE NAIL	(2-16d) 3-GUN NAILS	RESISTANT COATING OF EPOXY BASE	P	VENEER	BM — BEAM	MANUF - Manufacture
RAFTER TO PLATE	TOE NAIL	(3-8d) 3-GUN NAILS			WEATHER BARRIER	BOT — BOTTOM BRG — BEARING	MONO — Monolithic OC — On Center
JACK RAFTER TO HIP	TOE NAIL	(3-10d) 4-GUN NAILS	2. LINTEL MORE THAN 8'-0". SHOULI BE LATERALLY SUPPORTED NOT TO)		CMU - CONCRETE MASONRY UNIT	OSB — Oriented Strand Board
ROOF RAFTER TO 2x_ RIDGE BM.	TOE NAIL	(2-16d) 3-GUN NAILS	EXCEED 6 FT. O.C. $w/2-\frac{1}{4}\times3$ " WD.		M	DBL — DOUBLE DIA — DIAMETER	PERP — Perpendicular PRE ENG — Pre Engineered
CONT. HEADER, TWO PIECES	FACE NAIL	16d@ 16" O.C. @ EDGE	SCREWS INTO HEADER PROVIDE A 1/2 VERTICAL SLOTTED HOLE FOR SCREW		LINTEL ATTACHMENT	. EA — EACH EE — EACH END	PSF — Pounds per Square Foot PSI — Pounds per Square Inch
CONT. HEADER TO STUD	TOE NAIL	(3-16d) 4-GUN NAILS		. \	SEE NOTE 2	EOR — ENGINEER OF RECORD	PT – PRESSURE TREATED
STUD TO SOLE PLATE	TOE NAIL	(3-16d) 4-GUN NAILS	3. BRICK VENEER ATTACHMENT: HORIZONTAL TIES @ 24" O.C., VERT.	1-11	<u></u> ; ♠ ♠ ♠ ♠	EQ — EQUAL EXT — EXTERIOR	QT — Quick Tie REINF — Reinforce
SOLE PLATE TO JOIST/BLOCKING	FACE NAIL	(16d @ 16") GUN NAIL @ 8"	TIES @ 12" O.C (FOR 110mph	HEADER,_	FLASHING	FBC — FLORIDA BUILDING CODE FDN — FOUNDATION	SF — Square Foot SPF —Spruce Pine Fur
NAIL SP $3"x0.131" \emptyset = GUN NAILS$ $2"x0.113" \emptyset = 6d$ $3"x0.148" \emptyset = 10d$ $1^{1}/_{2}"x0.148" \emptyset = 10dx1^{1}/_{2}"$	2½"> 3½">	113"ø = RINK SHANK 0.131"Ø = 8d 0.162"Ø = 16d 0.131 "Ø = 8dx1 $\frac{1}{2}$ "	WIND-ZONE VERT. TIES @ 16" O.C.). AT ALL OPENINGS SPACE TIES WITHIN 12" OF OPENINGS. PROVIDE \$\frac{3}{16}\text{"}\noting \text{WEI} HOLES @ 33" O.C. IMMEDIATELY ABO' FLASHING.	EP VE <u>S</u> E	BRICK LINTEL, SEE SCHEDULE CTION VIEW BRICK LINTEL	FDN — FOUNDATION FT — FOOT FTG — FOOTING HDR — HEADER HORIZ — HORIZONTAL LBS — POUNDS	SPF —Spruce Pine Fur SYP — Southern Yellow Pine THRU — Through TYP — Typical UON — Unless Otherwise Noted VERT — Vertical WWF — Welded Wire Fabric

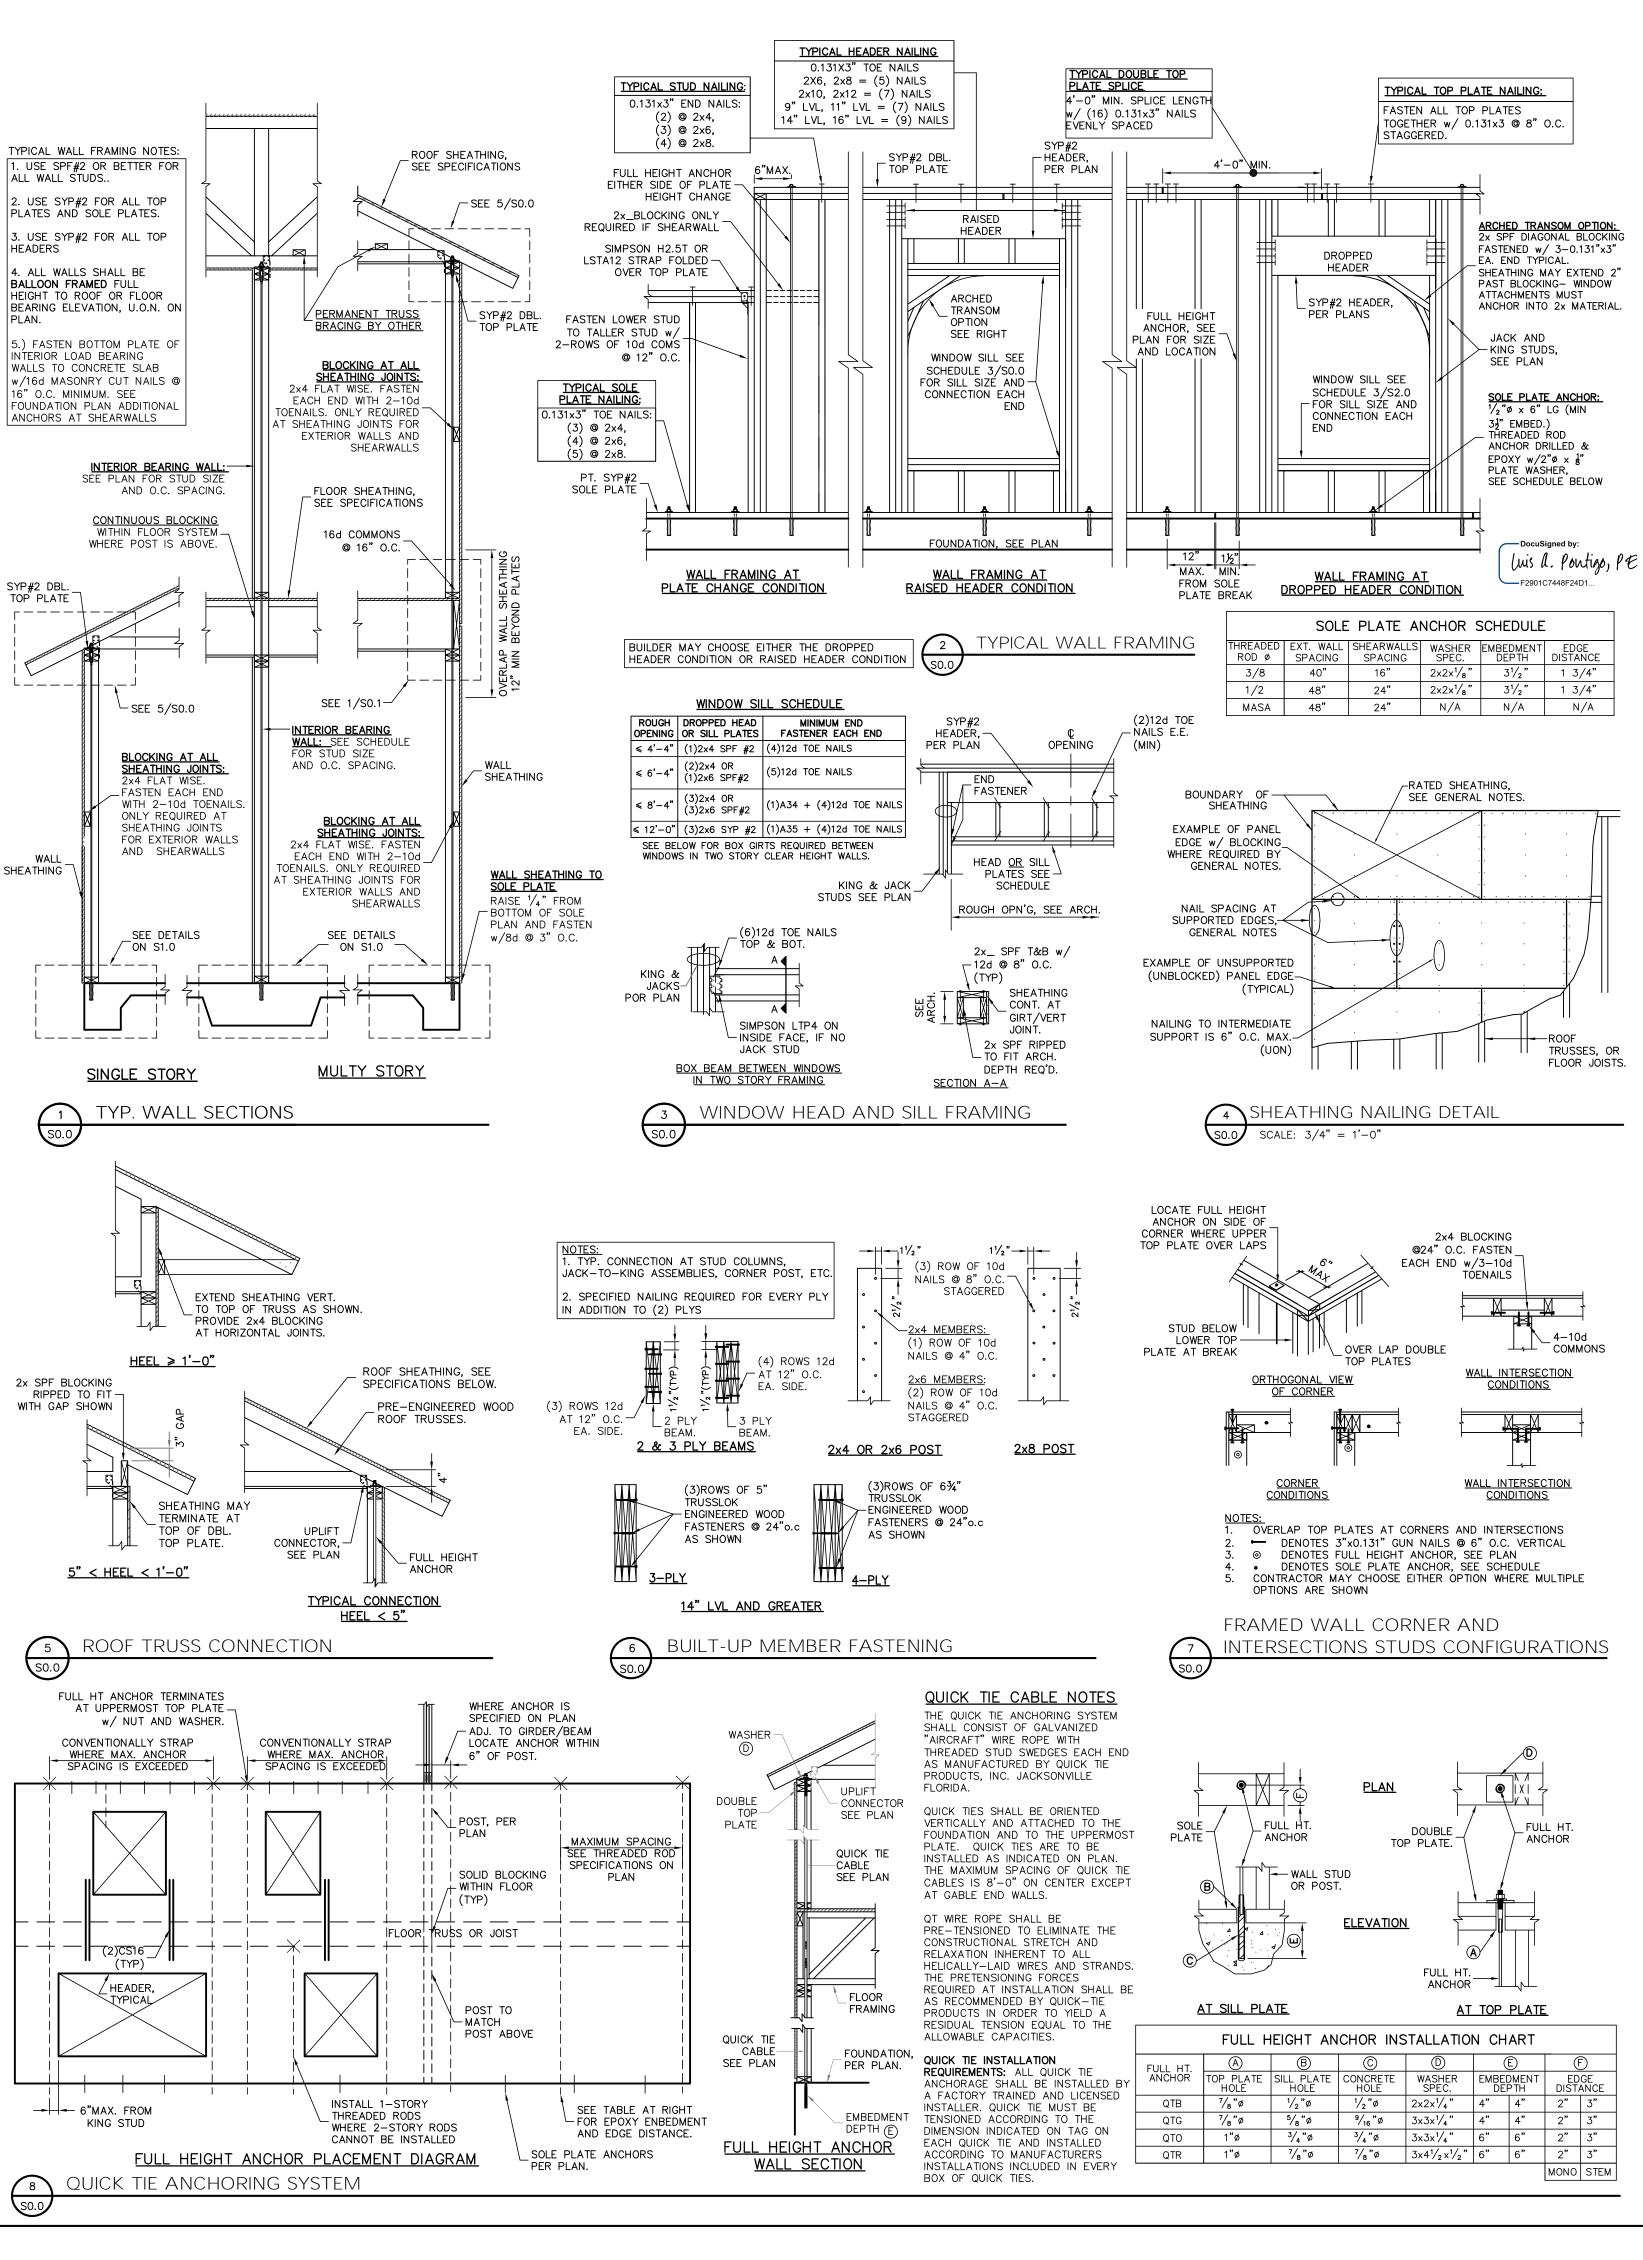

Lou Pontigo and

420 Osceola Avenue

Jax. Beach, Florida 32250

Ph. 242-0908 Fax. 241-9557

FL: CA # 8344 SC: CA# 3579

CENSA

Luis A. Pontigo, PE

FL PE#53311

FIFI D AI TERATION

ONTIGO & ASSOCIATES PRIOR TO

MODIFICATIONS WHICH MAY VAR

ROM THE INTENT OF THE ORIGIN.

EING APPROVED BY LOU PONTIG

ADDITIONAL ENGINEERING OF INSPECTION FEES

~

DESIGN

AND

GENERAL

NOT SCALE DIMENSIONS FRO

UNCLEAR REFER TO THE

CONTACT THE E.O.R.

PLAN NAME

SPEC HOME

DESIGN/DRAWN/CHECKED

CS / KM / LAP

01.10.17

SCALE

AS NOTED

LPA No.

DRBD-16-01052

CONTROL No.

5774

SHEET


SHEET 1 OF 9


 \Box


INSTRUCTION DOCUMENTS, AN


REVISIONS

Associates, Inc

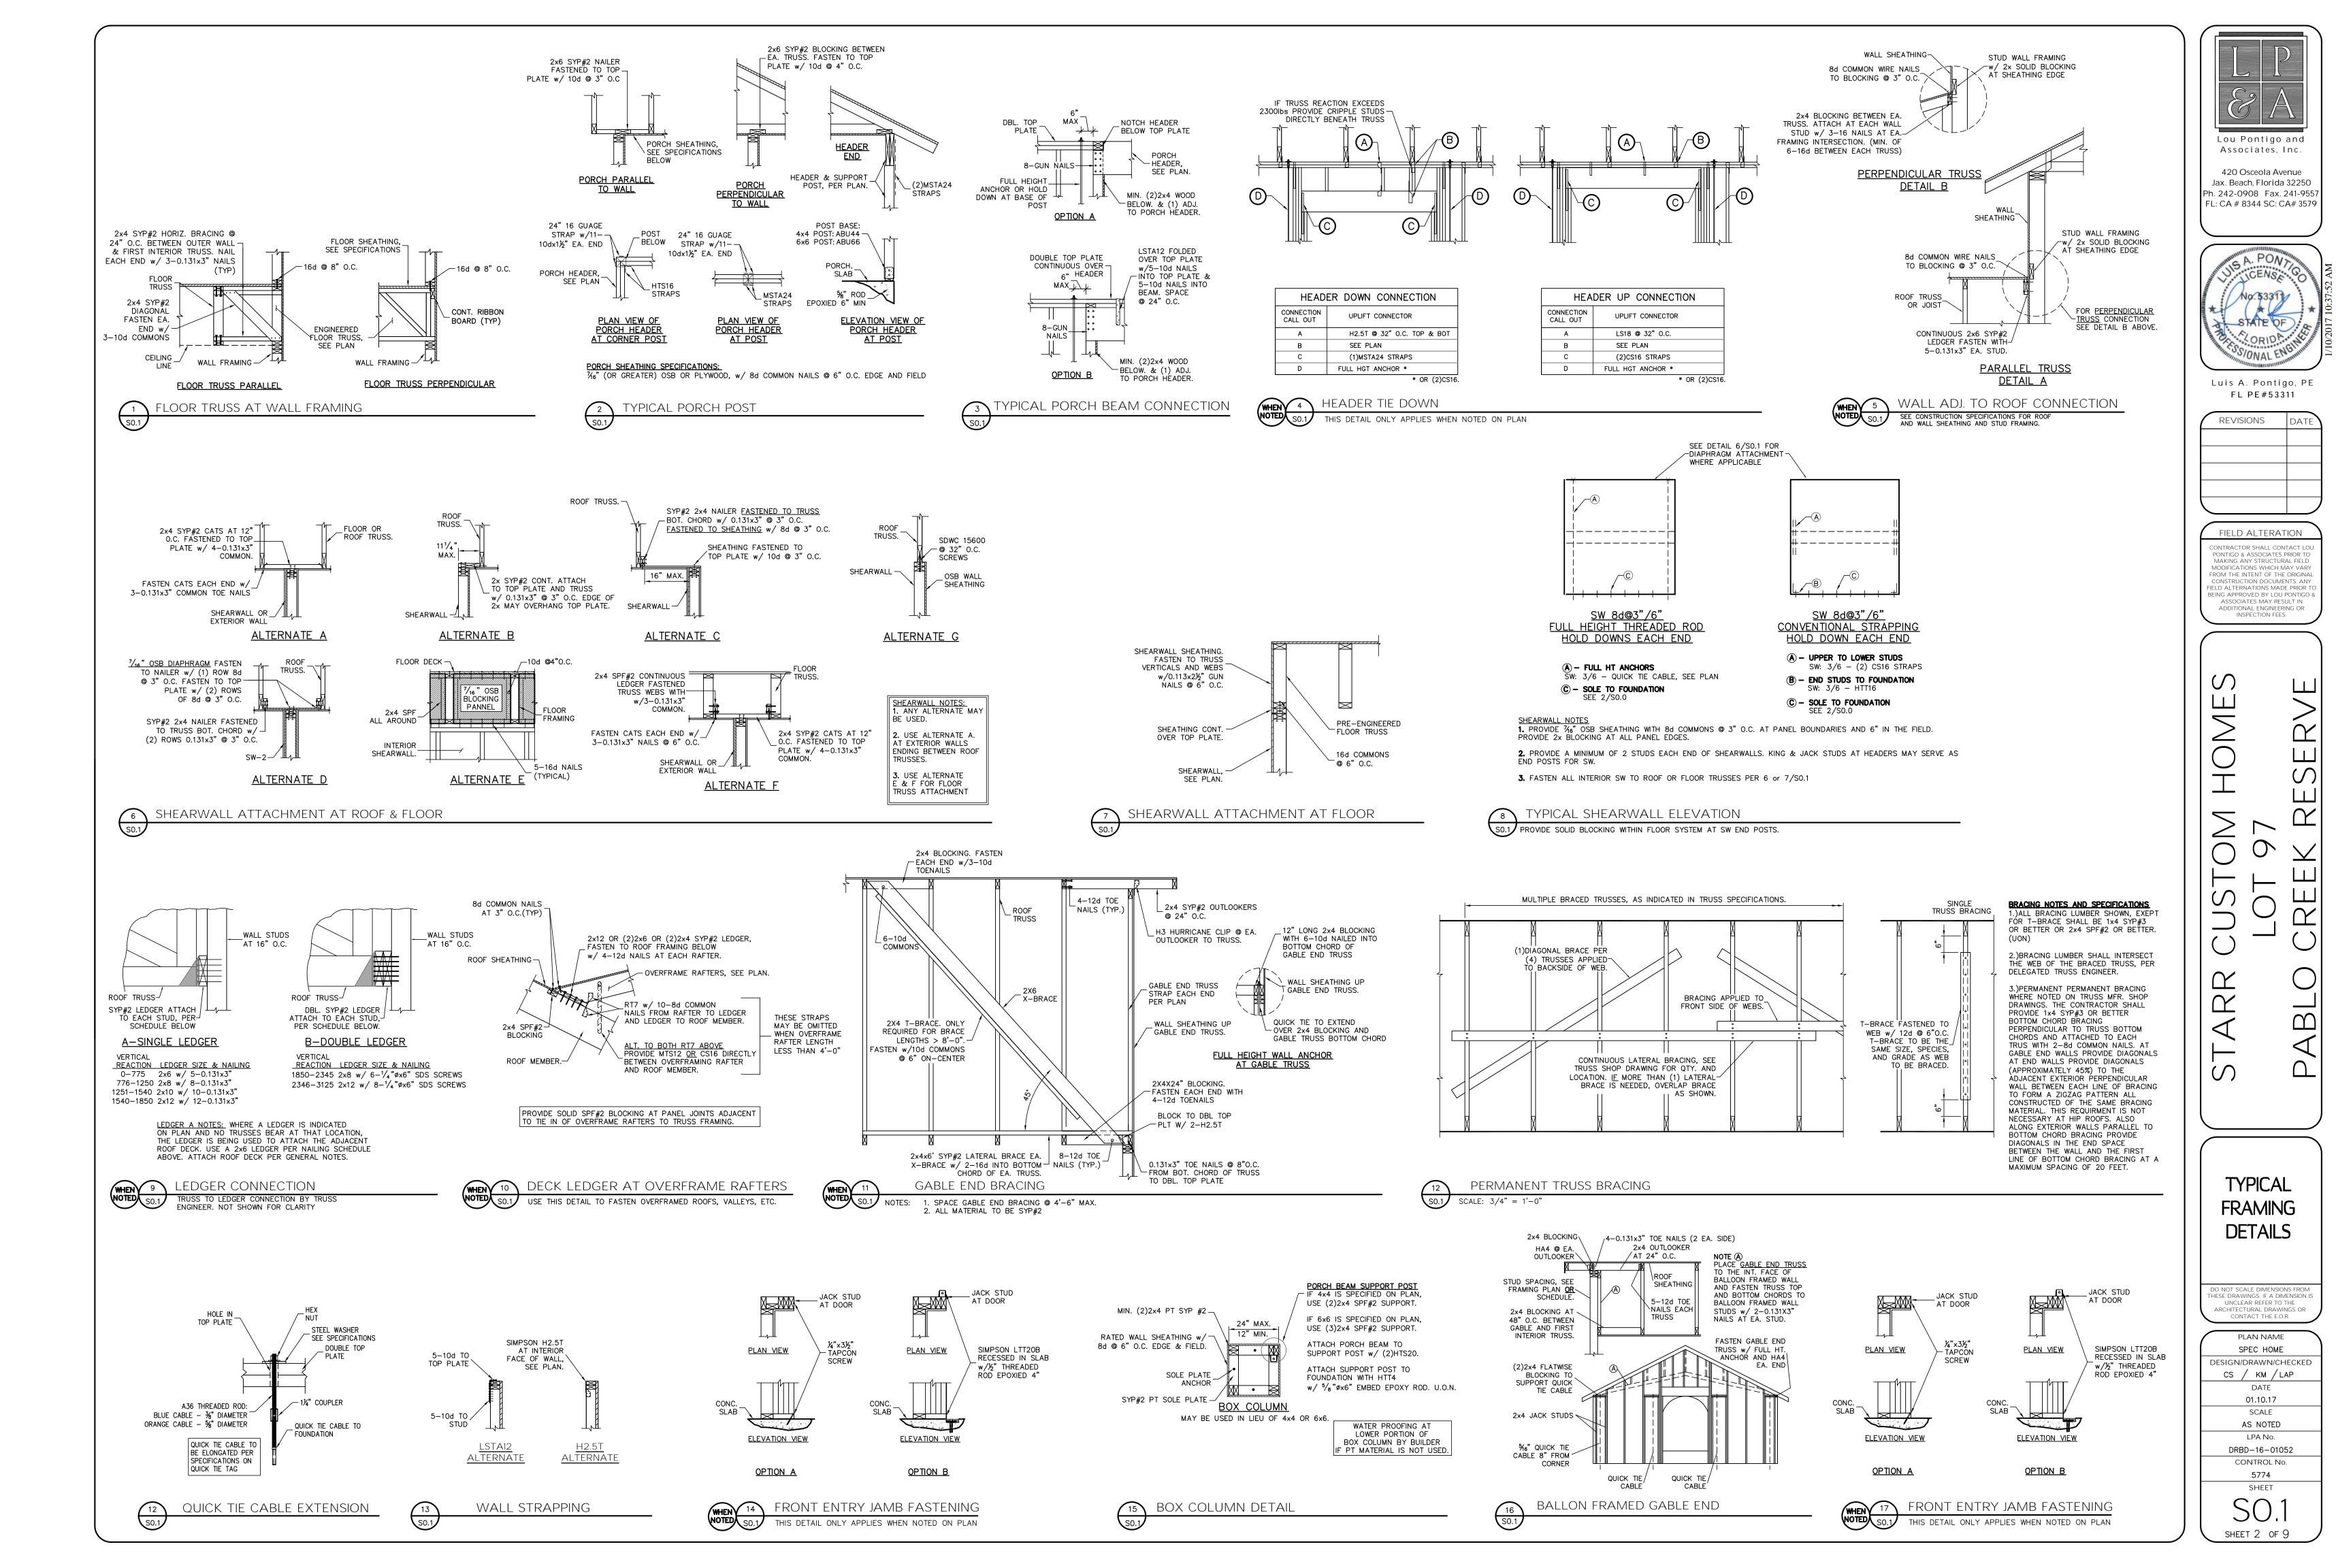

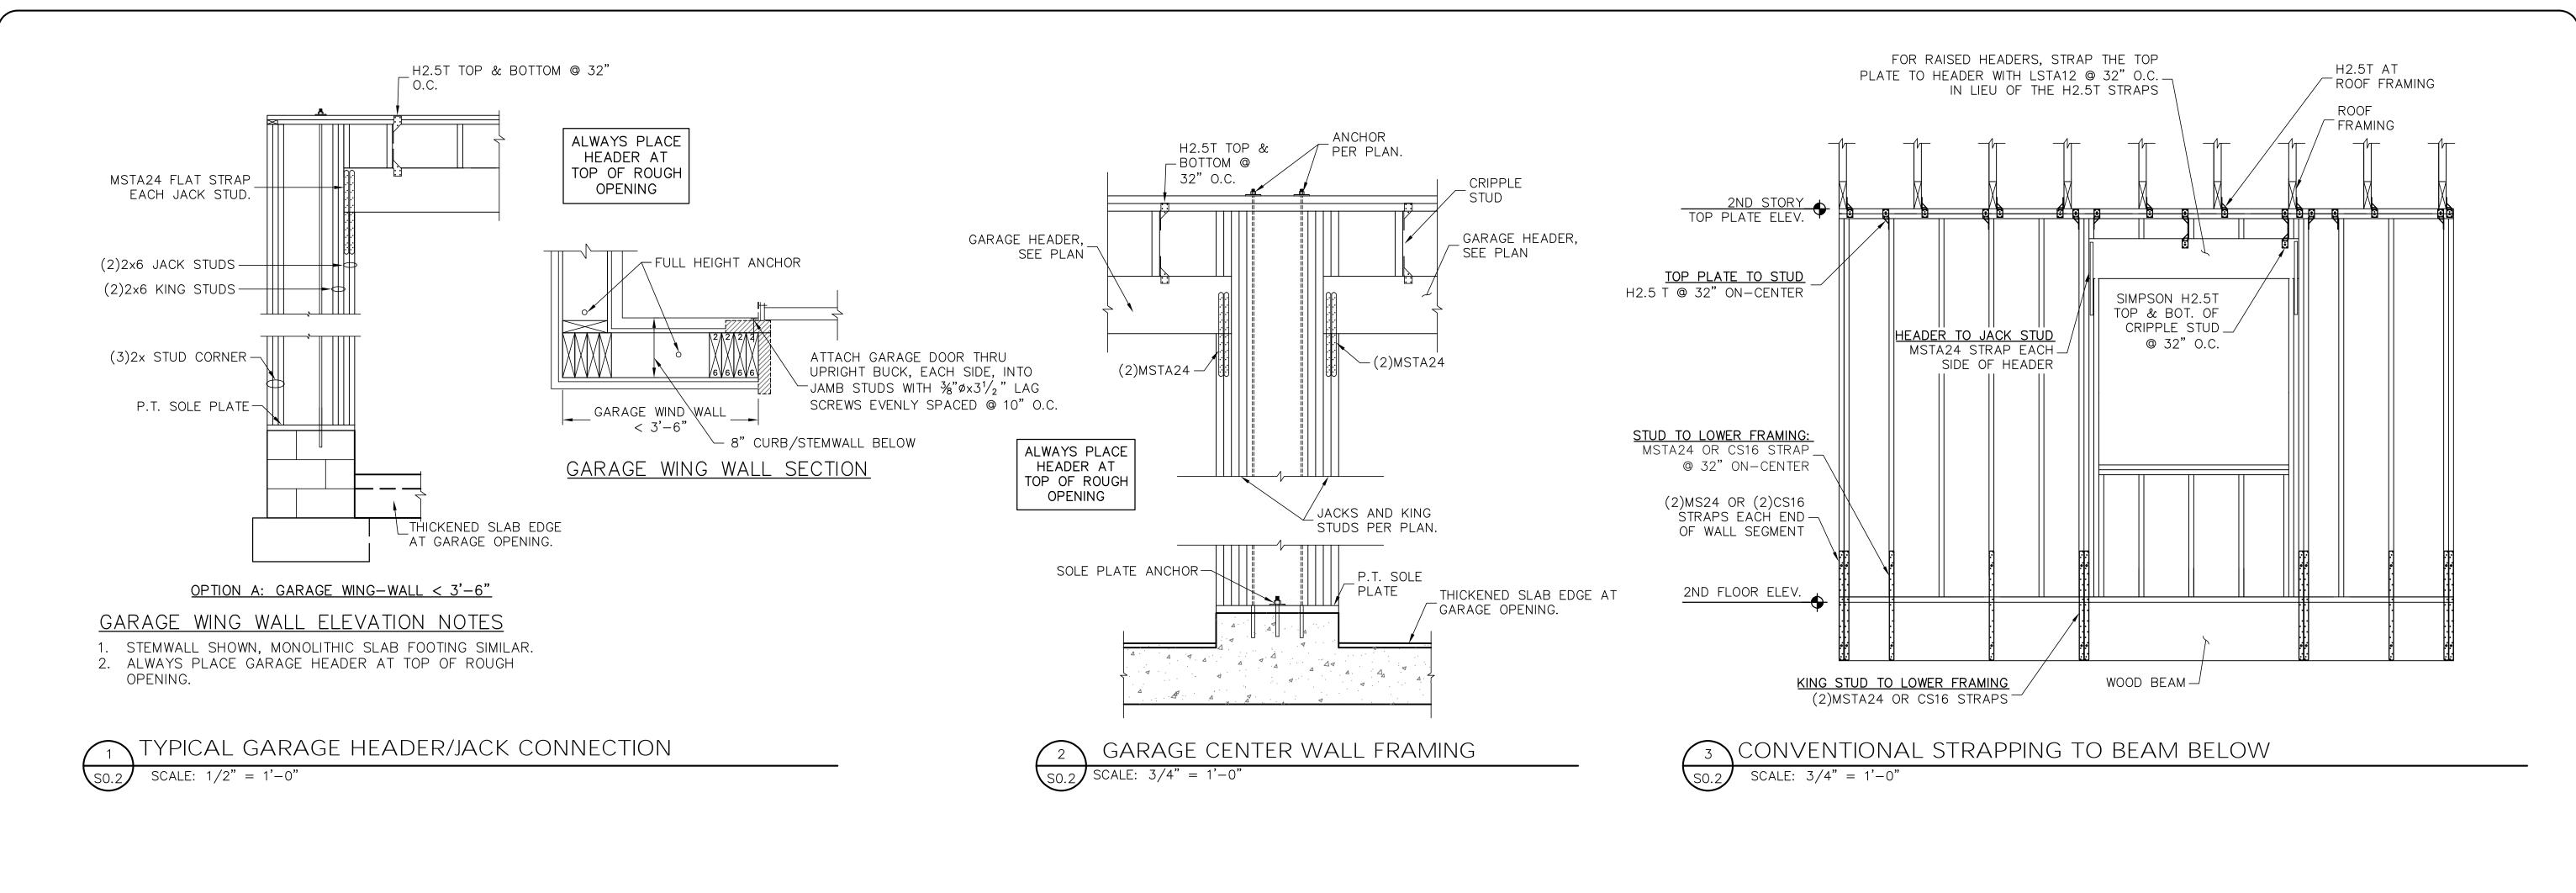


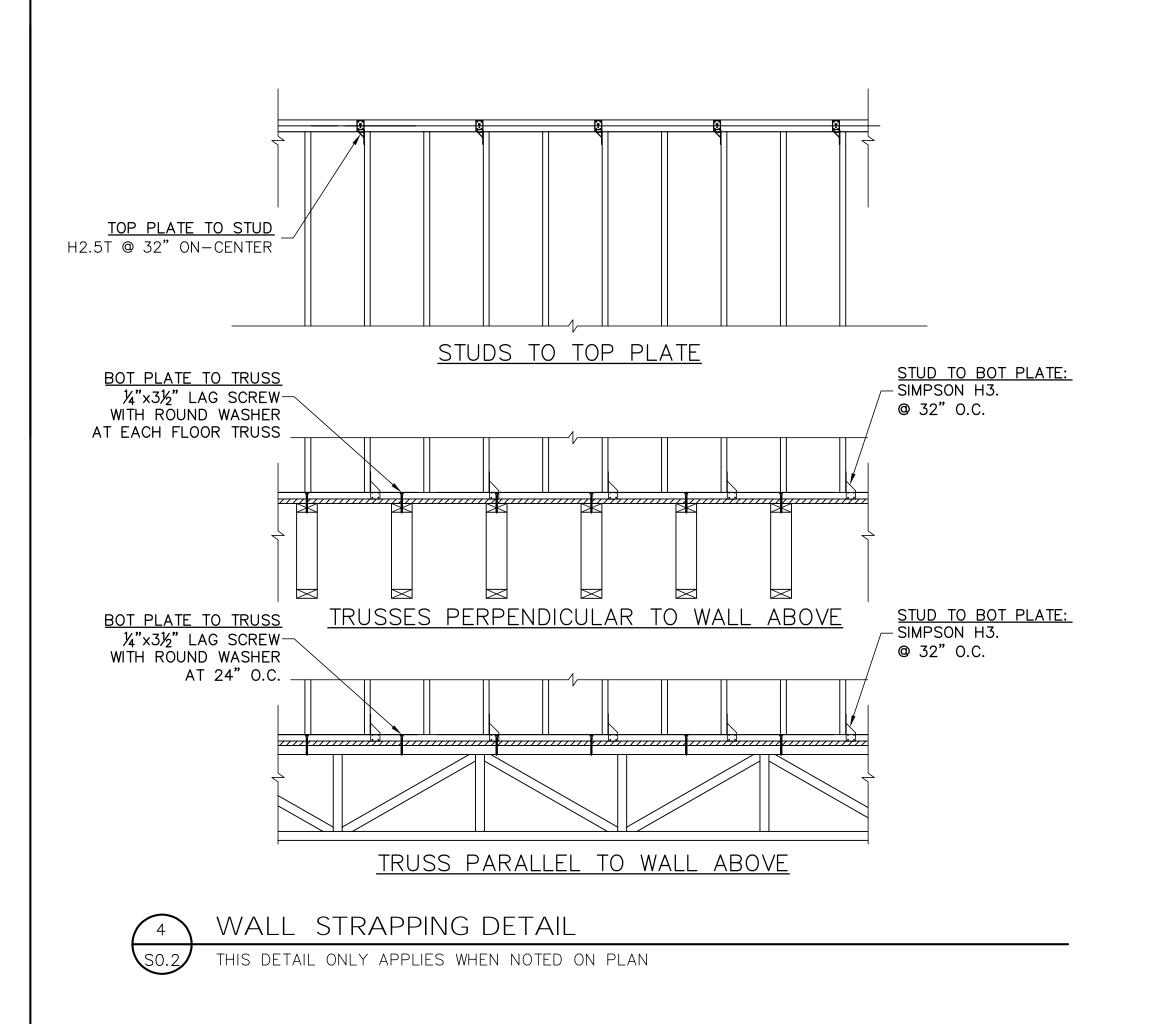

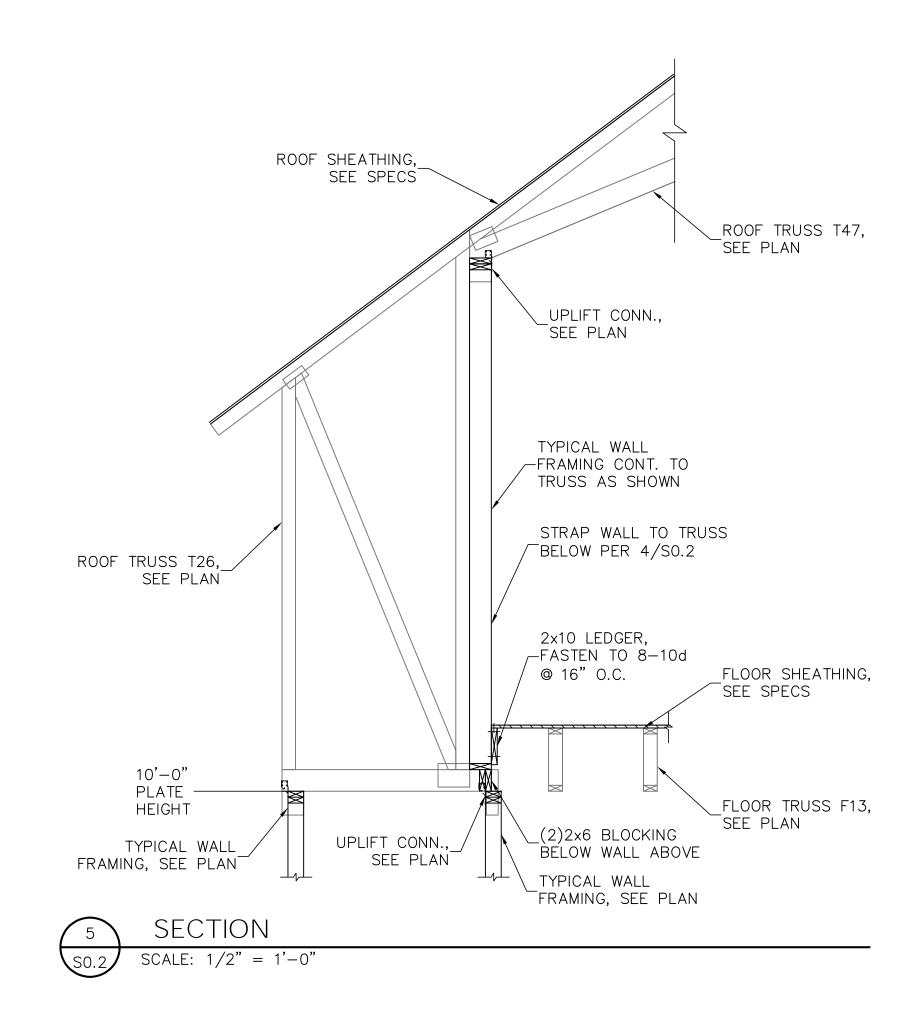


Lou Pontigo and Associates, Inc.

420 Osceola Avenue Jax. Beach, Florida 32250 Ph. 242-0908 Fax. 241-9557 FL: CA # 8344 SC: CA# 3579

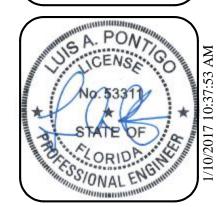

Luis A. Pontigo, PE FL PE#53311

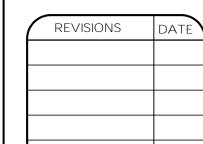

FIELD ALTERATION

CONTRACTOR SHALL CONTACT LOU PONTIGO & ASSOCIATES PRIOR TO MAKING ANY STRUCTURAL FIELD MODIFICATIONS WHICH MAY VARY FROM THE INTENT OF THE ORIGINAL CONSTRUCTION DOCUMENTS. ANY FIELD ALTERNATIONS MADE PRIOR TO BEING APPROVED BY LOU PONTIGO & ASSOCIATES MAY RESULT IN ADDITIONAL ENGINEERING OR INSPECTION FEES.

STARK CUSTOM HOMES
LOT 97
PABLO CREEK RESERVE

TYPICAL FRAMING DETAILS

DO NOT SCALE DIMENSIONS FROM THESE DRAWINGS. IF A DIMENSION UNCLEAR REFER TO THE ARCHITECTURAL DRAWINGS OR CONTACT THE E.O.R.

PLAN NAME
SPEC HOME

DESIGN/DRAWN/CHECKED
CS / KM / LAP

DATE
01.10.17

SCALE
AS NOTED


LPA NO.

DRBD-16-01052

CONTROL NO.
5774

SHEET

SHEET 3 OF 9

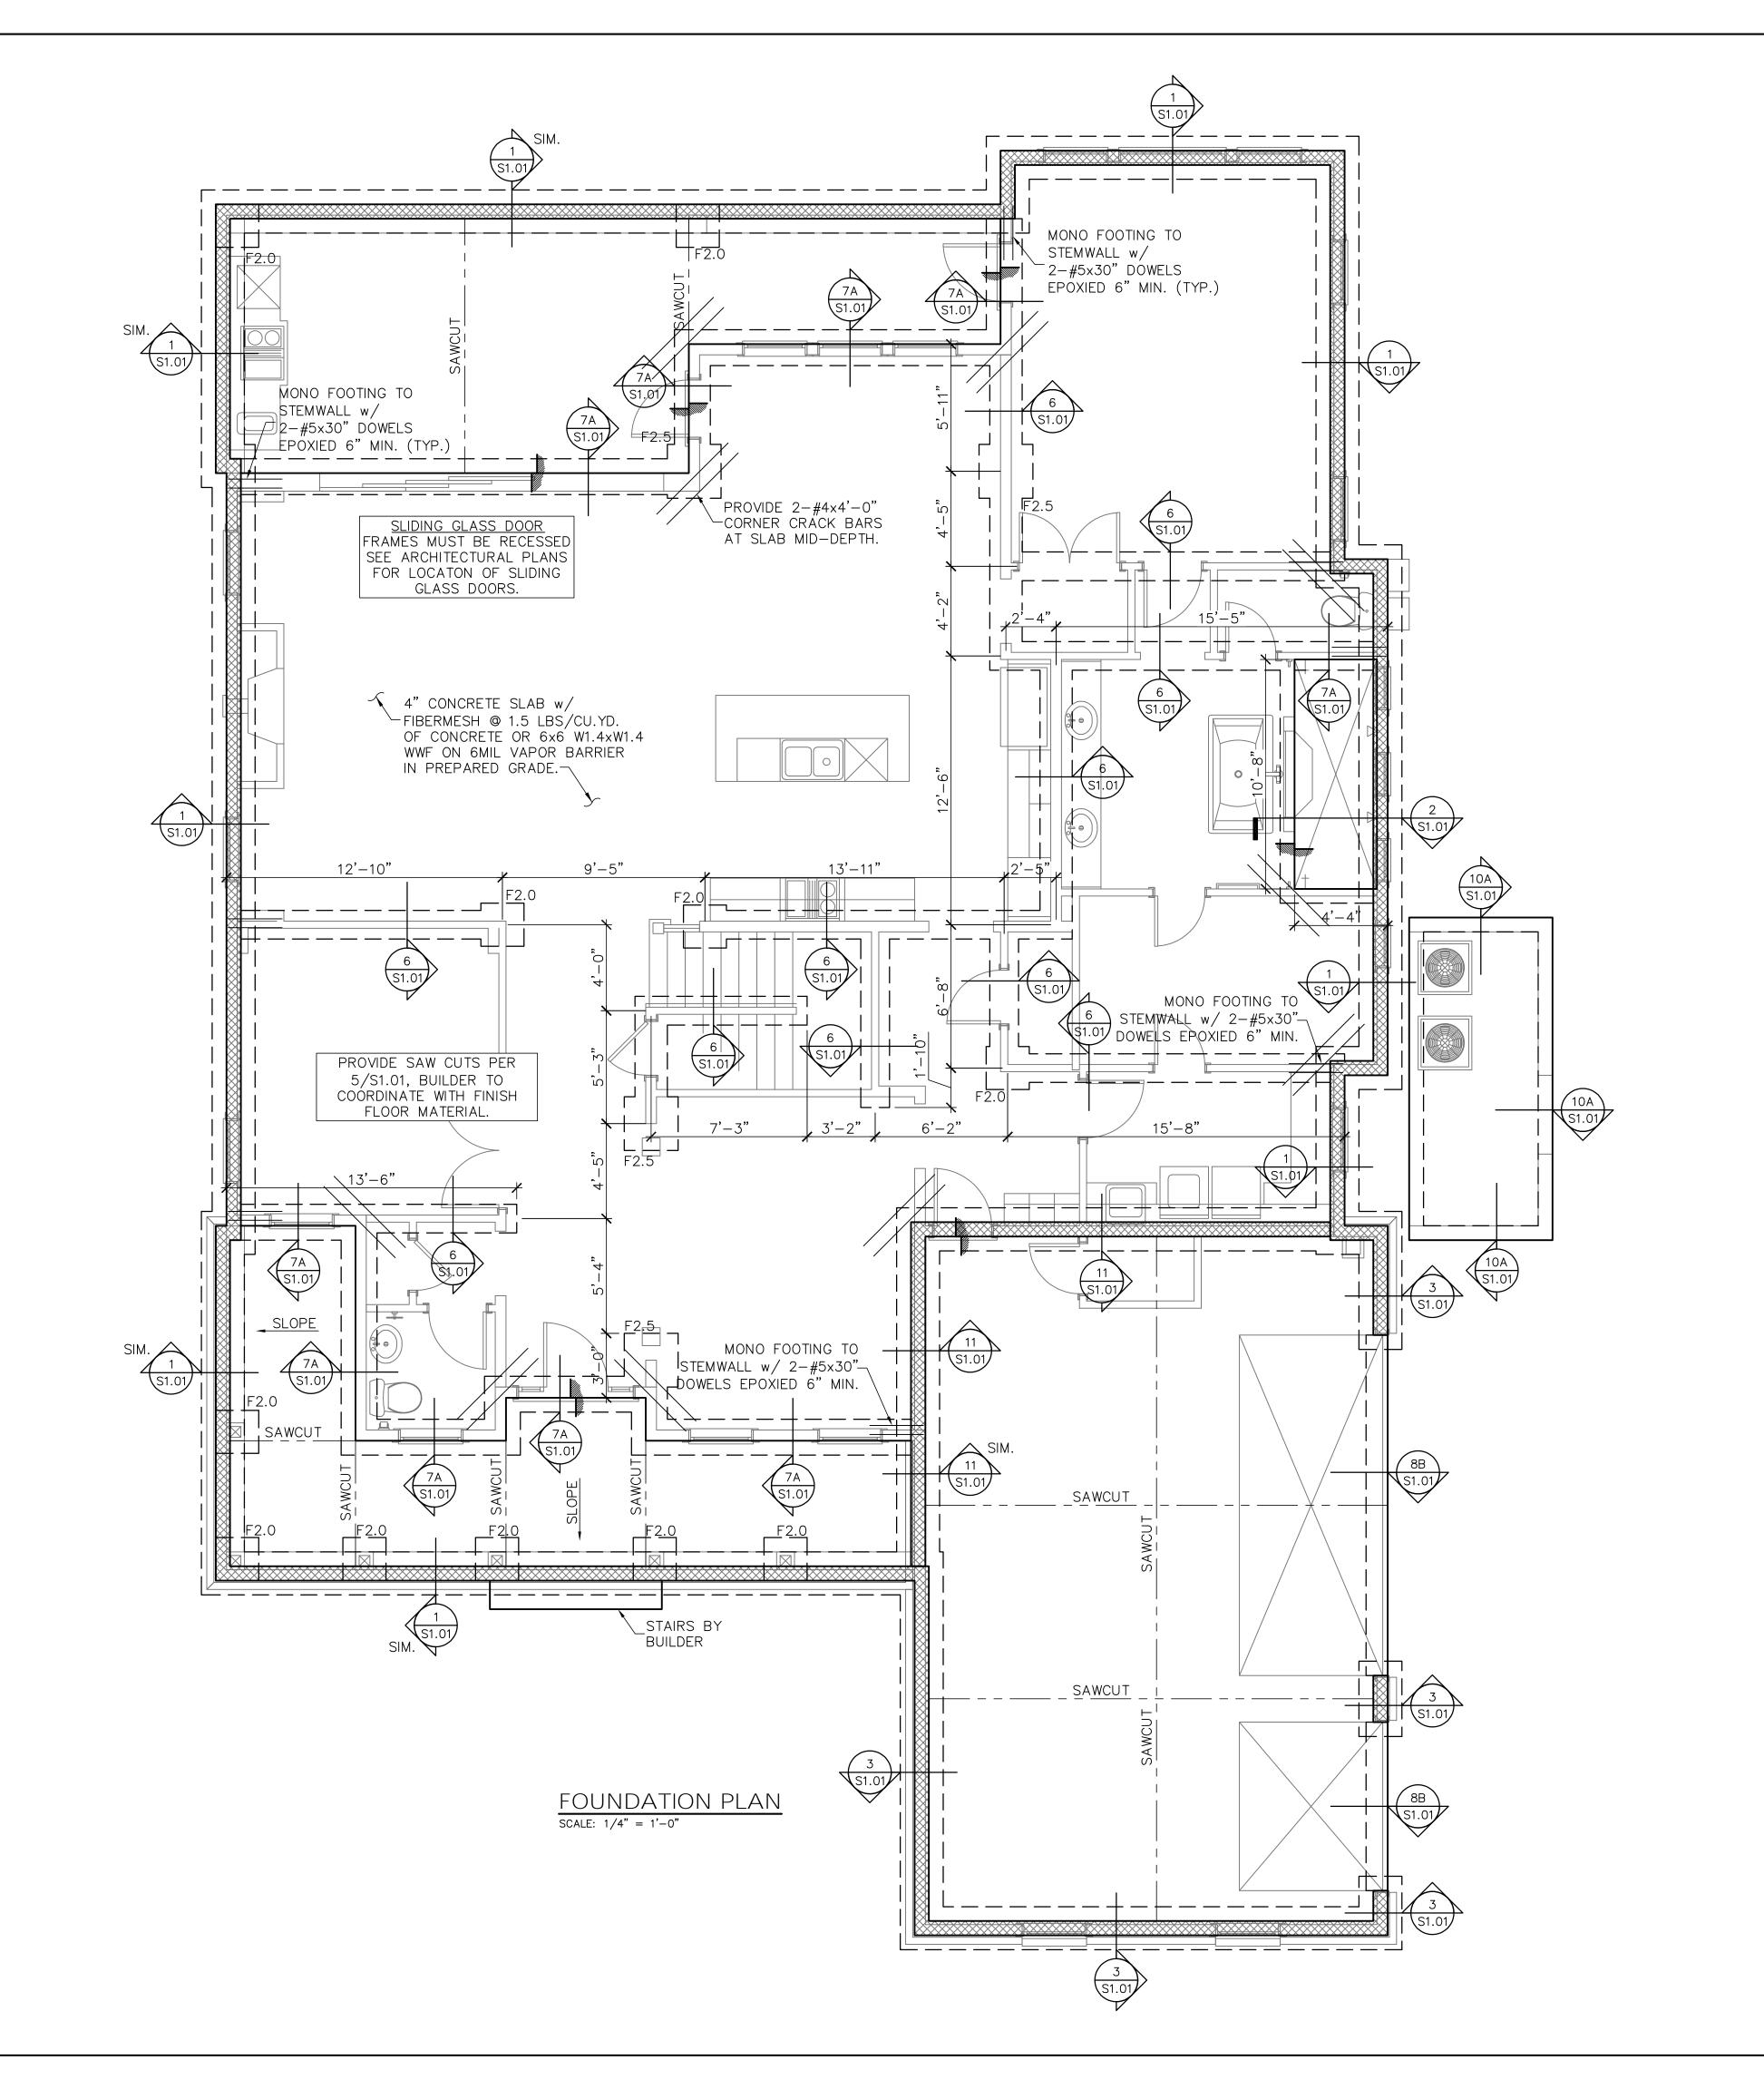

———— DESIGNATES FOOTING LINE

DESIGNATES SAWCUT LINE DESIGNATES SLAB RECESS

Lou Pontigo and Associates, Inc.

420 Osceola Avenue Jax. Beach, Florida 32250 Ph. 242-0908 Fax. 241-9557 FL: CA # 8344 SC: CA# 3579



Luis A. Pontigo, PE FL PE#53311

REVISIONS

FIELD ALTERATION

PONTIGO & ASSOCIATES PRIOR TO
MAKING ANY STRUCTURAL FIELD
MODIFICATIONS WHICH MAY VARY
FROM THE INTENT OF THE ORIGINAL
CONSTRUCTION DOCUMENTS. ANY
FIELD ALTERNATIONS MADE PRIOR TO
BEING APPROVED BY LOU PONTIGO & ASSOCIATES MAY RESULT IN ADDITIONAL ENGINEERING OR INSPECTION FEES.

FOUNDATION PLAN

> UNCLEAR REFER TO THE ARCHITECTURAL DRAWINGS OF CONTACT THE E.O.R.

SPEC HOME DESIGN/DRAWN/CHECKED CS / KM /LAP 01.10.17 SCALE AS NOTED DRBD-16-01052

CONTROL No. 5774

SHEET

STEP HEIGHTS, ECT., SEE ARCH. PLAN. ARCHITECTURAL PLAN SHOWN HERE IN FOR REFERENCE ONLY 2. FTGS. & FND. SHALL BE IN ACCORDANCE w/ LOCAL BUILDING CODES. 3. SOIL COMPACTION AND FILL SHALL BE COMPACTED TO A MIN. OF 95% MODIFIED PROCTOR IN ACCORDANCE WITH ASTM D 1557

FOOTING SCHEDULE AND NOTES

2'-0" 1'-0"

2'-6" 1'-0"

3'-0" 1'-0"

3'-6" 1'-0"

4'-0" | 1'-0" |

1. THIS FOUNDATION PLAN ONLY CONVEYS STRUCTURAL INFO. RELATED TO THE FOUNDATION. FOR GENERAL FEATURES, DIMENSIONS, CONDUITS, ELECTRICAL EMBEDS,

4'-6" | 1'-0" | 4-#5 EA. WAY BOT.

TYPE LENGTH

F4.5 4'-6"

F3.0

F4.0

2'-6"

3'-0"

3'-6"

4'-0"

BOTTOM BARS


3-#5 EA. WAY BOT.


3-#5 EA. WAY BOT.


3-#5 EA. WAY BOT.

4-#5 EA. WAY BOT.


4-#5 EA. WAY BOT.

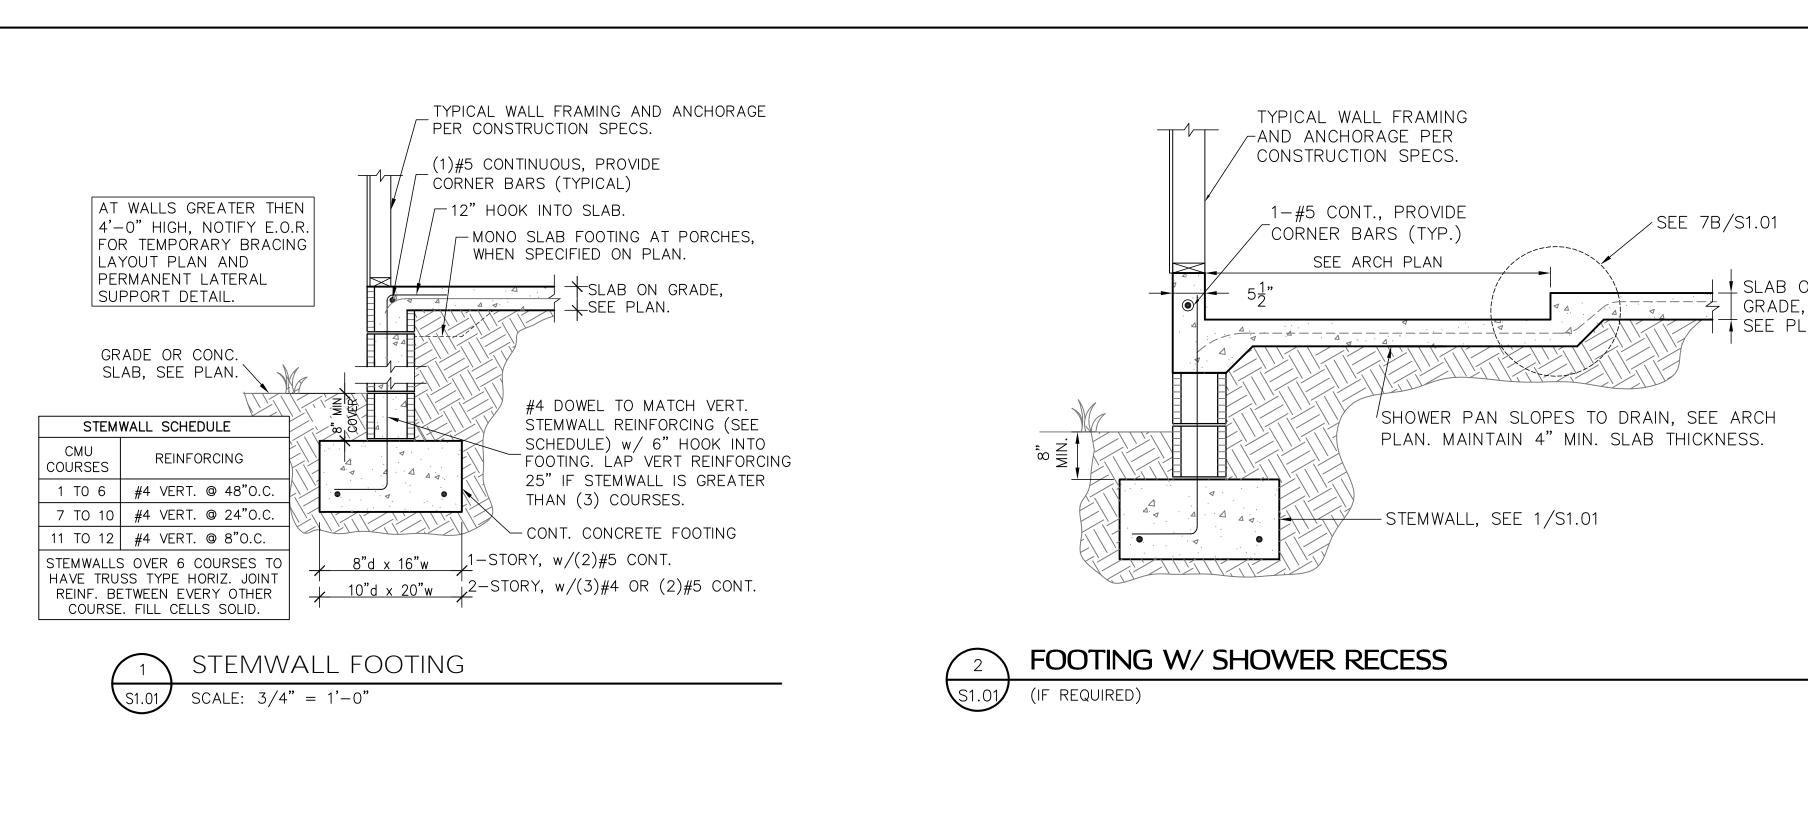


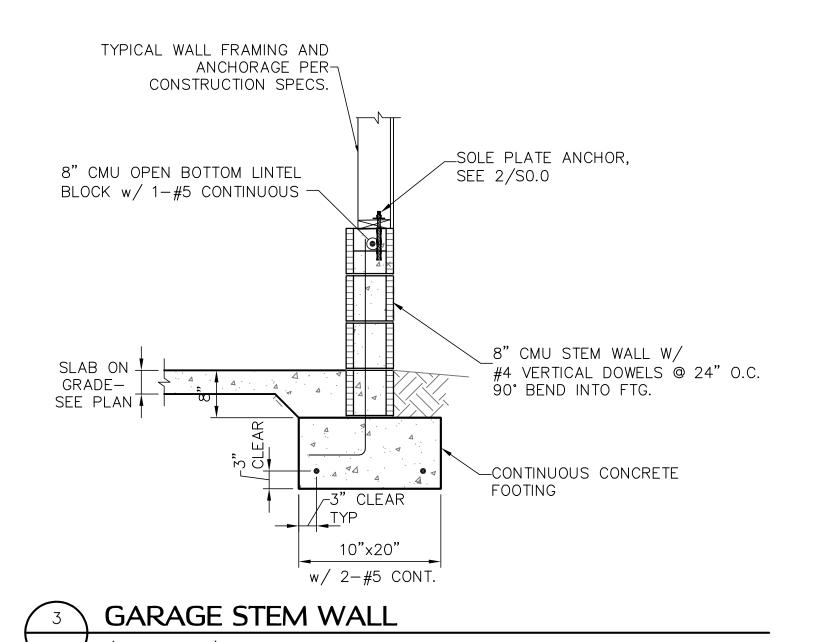


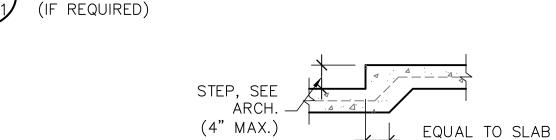




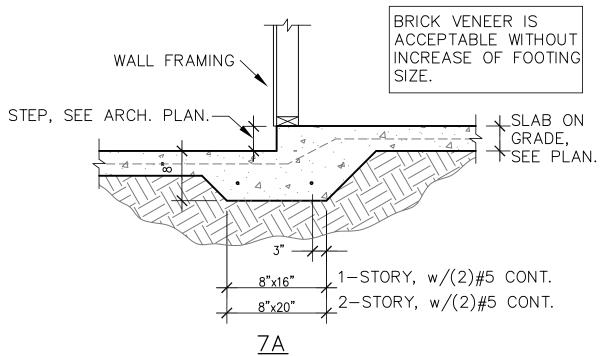

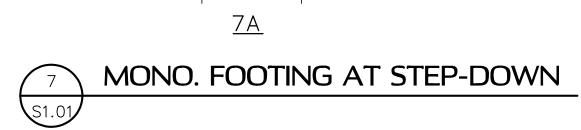


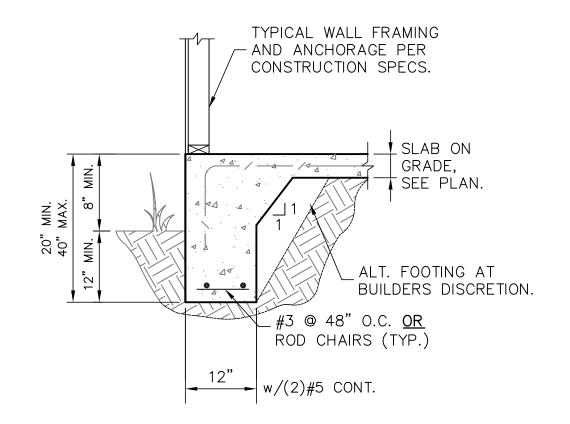



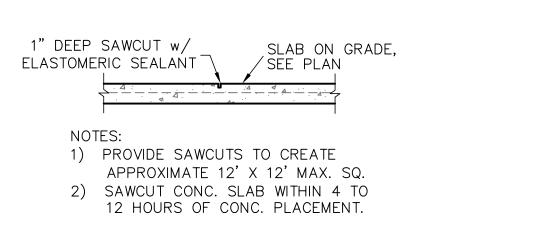




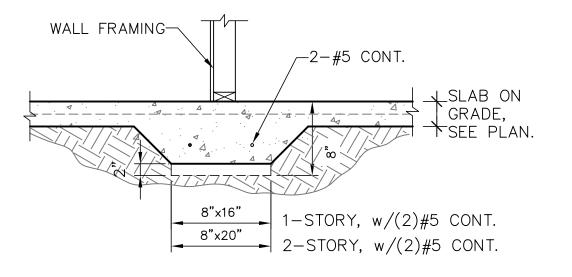


____SLAB ON


TSEE PLAN.



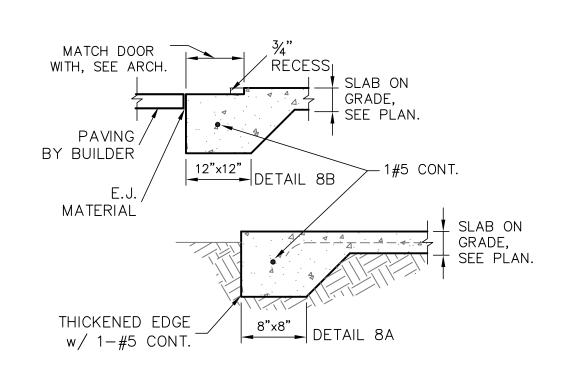




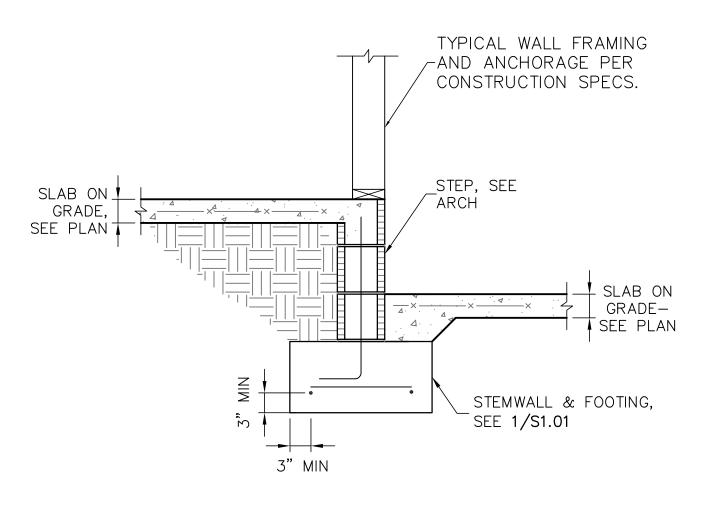

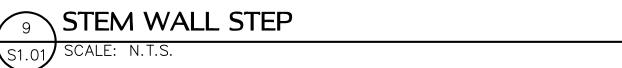




420 Osceola Avenue Jax. Beach, Florida 32250 Ph. 242-0908 Fax. 241-9557 FL: CA # 8344 SC: CA# 3579

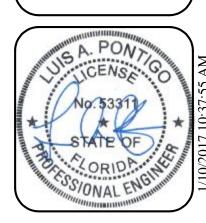

Luis A. Pontigo, PE FL PE#53311

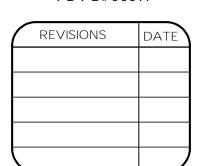

FIFLD ALTERATION CONSTRUCTION DOCUMENTS. AN


PONTIGO & ASSOCIATES PRIOR TO MAKING ANY STRUCTURAL FIELD MODIFICATIONS WHICH MAY VAR FROM THE INTENT OF THE ORIGINA BEING APPROVED BY LOU PONTIGO ASSOCIATES MAY RESULT IN ADDITIONAL ENGINEERING OR INSPECTION FEES.

FOUNDATION **DETAILS**

UNCLEAR REFER TO THE ARCHITECTURAL DRAWINGS O CONTACT THE E.O.R.

PLAN NAME SPEC HOME DESIGN/DRAWN/CHECKED CS / KM /LAP 01.10.17 SCALE AS NOTED LPA No. DRBD-16-01052 CONTROL No. 5774 SHEET

SHEET 5 OF 9

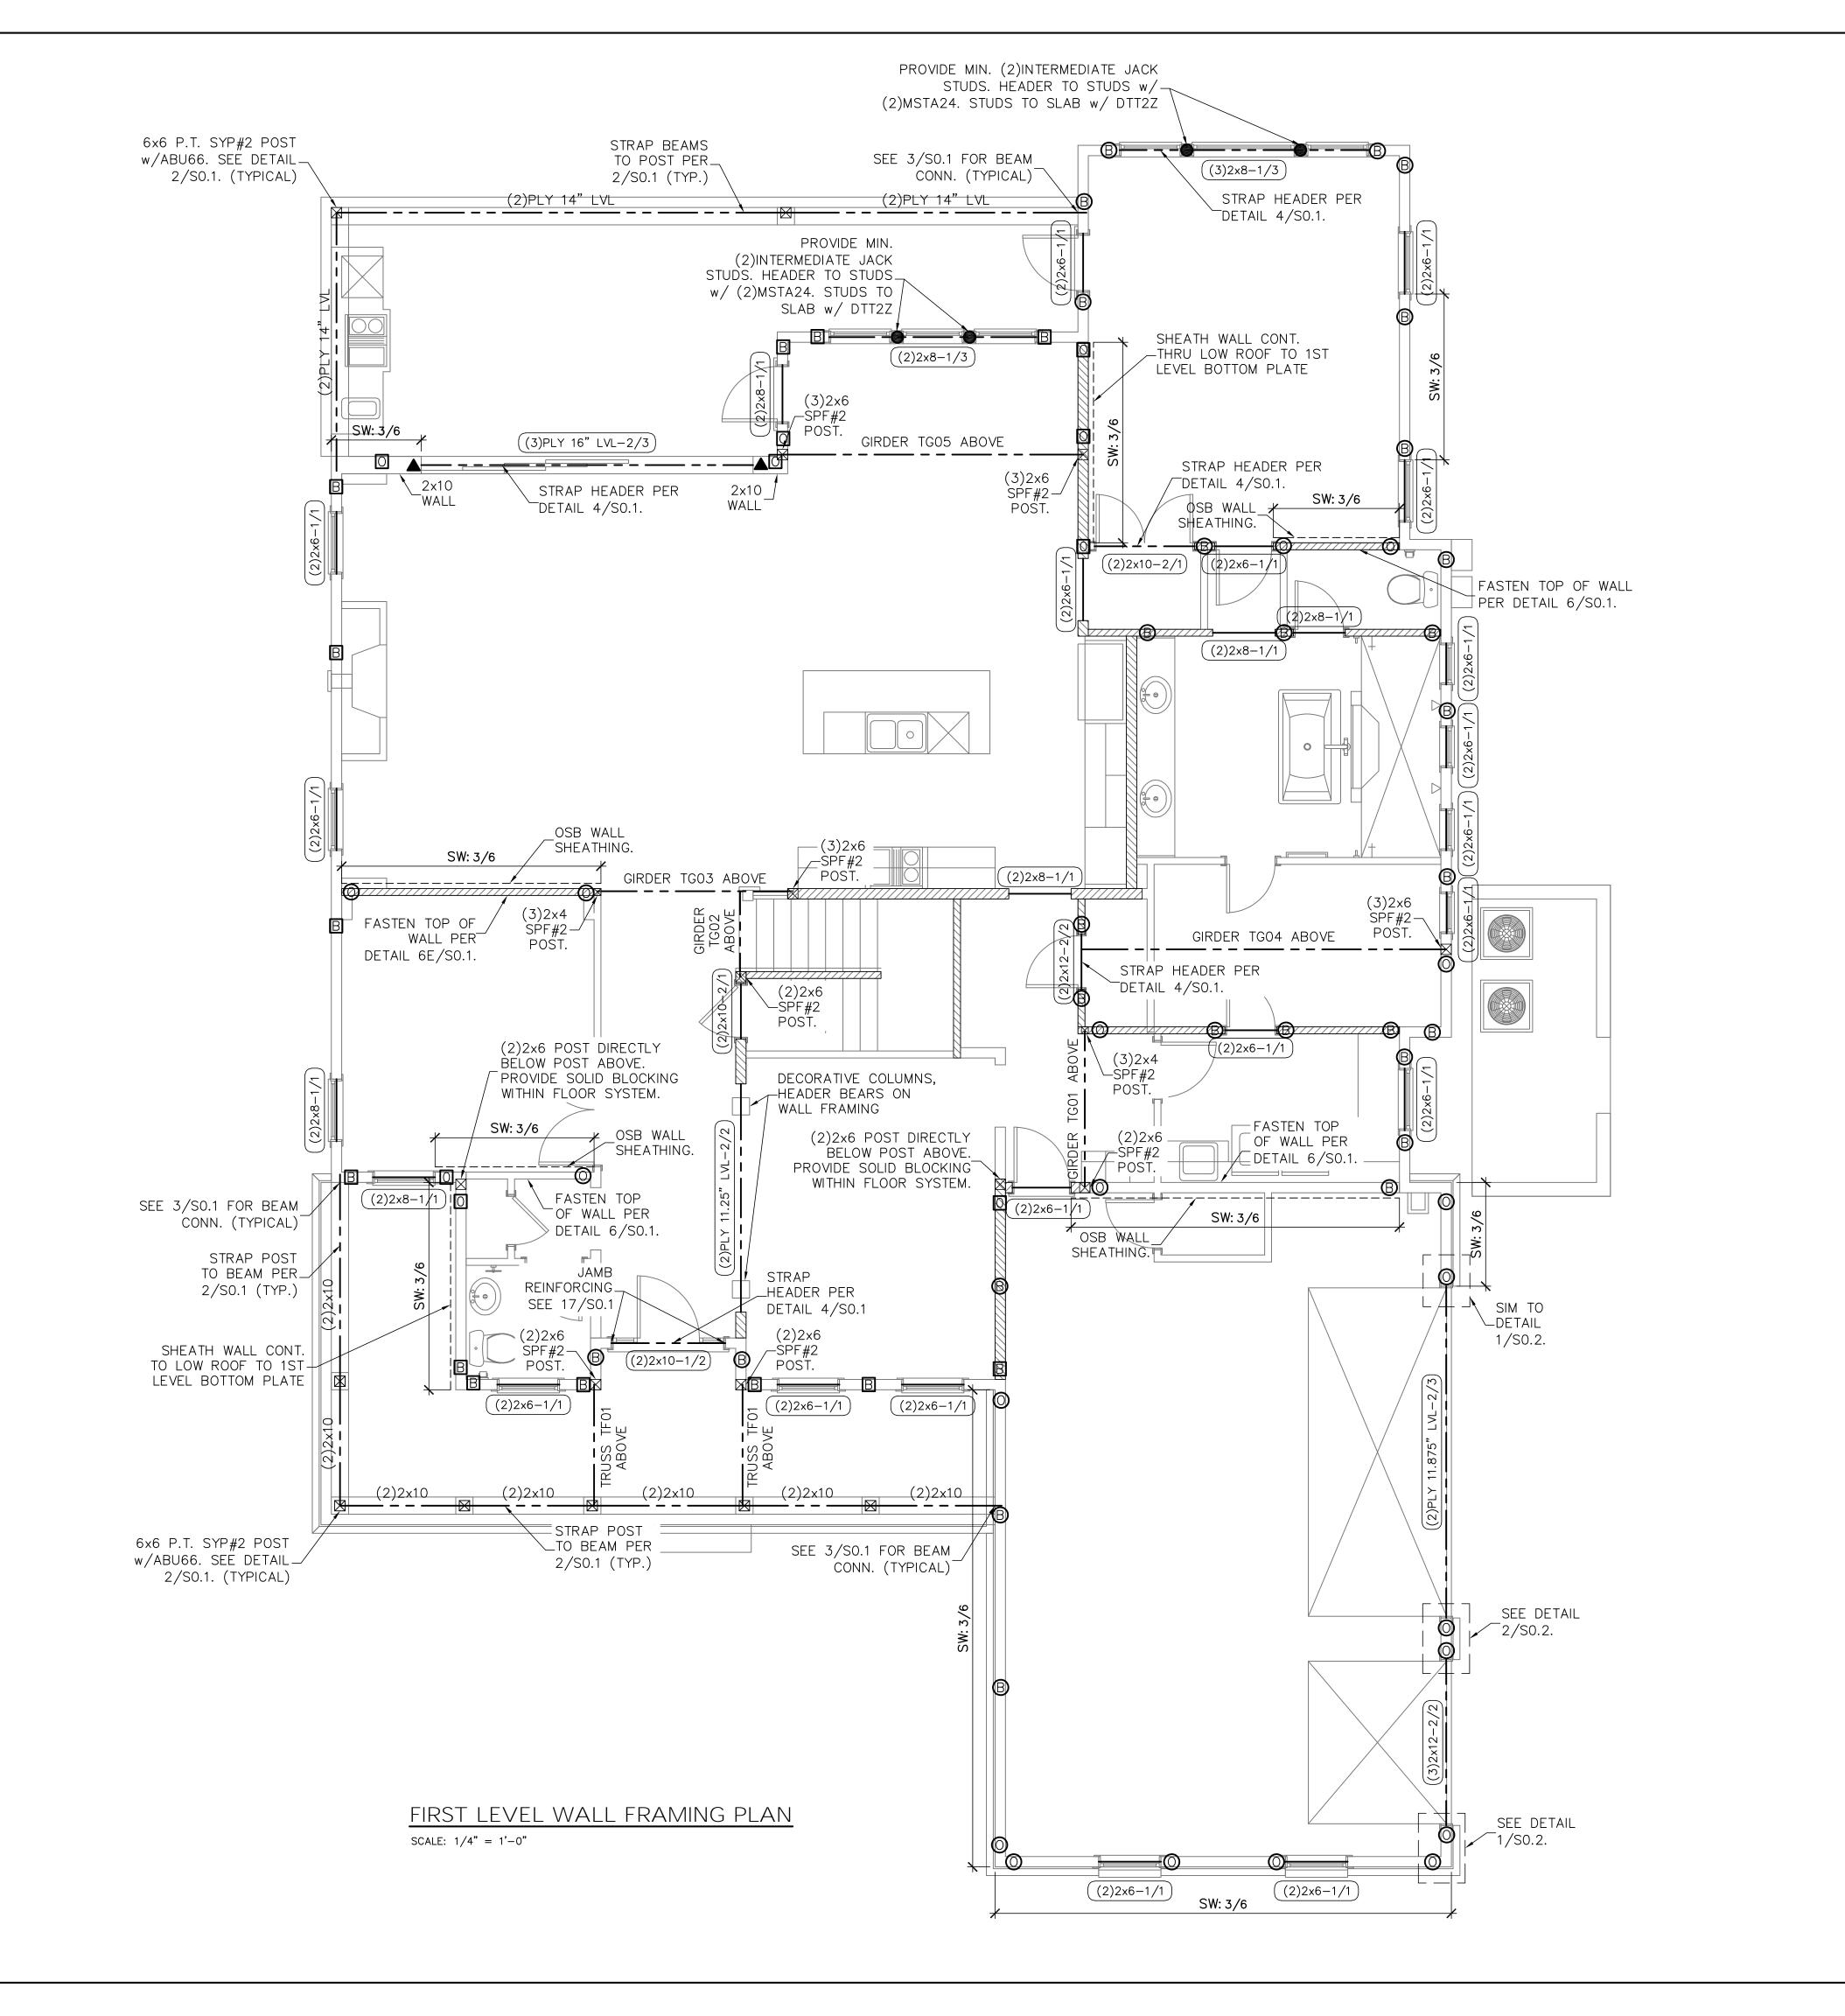

DESIGNATES SHEARWALL. THE HIDDEN LINE DESIGNATES SIDE OF WALL THE SHEARWALL SHEATHING TO BE APPLIED

8d @ \$ DESIGNATES 8d COMMONS @ 3" O.C. EDGE & 6" O.C. "IN THE FIELD."

DESIGNATES THE HEADER SIZE, NUMBER OF PLY'S & JACK/KING STUDS.

BEAM OR TRUSS, SEE PLAN. DTT2Z w/ $\frac{1}{2}$ " THREADED ROD EPOXIED 4".

QUICK-TIE LEGEND

B SHAPE DEFINES NUMBER OF STORIES

LETTER DEFINES DIAMETER OF Q.T. WIRE ROPE

SHAPES: ONE STORY QUICK TIE TWO STORY QUICK TIE

THREE STORY QUICK TIE FOUR STORY QUICK TIE

LETTER: B ¾6" Ø QUICK TIE G ¼" ø QUICK TIE

O 5/6" Ø QUICK TIE

WALL STUD SCHEDULE STUD SIZE & SPACING PLATE HEIGHT 2x4 SPF#2 @ 16" O.C. EXTERIOR 2x6 SPF#2 @ 16" O.C. <u>or</u> 2x4 SPF#2 @ 12" O.C. 2x6 SPF#2 @ 16" O.C. 2x4 SPF#2 @ 16" O.C. INTERIOR 2x6 SPF#2 @ 16" O.C. <u>or</u> 2x4 SPF#2 @ 12" O.C.

.) WALL STUDS SPECIFIED ON PLAN SUPERSEDE THIS TABLE 2.) MINIMUM STUD SIZE AND SPACING ARE SHOWN. CONTRACTOR MAY INCREASE STUD SIZE TO MEET ARCHITECTURAL REQUIREMENTS.

3.) SPF DENOTES SPRUCE PINE FIR.. SYP DENOTES SOUTHERN

4.) USE SYP#2 FOR ALL TOP PLATES AND SOLE PLATES. 5.) FASTEN BOTTOM PLATE OF INTERIOR LOAD BEARING WALLS TO CONCRETE SLAB w/16d MASONRY CUT NAILS @ 16" O.C. MINIMUM. SEE FOUNDATION PLAN FOR ADDITIONAL ANCHORS AT

GENERAL NOTES

1. SEE DETAIL 2/SO.O FOR WALL FRAMING DETAIL. SEE WALL STUD SCHEDULE THIS SHEET FOR STUD SIZES AND SPACING. AT GIRDERS AND BEAMS, PROVIDE STUDS BELOW TO MATCH BEAM/GIRDER

2. SEE SHEET SO.O FOR ROOF AND FLOOR SHEATHING SPECIFICATIONS.

3. WHERE FRAMING MEMBERS CONSIST OF MULTIPLE PLIES (BEAMS, HEADER, AND STUDS) FASTEN PLIES TOGETHER PER DETAIL 6/SO.0

4. INSTALL SOLE PLATE ANCHORS PER DETAIL 2/S0.0

6. AT SHEARWALLS, PROVIDE DIAPHRAGM ATTACHMENT PER DETAIL 6 & 7/SO.1

8. FOR ATTACHMENT OF EXTERIOR WALLS THAT TERMINATE BETWEEN TRUSSES, SEE 6A/SO.1

9. AT PORCHES, SEE DETAIL 2/S0.1 FOR FRAMING AND HOLD DOWNS

Lou Pontigo and Associates, Inc.

420 Osceola Avenue Jax. Beach, Florida 32250 Ph. 242-0908 Fax. 241-9557 FL: CA # 8344 SC: CA# 3579



Luis A. Pontigo, PE FL PE#53311

_		
	REVISIONS	DATE
ackslash		

FIFLD ALTERATION

PONTIGO & ASSOCIATES PRIOR TO MAKING ANY STRUCTURAL FIELD MODIFICATIONS WHICH MAY VAR ROM THE INTENT OF THE ORIGINA CONSTRUCTION DOCUMENTS. AN' ELD ALTERNATIONS MADE PRIOR BEING APPROVED BY LOU PONTIGO ADDITIONAL ENGINEERING OR INSPECTION FEES.

> \sim B

IST FLOOR FRAMING PLAN


DO NOT SCALE DIMENSIONS FROM HESE DRAWINGS. IF A DIMENSION UNCLEAR REFER TO THE ARCHITECTURAL DRAWINGS O CONTACT THE E.O.R.

PLAN NAME SPEC HOME DESIGN/DRAWN/CHECKED CS / KM /LAP 01.10.17

SCALE AS NOTED LPA No. DRBD-16-01052

CONTROL No. 5774 SHEET

S1.1 SHEET 6 OF 9

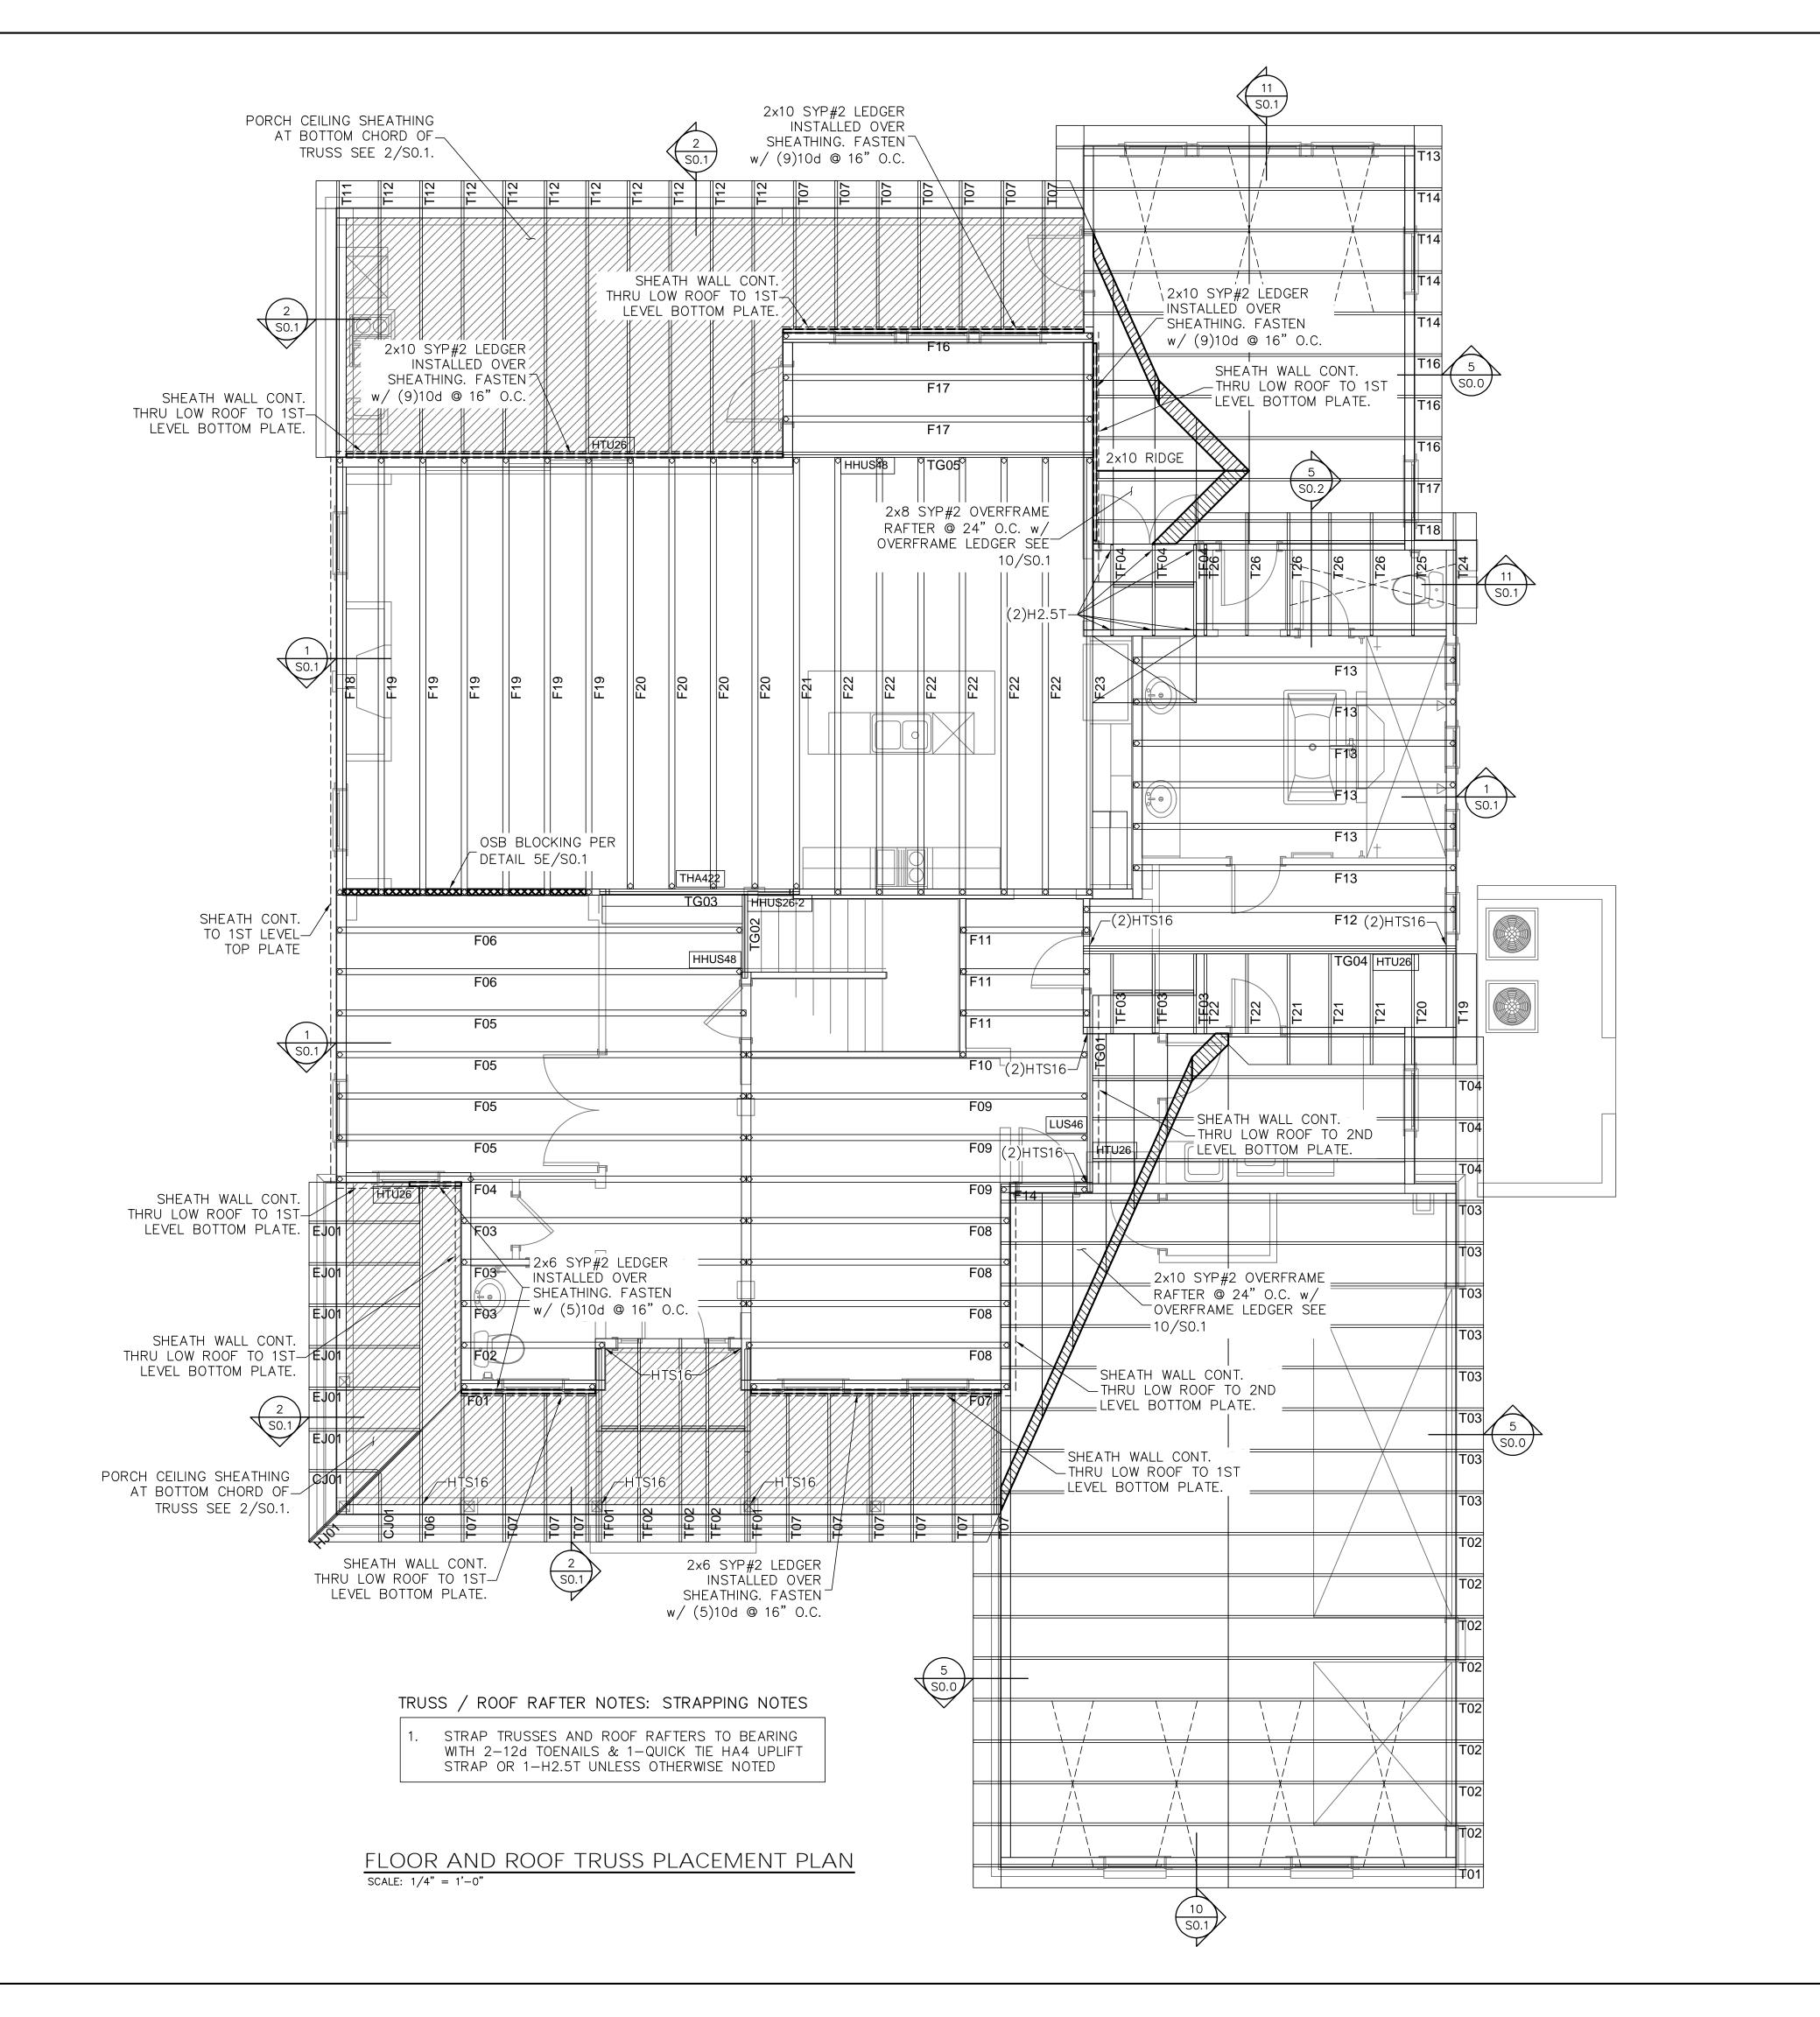

DESIGNATES UPLIFT CONNECTION.

FRAMING PLAN NOTES: 1. FOR TYPICAL ROOF SHEATHING AND FRAMING, SEE

- SHEET SO.O. FOR SPECIFIC UPLIFT CONNECTORS, SEE PLAN. MIN.
- (1)HA4 CONNECTOR.

 FOR GENERAL DESIGN SPECIFICATIONS SEE SHEET SO.O.

 FOR TRUSS UPLIFTS UP TO 2200 LBS., CONTRACTOR MAY FASTEN TRUSS TO THE FOUNDATION W/ QGT W/QT PER MANUFACTURER'S SPECIFICATIONS.
- WHEN USING (2)HA4 CLIPS ON 11/2" WIDE LUMBER, PLACE CLIPS DIAGONALLY ACROSS DOUBLE TOP PLATE FROM EACH OTHER.



Lou Pontigo and Associates, Inc.

420 Osceola Avenue Jax. Beach, Florida 32250 Ph. 242-0908 Fax. 241-9557 FL: CA # 8344 SC: CA# 3579



Luis A. Pontigo, PE FL PE#53311

REVISIONS

FIFLD ALTERATION

CONTRACTOR SHALL CONTACT LOL PONTIGO & ASSOCIATES PRIOR TO MAKING ANY STRUCTURAL FIELD MODIFICATIONS WHICH MAY VAR' FROM THE INTENT OF THE ORIGINAL CONSTRUCTION DOCUMENTS. AN' FIELD ALTERNATIONS MADE PRIOR T BEING APPROVED BY LOU PONTIGO ASSOCIATES MAY RESULT IN ADDITIONAL ENGINEERING OR INSPECTION FEES.

B

FLOOR AND ROOF TRUSS **PLACEMENT** PLAN

DO NOT SCALE DIMENSIONS FROM HESE DRAWINGS. IF A DIMENSION UNCLEAR REFER TO THE ARCHITECTURAL DRAWINGS OF CONTACT THE E.O.R.


PLAN NAME SPEC HOME DESIGN/DRAWN/CHECKED CS / KM /LAP

01.10.17 SCALE AS NOTED LPA No.

DRBD-16-01052 CONTROL No.

5774 SHEET

SHEET 7 OF 9

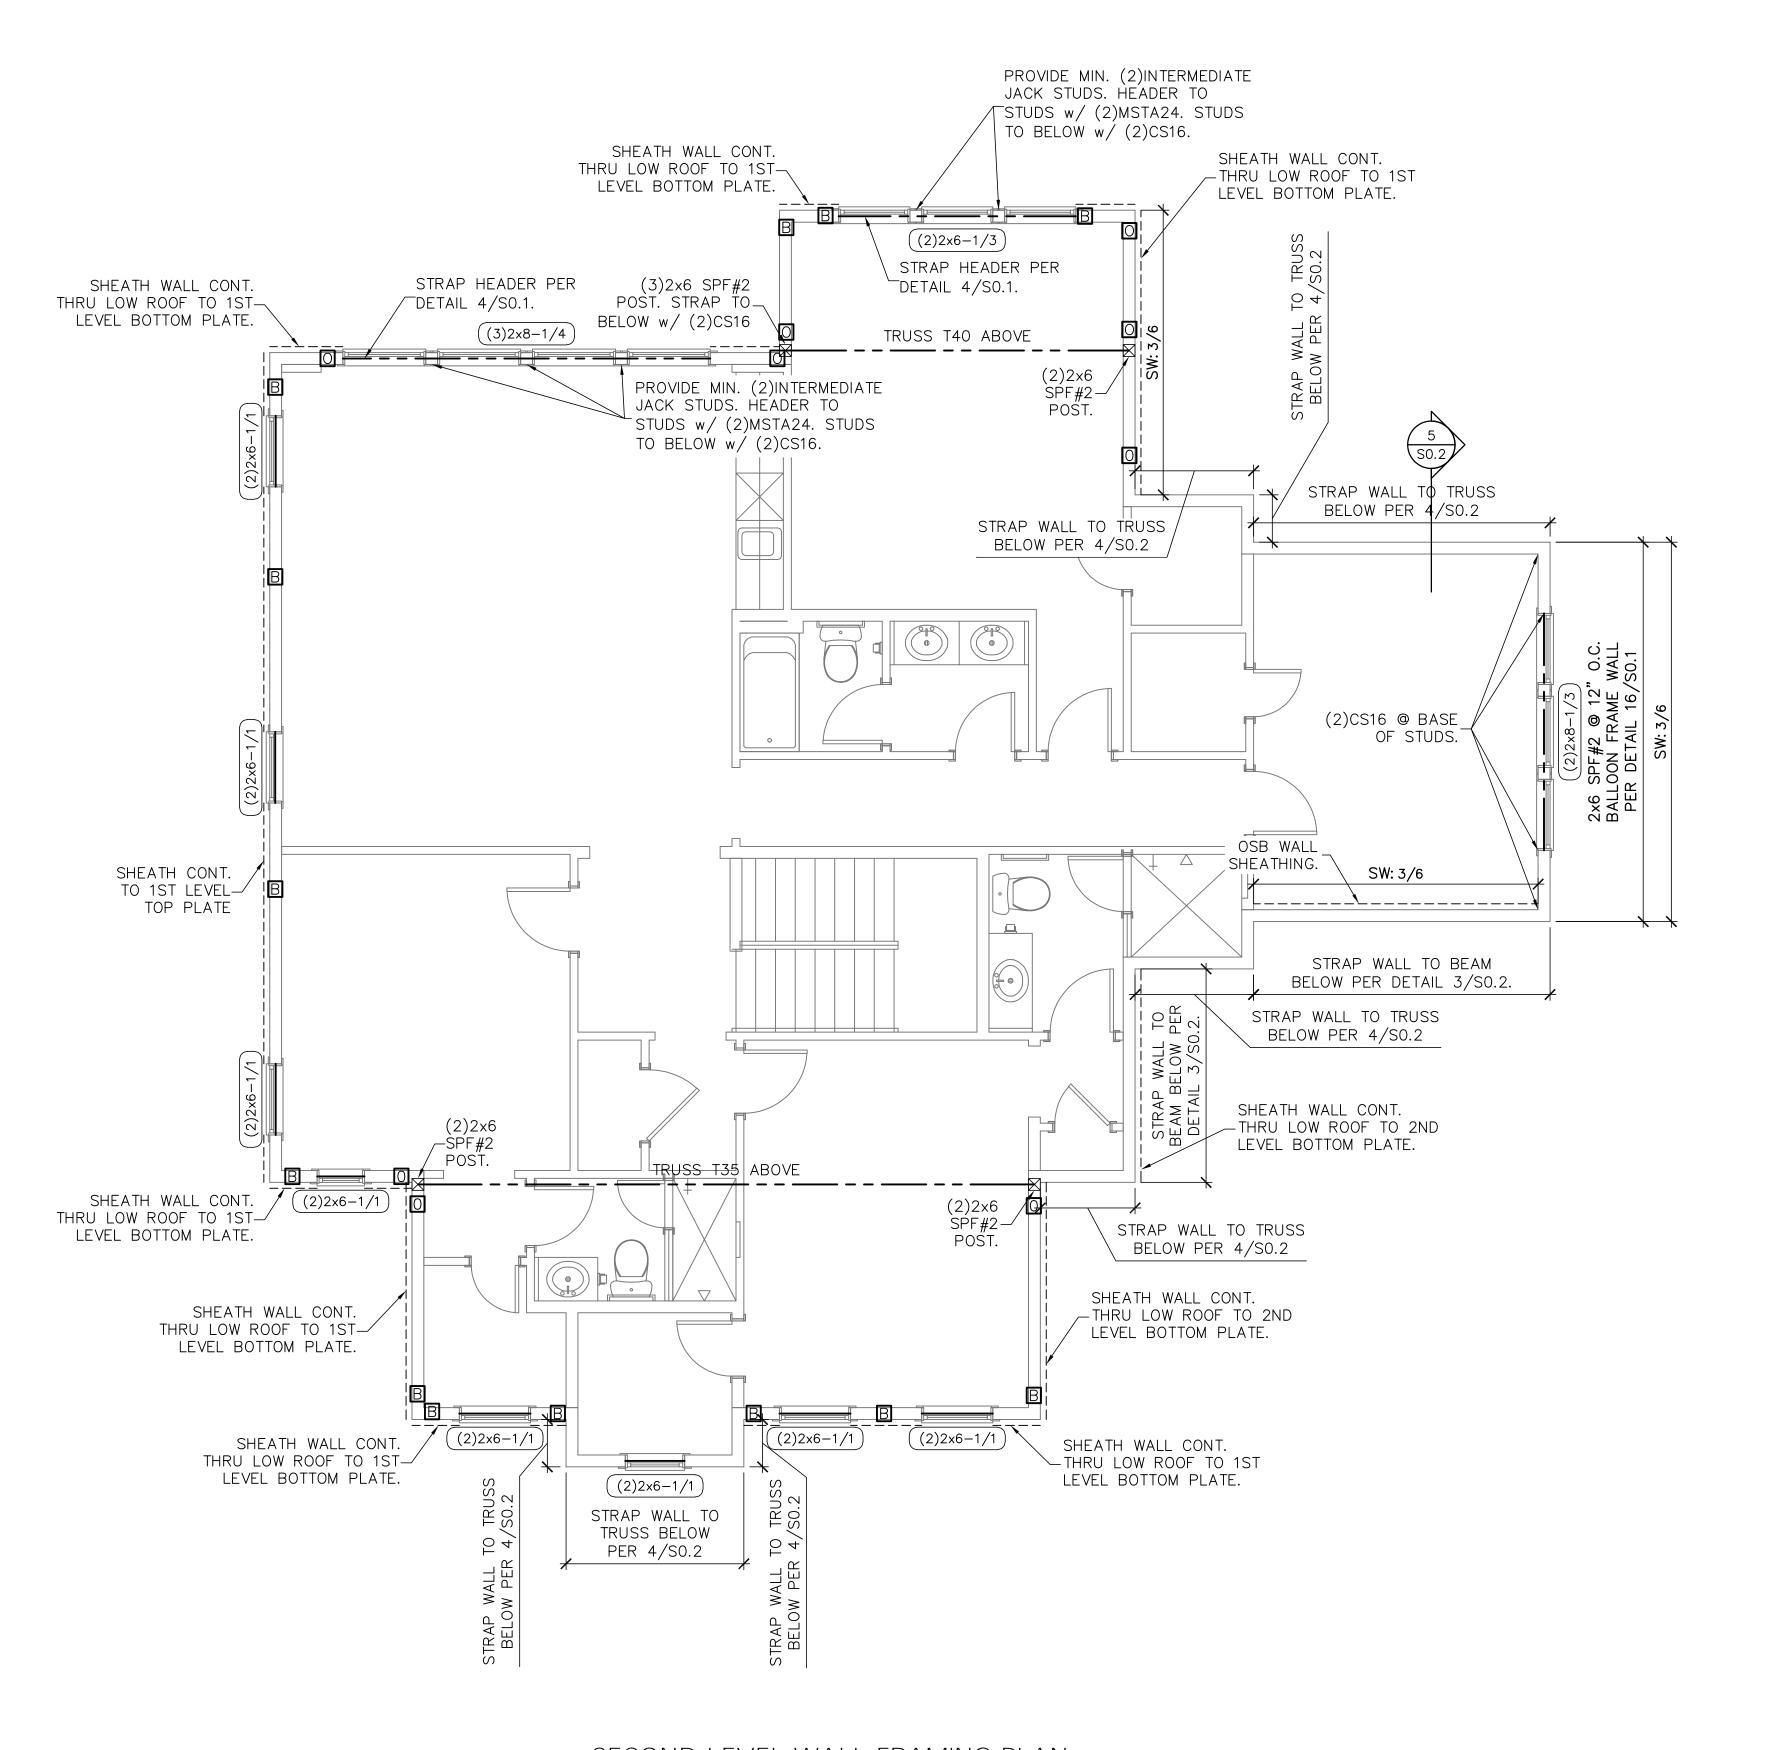

SECOND LEVEL WALL FRAMING PLAN SCALE: 1/4" = 1'-0"

DESIGNATES SHEARWALL. THE HIDDEN SW: 3/6 LINE DESIGNATES SIDE OF WALL THE SHEARWALL SHEATHING TO BE APPLIED 8d @ \$ DESIGNATES 8d COMMONS @ 3" O.C. EDGE & 6" O.C. "IN THE FIELD."

(2)2×8-1/2 DESIGNATES THE HEADER SIZE, NUMBER OF PLY'S & JACK/KING STUDS.

BEAM OR TRUSS, SEE PLAN.

DTT2Z w/ ½" THREADED ROD EPOXIED 4".



QUICK-TIE LEGEND

B SHAPE DEFINES NUMBER OF STORIES LETTER DEFINES DIAMETER

OF Q.T. WIRE ROPE SHAPES: ONE STORY QUICK TIE TWO STORY QUICK TIE

> THREE STORY QUICK TIE FOUR STORY QUICK TIE

LETTER: B 3/6" Ø QUICK TIE G ¼" ø QUICK TIE O 5/6" Ø QUICK TIE

WALL STUD SCHEDULE							
EXTERIOR	PLATE HEIGHT	STUD SIZE & SPACING					
EXTERIOR	9'-1" MAX	2x4 SPF#2 @ 16" O.C.					
EXTERIOR	10'-1 MAX	2x6 SPF#2 @ 16" O.C. <u>o</u> 2x4 SPF#2 @ 12" O.C.					
INTERIOR	10'-1 TO 14'-0"	2x6 SPF#2 @ 16" O.C.					
INTERIOR	10'-0" MAX	2x4 SPF#2 @ 16" O.C.					
STUD NOTES:	12'-0" MAX	2x6 SPF#2 @ 16" O.C. o 2x4 SPF#2 @ 12" O.C.					
	EXTERIOR EXTERIOR EXTERIOR INTERIOR INTERIOR	EXTERIOR PLATE HEIGHT EXTERIOR 9'-1" MAX 10'-1 MAX INTERIOR 10'-1 TO 14'-0" INTERIOR 10'-0" MAX 12'-0"					

) WALL STUDS SPECIFIED ON PLAN SUPERSEDE THIS TABLE 2.) MINIMUM STUD SIZE AND SPACING ARE SHOWN. CONTRACTOR MAY INCREASE STUD SIZE TO MEET ARCHITECTURAL REQUIREMENTS.

3.) SPF DENOTES SPRUCE PINE FIR.. SYP DENOTES SOUTHERN YELLOW PINE.

4.) USE SYP#2 FOR ALL TOP PLATES AND SOLE PLATES. 5.) FASTEN BOTTOM PLATE OF INTERIOR LOAD BEARING WALLS TO CONCRETE SLAB w/16d MASONRY CUT NAILS @ 16" O.C. MINIMUM. SEE FOUNDATION PLAN FOR ADDITIONAL ANCHORS A SHEARWALLS

GENERAL NOTES

. SEE DETAIL 2/SO.O FOR WALL FRAMING DETAIL SEE WALL STUD SCHEDULE THIS SHEET FOR STUD SIZES AND SPACING. AT GIRDERS AND BEAMS, PROVIDE STUDS BELOW TO MATCH BEAM/GIRDER

2. SEE SHEET SO.O FOR ROOF AND FLOOR SHEATHING SPECIFICATIONS. 3. WHERE FRAMING MEMBERS CONSIST OF MULTIPLE

PLIES (BEAMS, HEADER, AND STUDS) FASTEN PLIES TOGETHER PER DETAIL 6/SO.0 4. INSTALL SOLE PLATE ANCHORS PER DETAIL

6. AT SHEARWALLS, PROVIDE DIAPHRAGM ATTACHMENT PER DETAIL 6 & 7/SO.1

8. FOR ATTACHMENT OF EXTERIOR WALLS THAT TERMINATE BETWEEN TRUSSES, SEE 6A/SO.1

9. AT PORCHES, SEE DETAIL 2/SO.1 FOR FRAMING AND HOLD DOWNS

Lou Pontigo and

Associates, Inc.

420 Osceola Avenue Jax. Beach, Florida 32250 Ph. 242-0908 Fax. 241-9557 FL: CA # 8344 SC: CA# 3579



Luis A. Pontigo, PE FL PE#53311

_		
	REVISIONS	DATE
		丿

FIFLD ALTERATION PONTIGO & ASSOCIATES PRIOR TO MAKING ANY STRUCTURAL FIELD MODIFICATIONS WHICH MAY VAR'

FROM THE INTENT OF THE ORIGINA CONSTRUCTION DOCUMENTS. AN' BEING APPROVED BY LOU PONTIGO ADDITIONAL ENGINEERING OR INSPECTION FEES.

Ш \sim B

2nd FLOOR **FRAMING** PLAN

DO NOT SCALE DIMENSIONS FROM THESE DRAWINGS. IF A DIMENSION UNCLEAR REFER TO THE ARCHITECTURAL DRAWINGS OF CONTACT THE E.O.R.

PLAN NAME SPEC HOME DESIGN/DRAWN/CHECKED CS / KM /LAP 01.10.17

SCALE AS NOTED LPA No. DRBD-16-01052

CONTROL No. 5774 SHEET

SHEET 8 OF 9

- SHEET SO.O.
 FOR SPECIFIC UPLIFT CONNECTORS, SEE PLAN. MIN.
- FOR SPECIFIC UPLIFT CONNECTORS, SEE PLAN. MIN.

 (1)HA4 CONNECTOR.

 FOR GENERAL DESIGN SPECIFICATIONS SEE SHEET SO.O.
 FOR TRUSS UPLIFTS UP TO 2200 LBS., CONTRACTOR MAY FASTEN TRUSS TO THE FOUNDATION w/ QGT w/QT PER MANUFACTURER'S SPECIFICATIONS.
 WHEN USING (2)HA4 CLIPS ON 1½" WDE LUMBER, PLACE CLIPS DIAGONALLY ACROSS DOUBLE TOP PLATE FROM EACH OTHER.

420 Osceola Avenue Jax. Beach, Florida 32250 Ph. 242-0908 Fax. 241-9557 FL: CA # 8344 SC: CA# 3579



Lou Pontigo and Associates, Inc.

Luis A. Pontigo, PE FL PE#53311

REVISIONS

FIELD ALTERATION

CONTRACTOR SHALL CONTACT LOU PONTIGO & ASSOCIATES PRIOR TO MAKING ANY STRUCTURAL FIELD MODIFICATIONS WHICH MAY VARY FROM THE INTENT OF THE ORIGINAL CONSTRUCTION DOCUMENTS. ANY FIELD ALTERNATIONS MADE PRIOR TO BEING APPROVED BY LOU PONTIGO & ASSOCIATES MAY RESULT IN ADDITIONAL ENGINEERING OR INSPECTION FEES.

TRUSS PLACEMENT PLAN


DO NOT SCALE DIMENSIONS FROM THESE DRAWINGS. IF A DIMENSION IS UNCLEAR REFER TO THE ARCHITECTURAL DRAWINGS OR CONTACT THE E.O.R.

PLAN NAME SPEC HOME DESIGN/DRAWN/CHECKED CS / KM /LAP

01.10.17 SCALE AS NOTED

DRBD-16-01052 CONTROL No. 5774

SHEET SHEET 9 OF 9

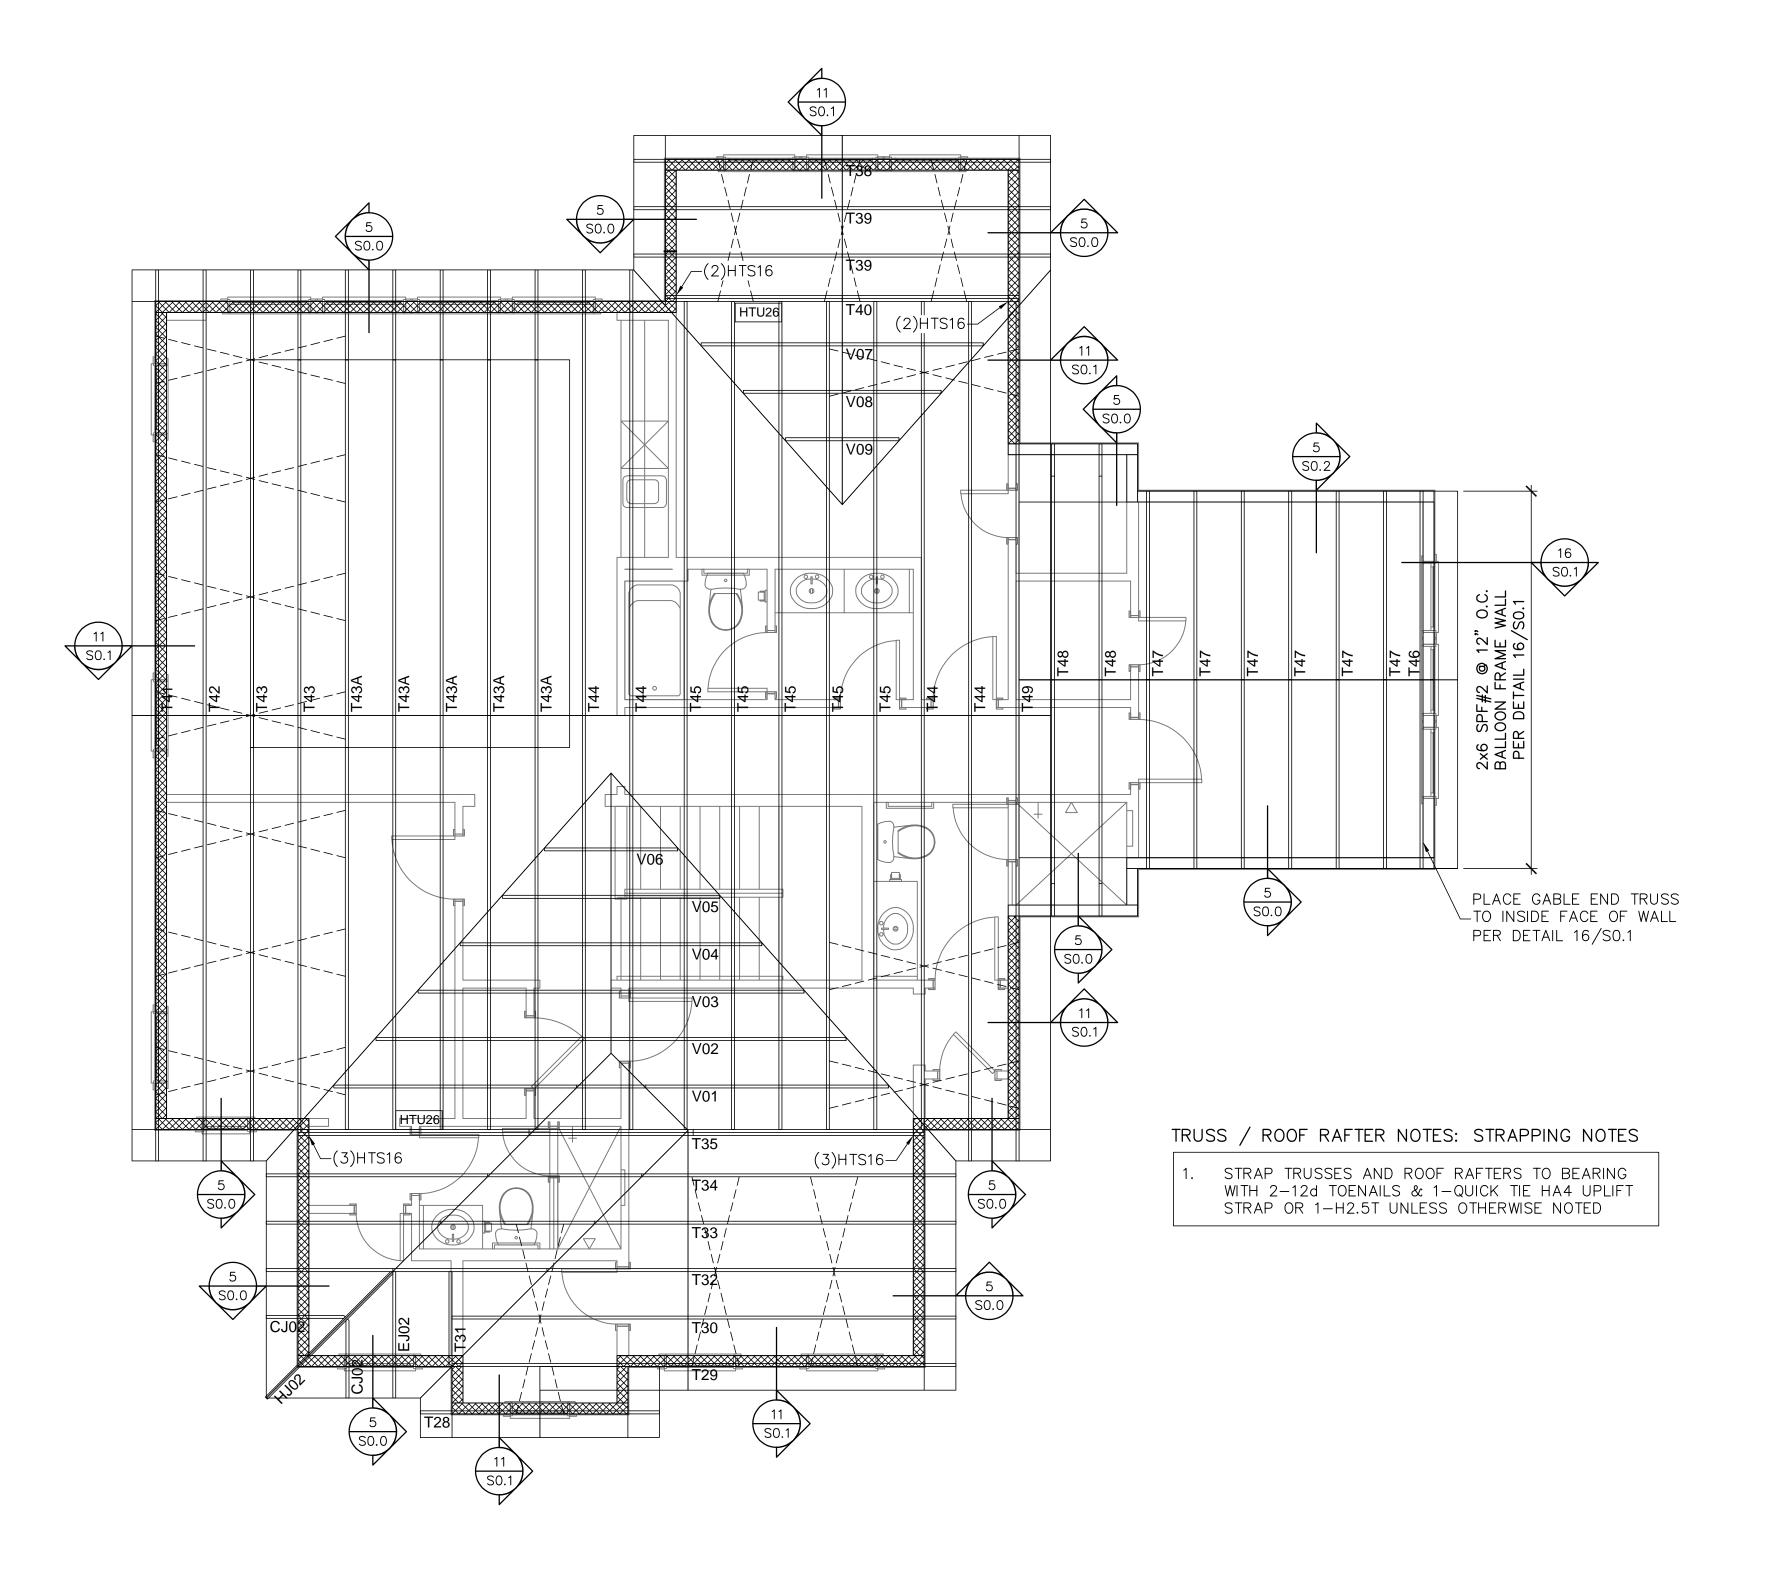

ROOF TRUSS PLACEMENT PLAN SCALE: 1/4" = 1'-0"